





IF THIS SHEET IS NOT 30"x42", IT IS A REDUCED PRINT SCALE ACCORDINGLY

**ABBREVIATIONS**

**SYMBOLS**

&	AND	S	SOUTH
@	AT	SC	SOLID CORE
Ø	CENTERLINE	SCD	SEE CIVIL DRAWINGS
Ø	DIAMETER	SCHED	SCHEDULE
#	POUND OR NUMBER	SD	SOAP DISPENSER
A/C	AIR CONDITIONING	SED	SEE ELECTRICAL DRAWINGS
AC	ASPHALTIC CONCRETE	SF	SQUARE FEET
ACOUS	ACOUSTICAL	SFPD	SEE FIRE PROTECTION DRAWINGS
ACT	ACOUSTIC CEILING TILE	SHT	SHEET
ADD	ADDITIONAL	SM	SMILAR
ADJ	ADJACENT	SLD	SEE LANDSCAPE DRAWINGS
AFF	ABOVE FINISHED FLOOR	SMD	SEE MECHANICAL DRAWINGS
ALT	ALTERNATE	SMS	SHEET METAL SCREW
ALUM	ALUMINUM	SND	SANITARY NAPKIN DISPENSER
ANOD	ANODIZED	SPD	SEE PLUMBING DRAWINGS
APPROX	APPROXIMATE	SPEC	SPECIFICATION
ARCH	ARCHITECTURAL	SQ	SQUARE
BITUM	BITUMINOUS	SS	STAINLESS STEEL
BD	BOARD	SSD	SEE STRUCTURAL DRAWINGS
BLDG	BUILDING	STD	STANDARD
BLKG	BLOCKING	STL	STEEL
BOT	BOTTOM	STOR	STORAGE
BTWN	BETWEEN	STRUCT	STRUCTURAL
BUR	BUILT-UP ROOFING	SUSP	SUSPEND
CAB	CABINET	TEL	TELEPHONE
CB	CATCH BASIN	TEMP	TEMPORARY
CFCI	CONTRACTOR FURNISHED CONTRACTOR INSTALLED	THK	THICK
CG	CORNER GUARD	T.O.	TOP OF
CJ	CONTROL JOINT	TOC	TOP OF CURB
CLG	CEILING	TOP	TOP OF PARAPET
CLO	CLOSET	TOS	TOP OF SLAB
CLR	CLEAR	TOW	TOP OF WALL
CMU	CONCRETE MASONRY UNIT	TPD	TOILET PAPER DISPENSER
CO	CLEAN OUT	TV	TELEVISION
COL	COLUMN	TYP	TYPICAL
COMP	COMPOSITION	UON	UNLESS OTHERWISE NOTED
CONC	CONCRETE	VCT	VINYL COMPOSITION TILE
CONST	CONSTRUCTION	VERT	VERTICAL
CONT	CONTINUOUS	VEST	VESTIBULE
CORR	CORRIDOR	VIF	VERIFY IN FIELD
CT	CERAMIC TILE	W	WEST
CUST	CUSTODIAN	w	WITH
DBL	DOUBLE	W/O	WITHOUT
DEMO	DEMOLITION	WC	WATER CLOSET
DEPT	DEPARTMENT	WD	WOOD
DF	DRINKING FOUNTAIN	WH	WATER HEATER
DI	DRAIN OR DROP INLET		
DIA	DIAMETER		
DIAG	DIAGONAL		
DM	DIMENSION		
DISP	DISPENSER		
DIV	DIVISION		
DN	DOWN		
DS	DOWNSPOUT		
DTL	DETAIL		
DW	DISHWASHER		
DWG	DRAWING		
(E)	EXISTING		
E	EAST		
EA	EACH		
EF	EXHAUST FAN		
EJ	EXPANSION JOINT		
EL	ELEVATION		
ELEC	ELECTRICAL		
ELEV	ELEVATOR		
ENCL	ENCLOSURE		
EQ	EQUAL		
EQUIP	EQUIPMENT		
EVA	EMERGENCY VEHICLE ACCESS		
EWC	ELECTRICAL WATER COOLER		
EXP	EXPANSION		
EXT	EXTERIOR		
FA	FIRE ALARM		
FD	FLOOR DRAIN		
FE	FIRE EXTINGUISHER		
FEC	FIRE EXTINGUISHER CABINET		
FF	FINISH FLOOR		
FN	FINISH		
FLR	FLOOR		
FOC	FACE OF CONCRETE		
FOF	FACE OF FINISH		
FOS	FACE OF STUD		
FRP	FIBERGLASS REINFORCED PANEL		
FT	FOOT OR FEET		
FTG	FOOTING		
GA	GAUGE		
GALV	GALVANIZED		
GB	GRAB BAR		
GSM	GALVANIZED WHEET METAL		
GYP	GYPNUM		
HB	HOSE BIB		
HC	HOLLOW CORE		
HD	HEAD		
HDWR	HARDWARE		
HM	HOLLOW METAL		
HORIZ	HORIZONTAL		
HR	HOUR		
HT	HEIGHT		
INFO	INFORMATION		
INSUL	INSULATION		
INT	INTERIOR		
JAN	JANITOR		
JT	JOINT		
LAB	LABORATORY		
LAM	LAMINATE		
LAV	LAVATORY		
LBS	POUNDS		
LT	LIGHT		
MAX	MAXIMUM		
MB	MACHINE BOLT		
MDF	MEDIUM DENSITY FIREBOARD		
MECH	MECHANICAL		
MFR	MANUFACTURER		
MH	MANHOLE		
MIN	MINIMUM		
MISC	MISCELLANEOUS		
MOD	MODULAR		
MTD	MOUNTED		
MTG	MOUNTING		
MTL	METAL		
MUL	MULLION		
(N)	NEW		
N/A	NOT APPLICABLE		
N	NORTH		
NIC	NOT IN CONTRACT		
NO or #	NUMBER		
NOM	NOMINAL		
NTS	NOT TO SCALE		
O/	OVER		
OC	ON CENTER		
OFCI	OWNER FURNISHED CONTRACTOR INSTALLED		
OFPI	OWNER FURNISHED OWNER INSTALLED		
OPP	OPPOSITE		
PL	PLATE		
PLAM	PLASTIC LAMINATE		
PLAS	PLASTER		
PLYWD	PLYWOOD		
PR	PAIR		
PTD	PAPER TOWEL DISPENSER		
PVC	POLYVINYL CHLORIDE		
(R)	RELOCATE		
RB	RESILIENT OR RUBBER BASE		
RCP	REFLECTED CEILING PLAN		
RD	ROOF DRAIN		
REF	REFERENCE		
REFR	REFRIGERATOR		
REINP	REINFORCED		
REQ	REQUIRED		
RF	RESILIENT FLOORING		
RM	ROOM		
RO	ROUGH OPENING		
RWL	RAIN WATER LEADER		

	GRID LINE
	BUILDING ELEVATION — ELEVATION IDENTIFICATION — SHEET WHERE ELEVATION IS SHOWN
	BUILDING OR WALL SECTION — SECTION IDENTIFICATION — SHEET WHERE SECTION IS SHOWN
	DETAIL — DETAIL IDENTIFICATION — SHEET WHERE DETAIL IS SHOWN
	INTERIOR ELEVATION(S) — DETAIL NO. OF ELEVATION — NO ARROWS MEAN ELEVATION NOT SHOWN — SHEET WHERE ELEVATION IS SHOWN — ELEVATION IDENTIFICATION
	REVISIONS — WORK POINT, CONTROL POINT OR DATUM POINT — REVISION NUMBER, SEE REVISION SCHEDULE ON TITLE BLOCK — AREA OF REVISION
	ROOM IDENTIFICATION — ROOM NAME — KAISER ROOM CODE NAME — ROOM NUMBER — CEILING HEIGHT (OTHER THAN EXISTING OR 8'-0" A.F.F.) — 9'-0"
	KEYNOTE TAG REFER TO KEYNOTE LIST LOCATED ON PLAN SHEETS
	AREA OF NO WORK
	DOOR TAG (SEE DOOR SCHEDULE) — DOOR MARK — HARDWARE GROUP
	DOOR MARK
	(E) DOOR TO REMAIN
	(E) DOOR TO BE REMOVED
	(N) DOOR & DOOR FRAME
	WALL TAG — WALL TYPE - REFER TO DRAWING SHEET A9.01
	WINDOW TAG (SEE WINDOW SCHEDULE) — WINDOW MARK

**UC DAVIS HEALTH**  
FACILITIES DESIGN & CONSTRUCTION  
 4602 2ND STREET, SUITE 300  
 SACRAMENTO, CALIFORNIA 95817  
 916/754-7024

HY ARCHITECTS PROJECT #: 5839  
**HY** HIBSER YAMAUCHI Architects, Inc.  
 4602 2nd Street, Suite 3  
 Davis, CA 95618  
 530.758.1270 tel | 530.758.4789 fax

CONSULTANTS:  
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THIS ISSUE:	ISSUED FOR	Date

**APPROVED**  
 UC DAVIS HEALTH  
 BUILDING DEPARTMENT  
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 Paul R. Menard, AIA 07/27/2022 1:35:57 PM

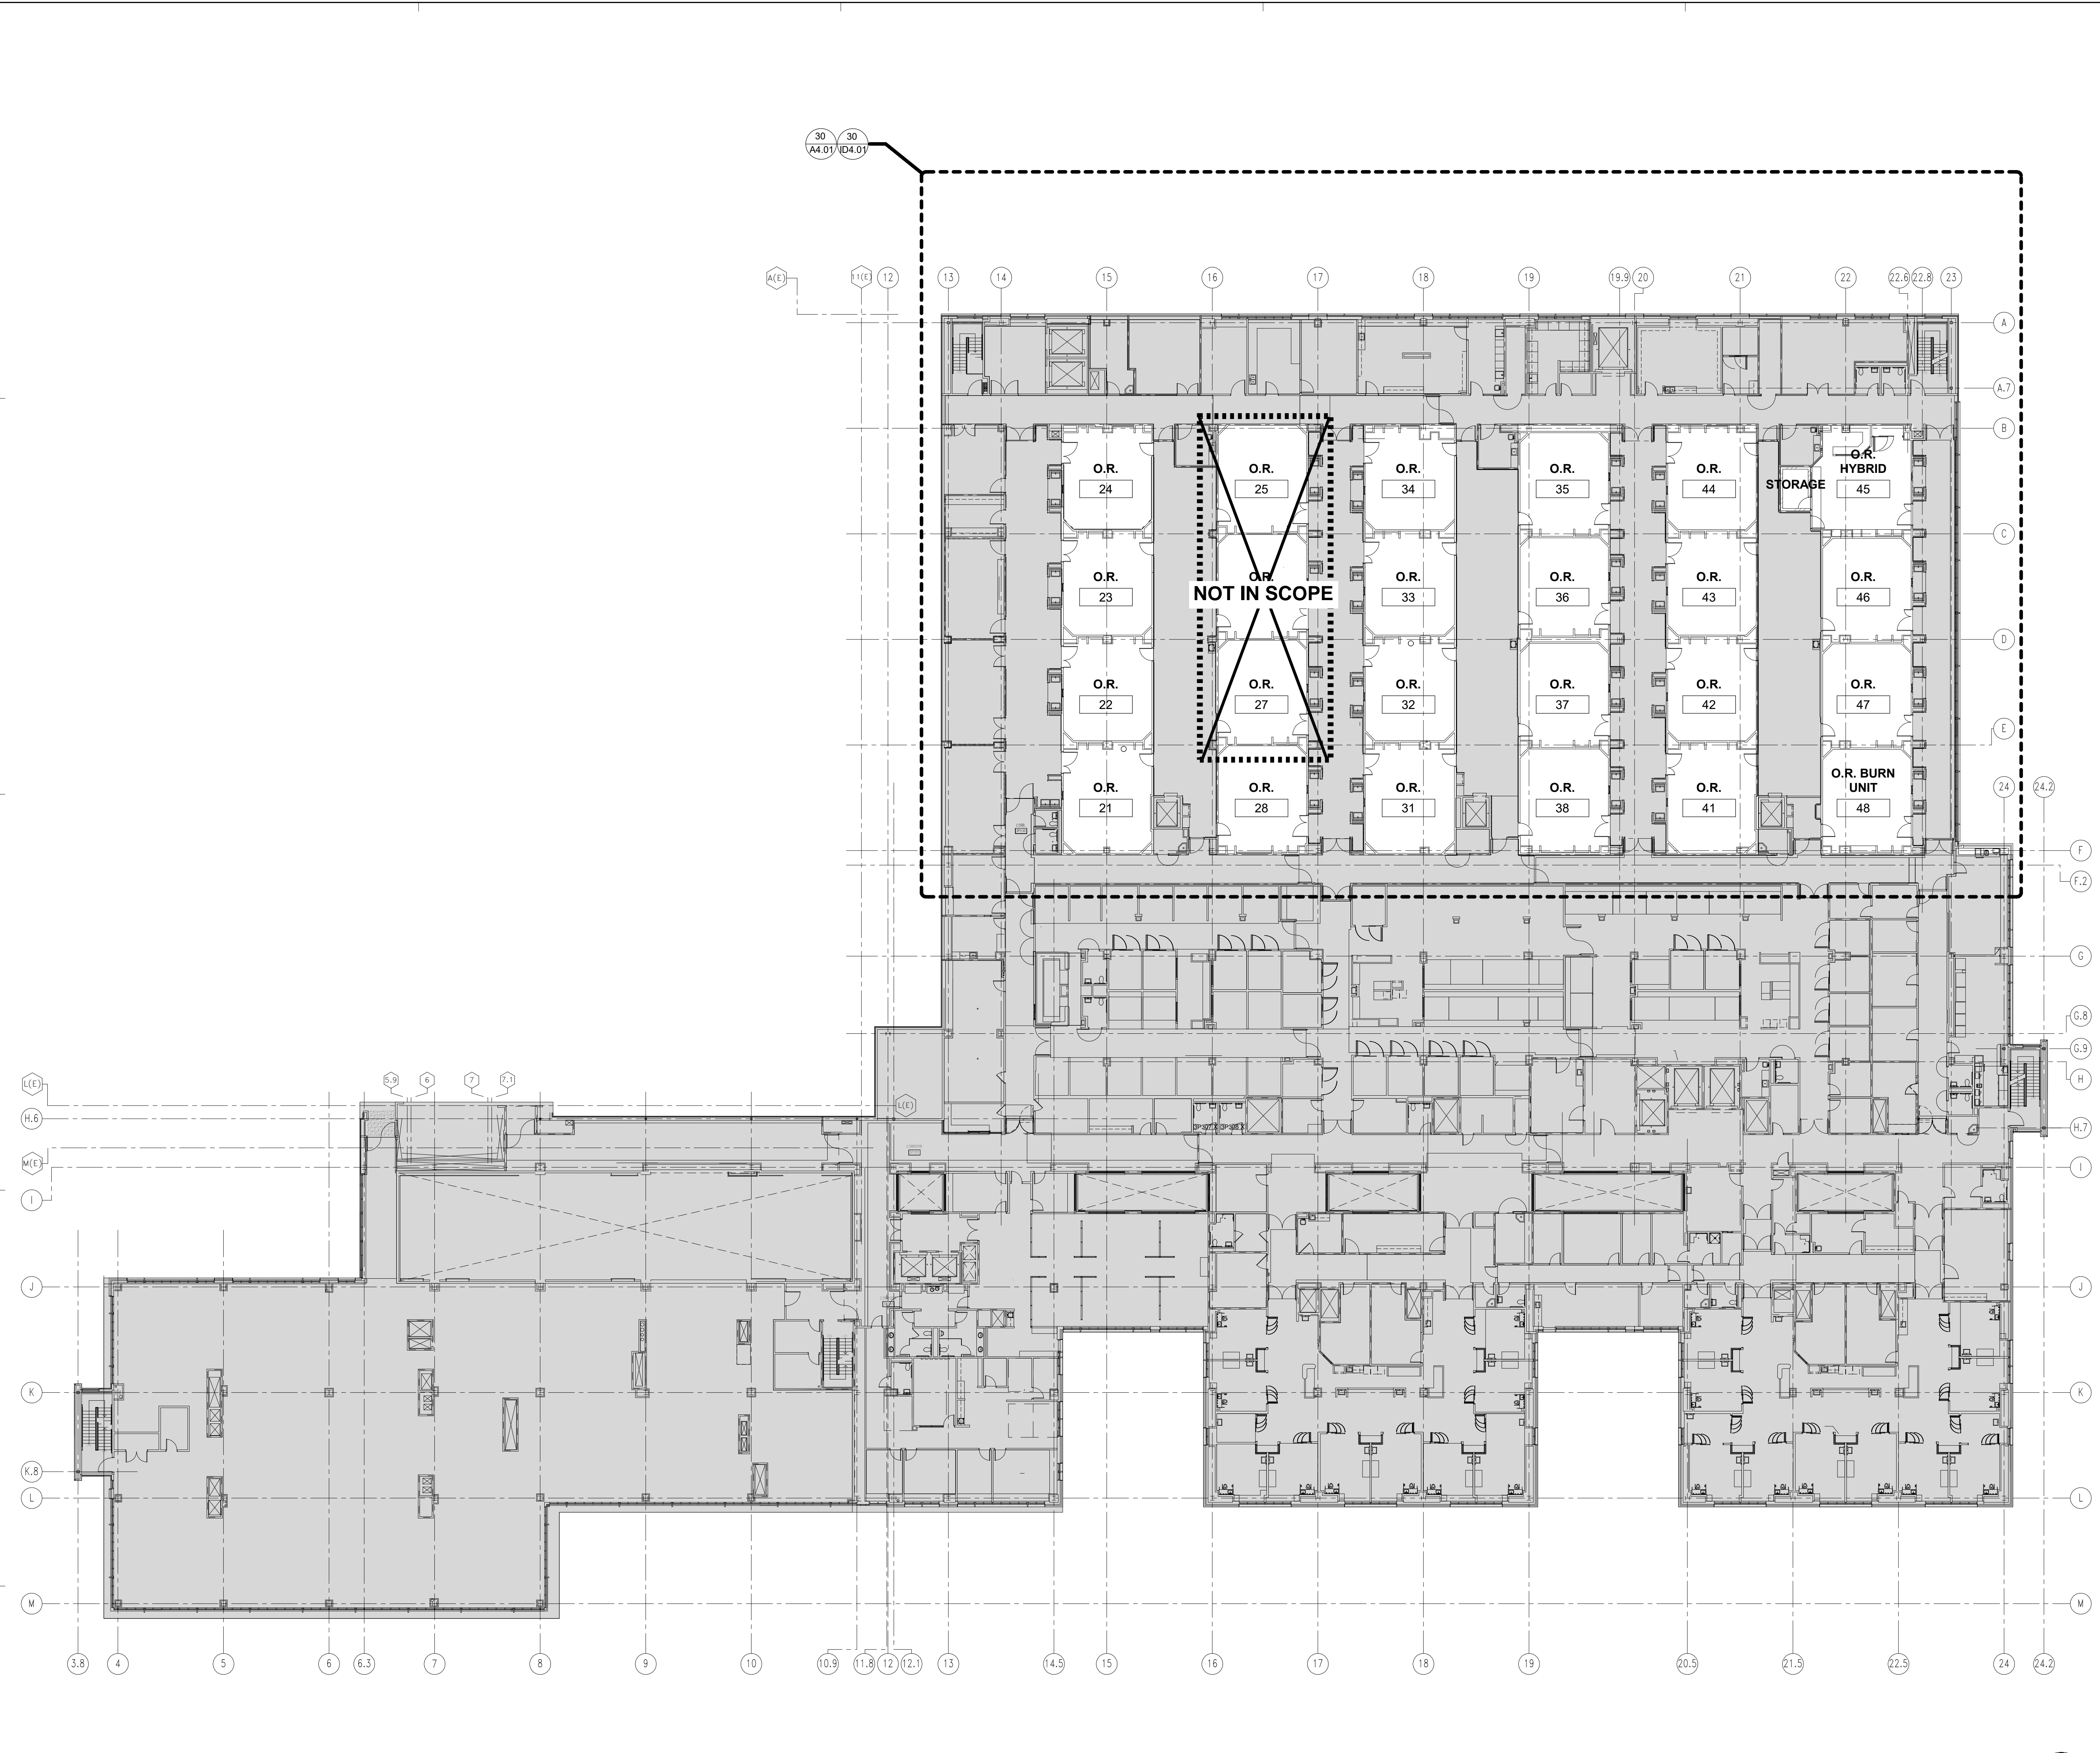
The set of plans and specifications must be kept on the job site at all times and it is intended to make any changes or alterations to the approved set without written permission from the Building Department.  
 The approval of this plan and specifications SHALL NOT be held to permit or approve the violation of any University Policy or State Building Code.

FD&C #: M056973

100% CONSTRUCTION DOCUMENTS

**SESP OR PO&M FLOORING REPLACEMENT ABBREVIATIONS AND SYMBOLS**

ACCOUNT NO.	ARCHITECT	HY JOB NO.	SHEET NO.
	KEN Y.	5839	
	UCDMG PROJECT MGR.	SCALE	<b>A0.02</b>
	ATOSA A.	12" = 1'-0"	
	DESIGNED BY	ISSUE DATE	
	PP	7/25/2022	
	DRAWN BY	REVIT VERSION	
	PP	2019	2 of 16 SHEETS



**GENERAL NOTES**

1. CONTRACTOR TO VERIFY (E) CONDITIONS AND NOTIFY ARCHITECT OF ANY IN THE FIELD DISCREPANCIES PRIOR TO START OF CONSTRUCTION.
2. CONTRACTOR TO VERIFY ACCURACY OF ALL (E) DIMENSIONS AND NOTIFY ARCHITECT OF ANY CONFLICTS PRIOR TO PERFORMING NEW WORK.
3. ALL (E) WALLS WITH (E) FINISHES TO REMAIN ARE DIMENSIONED TO FACE OF FINISH.
4. PROTECT ALL (E) FINISHES TO REMAIN AND (E) EQUIPMENT DURING CONSTRUCTION.
5. PATCH & REPAIR WALLS & FLOORS THAT ARE (E) TO REMAIN AND AFFECTED BY THE WORK.
6. GROUT FILL ALL HOLES IN WALL WHERE ITEMS ARE REMOVED AND RELOCATED.
7. REFER TO ID SERIES SHEETS FOR ADDITIONAL INFORMATION.
8. PHASING OF PROJECT AS FOLLOWS: PROJECT IS TO BE COMPLETED IN (24) PHASES. (1) OPERATING ROOM AT A TIME WITH UP TO TWO WEEKS OF CONSTRUCTION PER ROOM.

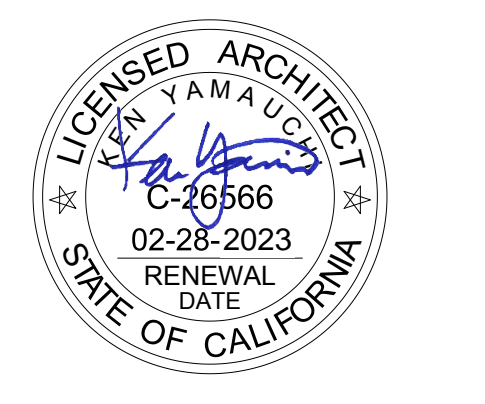
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4602 2ND AVENUE, SUITE 300  
SACRAMENTO, CALIFORNIA 95817  
(916) 734-7024

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**HY** HIBSER YAMAUCHI Architects, Inc.  
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530.758.1270 tel | 530.758.4789 fax

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UC DAVIS HEALTH  
BUILDING DEPARTMENT  
REVIEWED FOR CODE COMPLIANCE  
Paul R. Menard, AIA 07/27/2022 1:35:58 PM

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100% CONSTRUCTION DOCUMENTS

**SESP OR PO&M FLOORING REPLACEMENT OVERALL FLOOR PLAN**

**30 OVERALL THIRD FLOOR PLAN**  
1" = 20'-0"

ACCOUNT NO.:	HY JOB NO.:	SHEET NO.:
ARCHITECT:	5839	A2.01
UCDMG PROJECT MGR.:	SCALE:	
ATOSA A.	As indicated	
DESIGNED BY:	ISSUE DATE:	
PP	7/25/2022	
DRAWN BY:	REVISION:	
PP	2019	3 of 16 SHEETS



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**LEGEND**

- (E) 1 HR. OCCUPANCY SEPERATION PARTITION
- (E) 2HR. FIRE RATED PARTITION
- (E) NON- RATED FIRE- RESISTIVE PARTITION (W/ UNPROTECTED OPENINGS) AND/ OR EXTERIOR WALL TO REMAIN.
- NOT IN SCOPE



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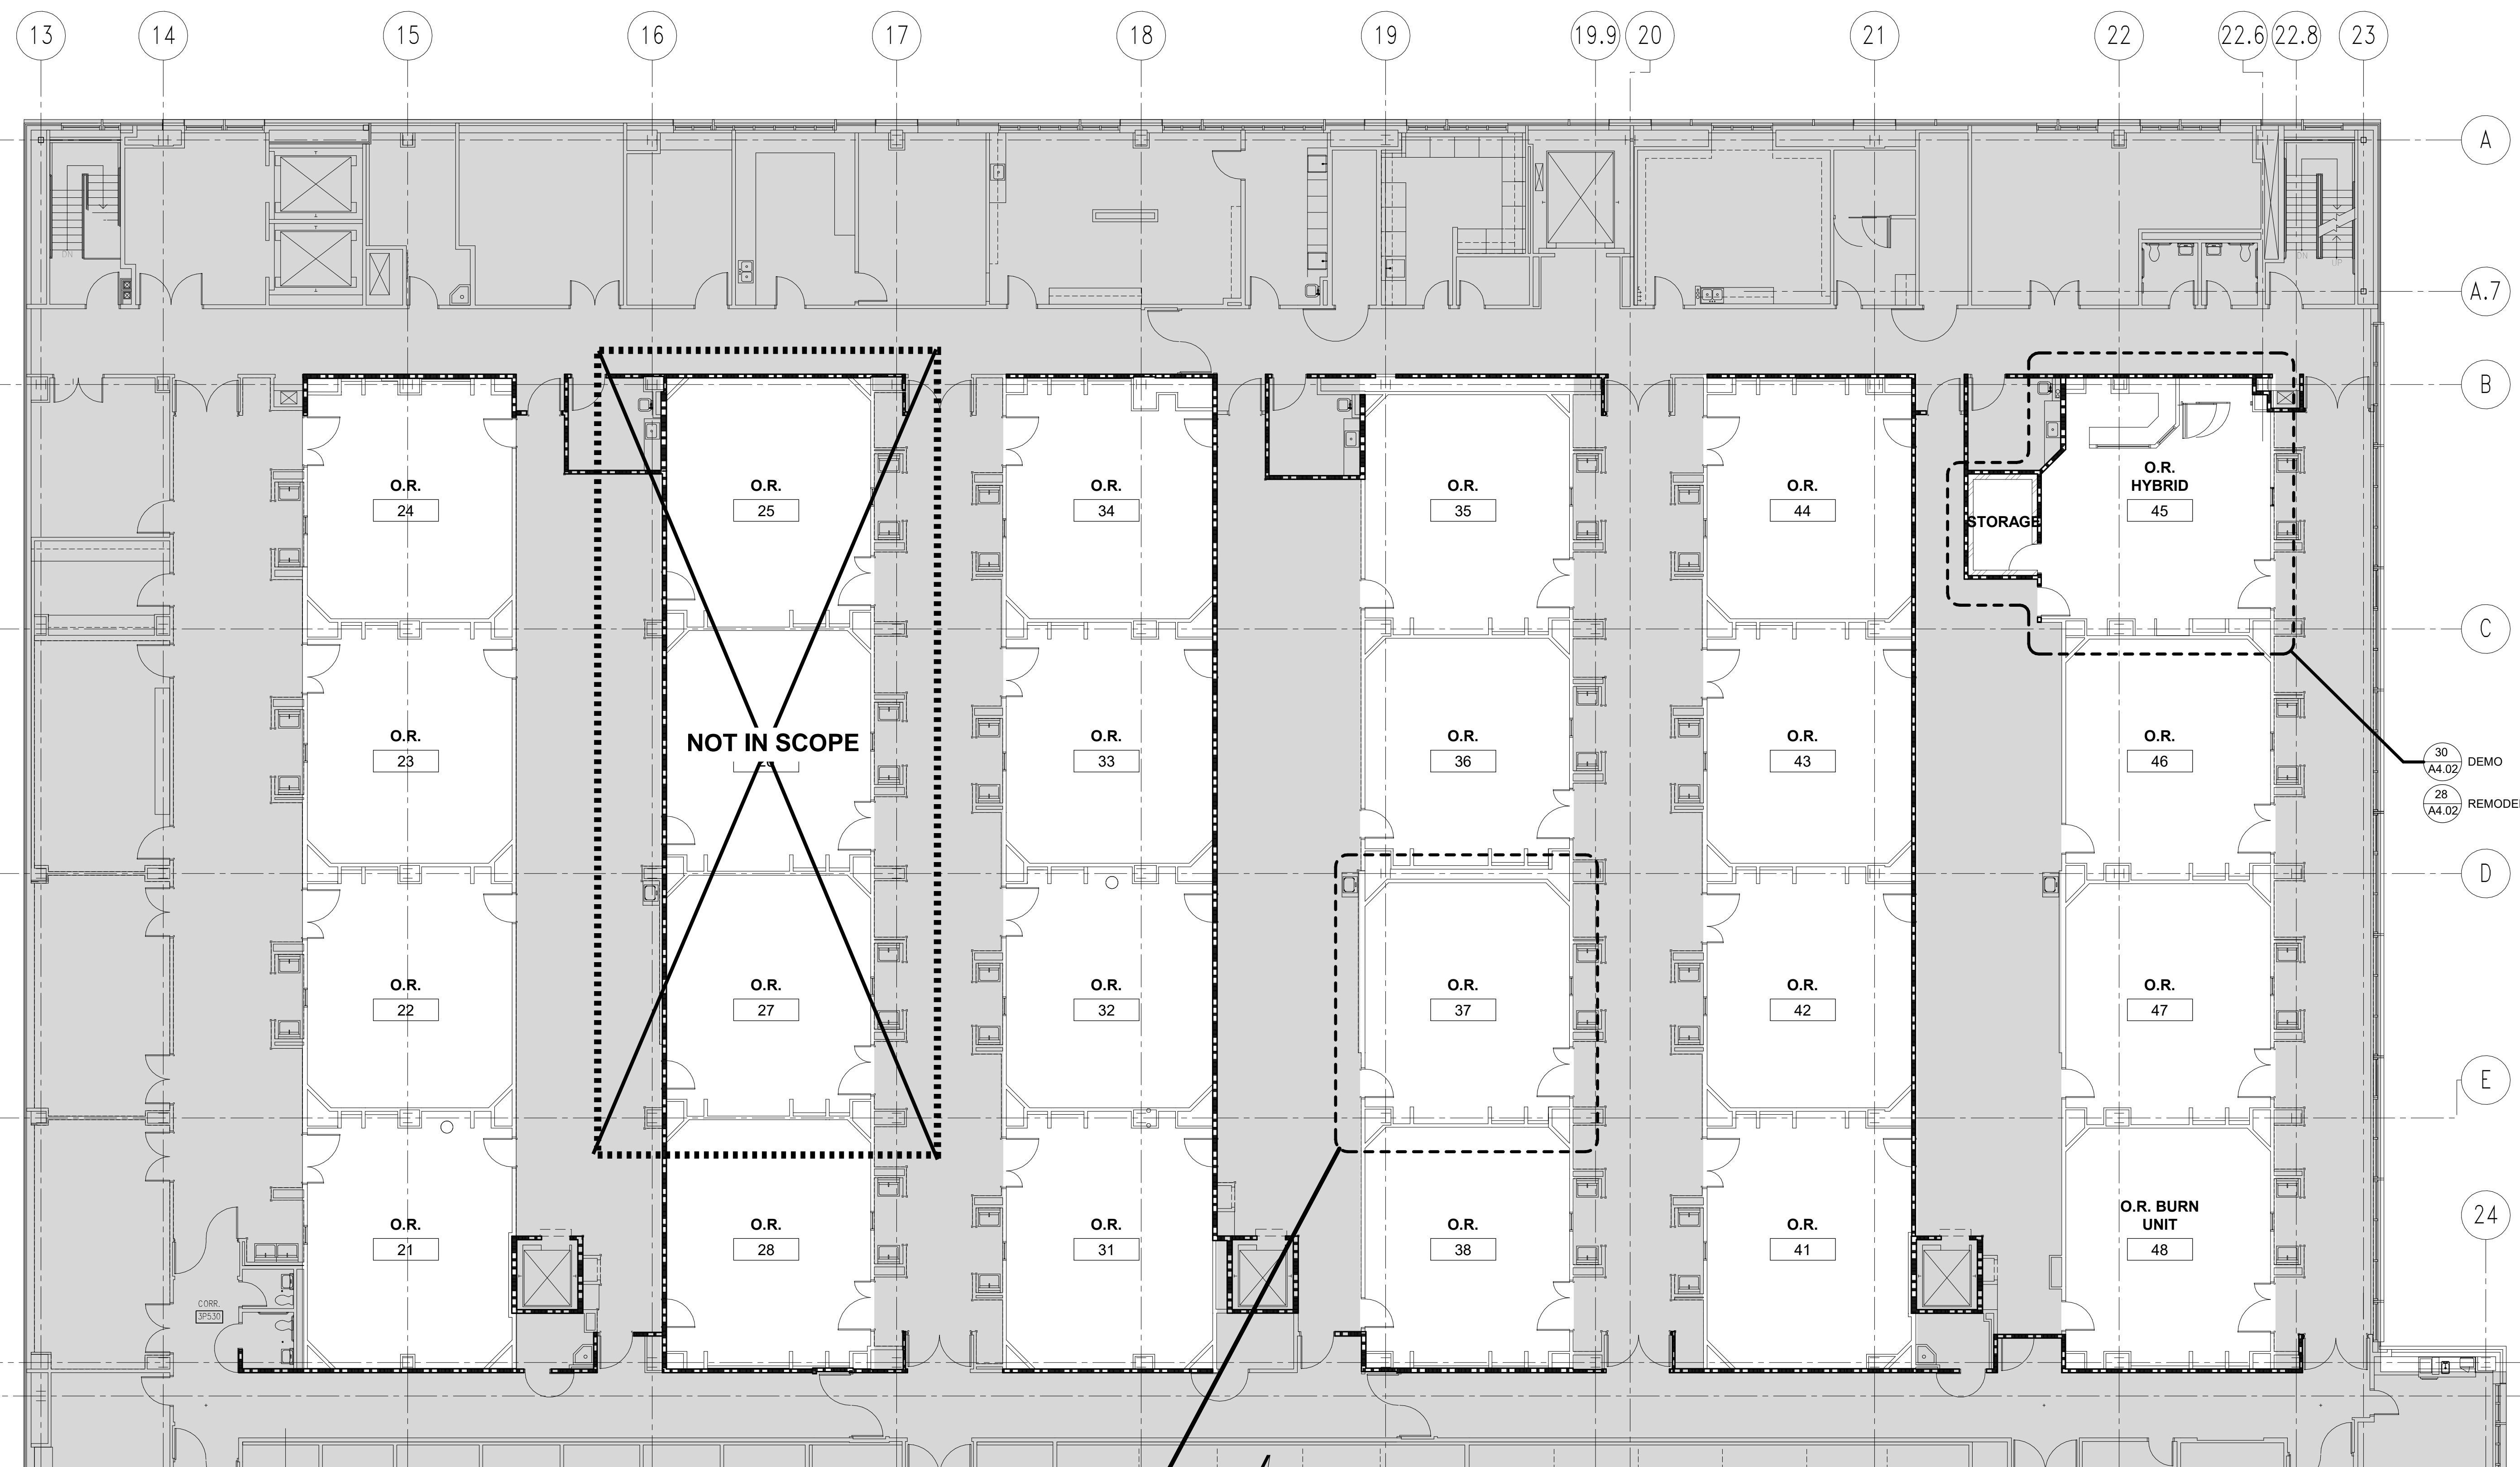
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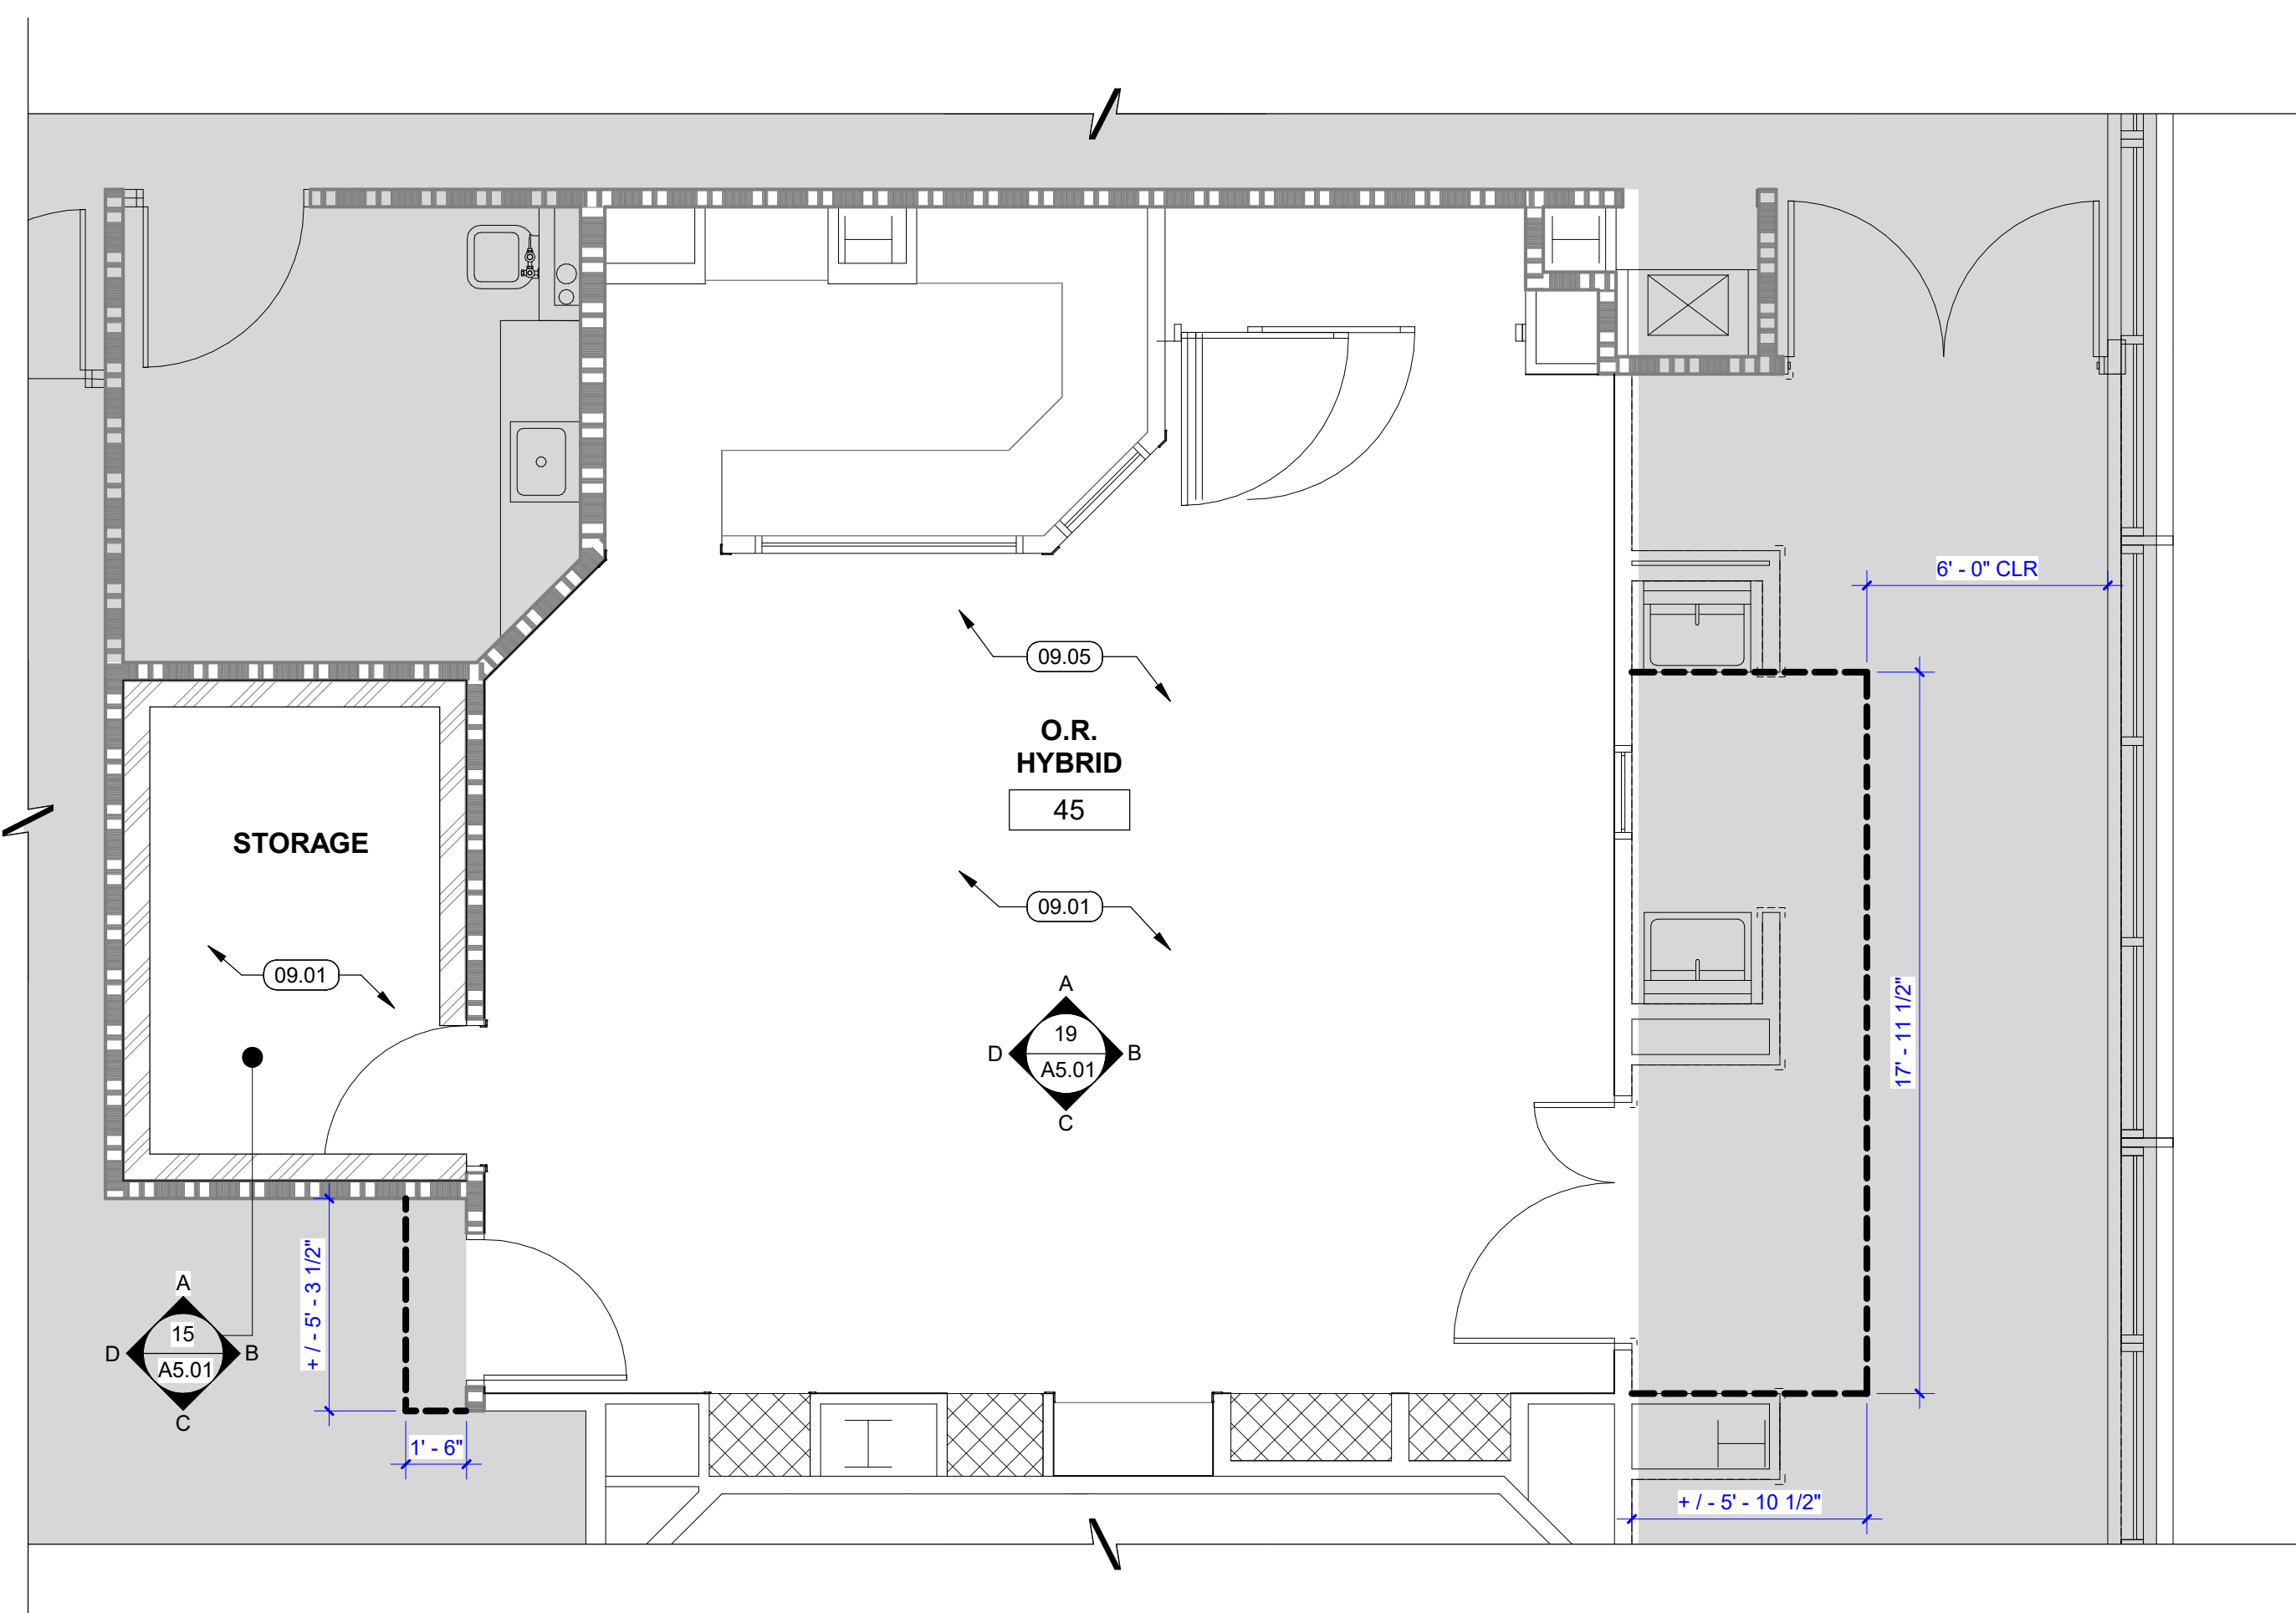
**SESP OR PO&M FLOORING REPLACEMENT ENLARGED FLOOR PLAN**

ACCOUNT NO.:	HY JOB NO.:	SHEET NO.:
KEN Y.	5839	A4.01
UCDMG PROJECT MGR.:	SCALE:	
ATOSA A.	As indicated	
DESIGNED BY:	ISSUE DATE:	
PP	7/25/2022	
DRAWN BY:	REVTY VERSION:	
PP	2019	4 OF 16 SHEETS

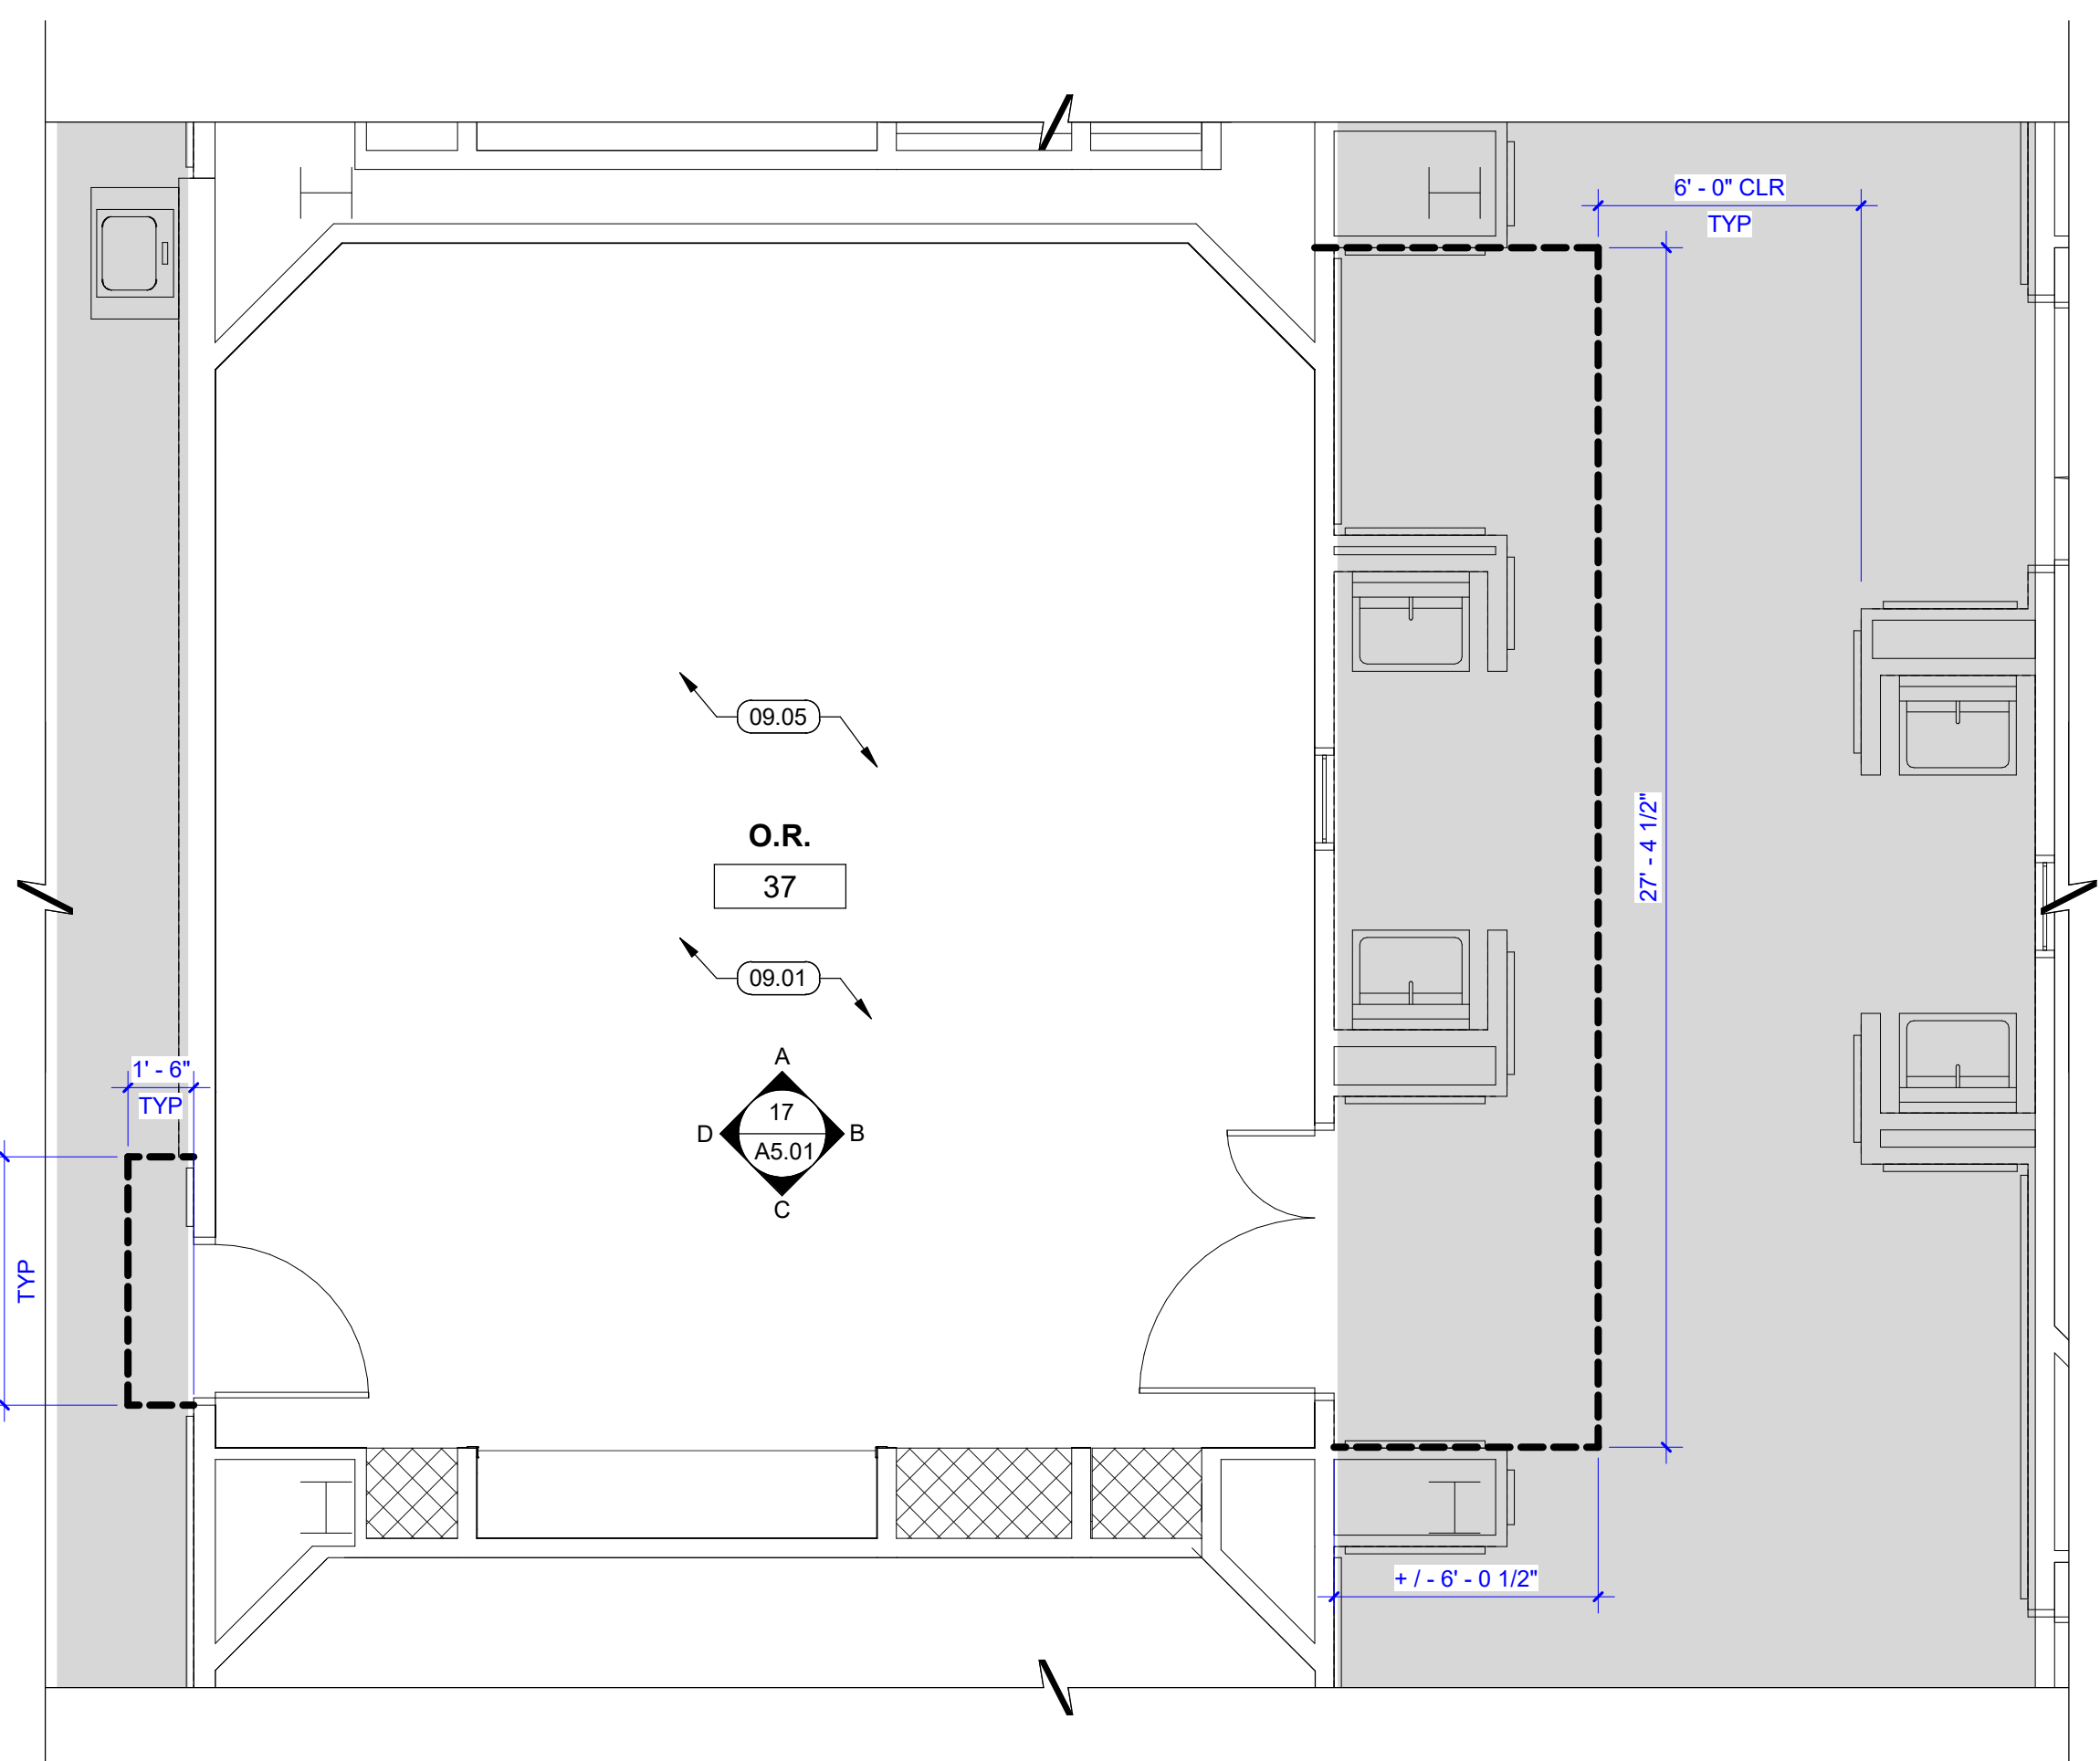


**30 ENLARGED THIRD FLOOR PLAN - NORTH**  
 3/32" = 1'-0"

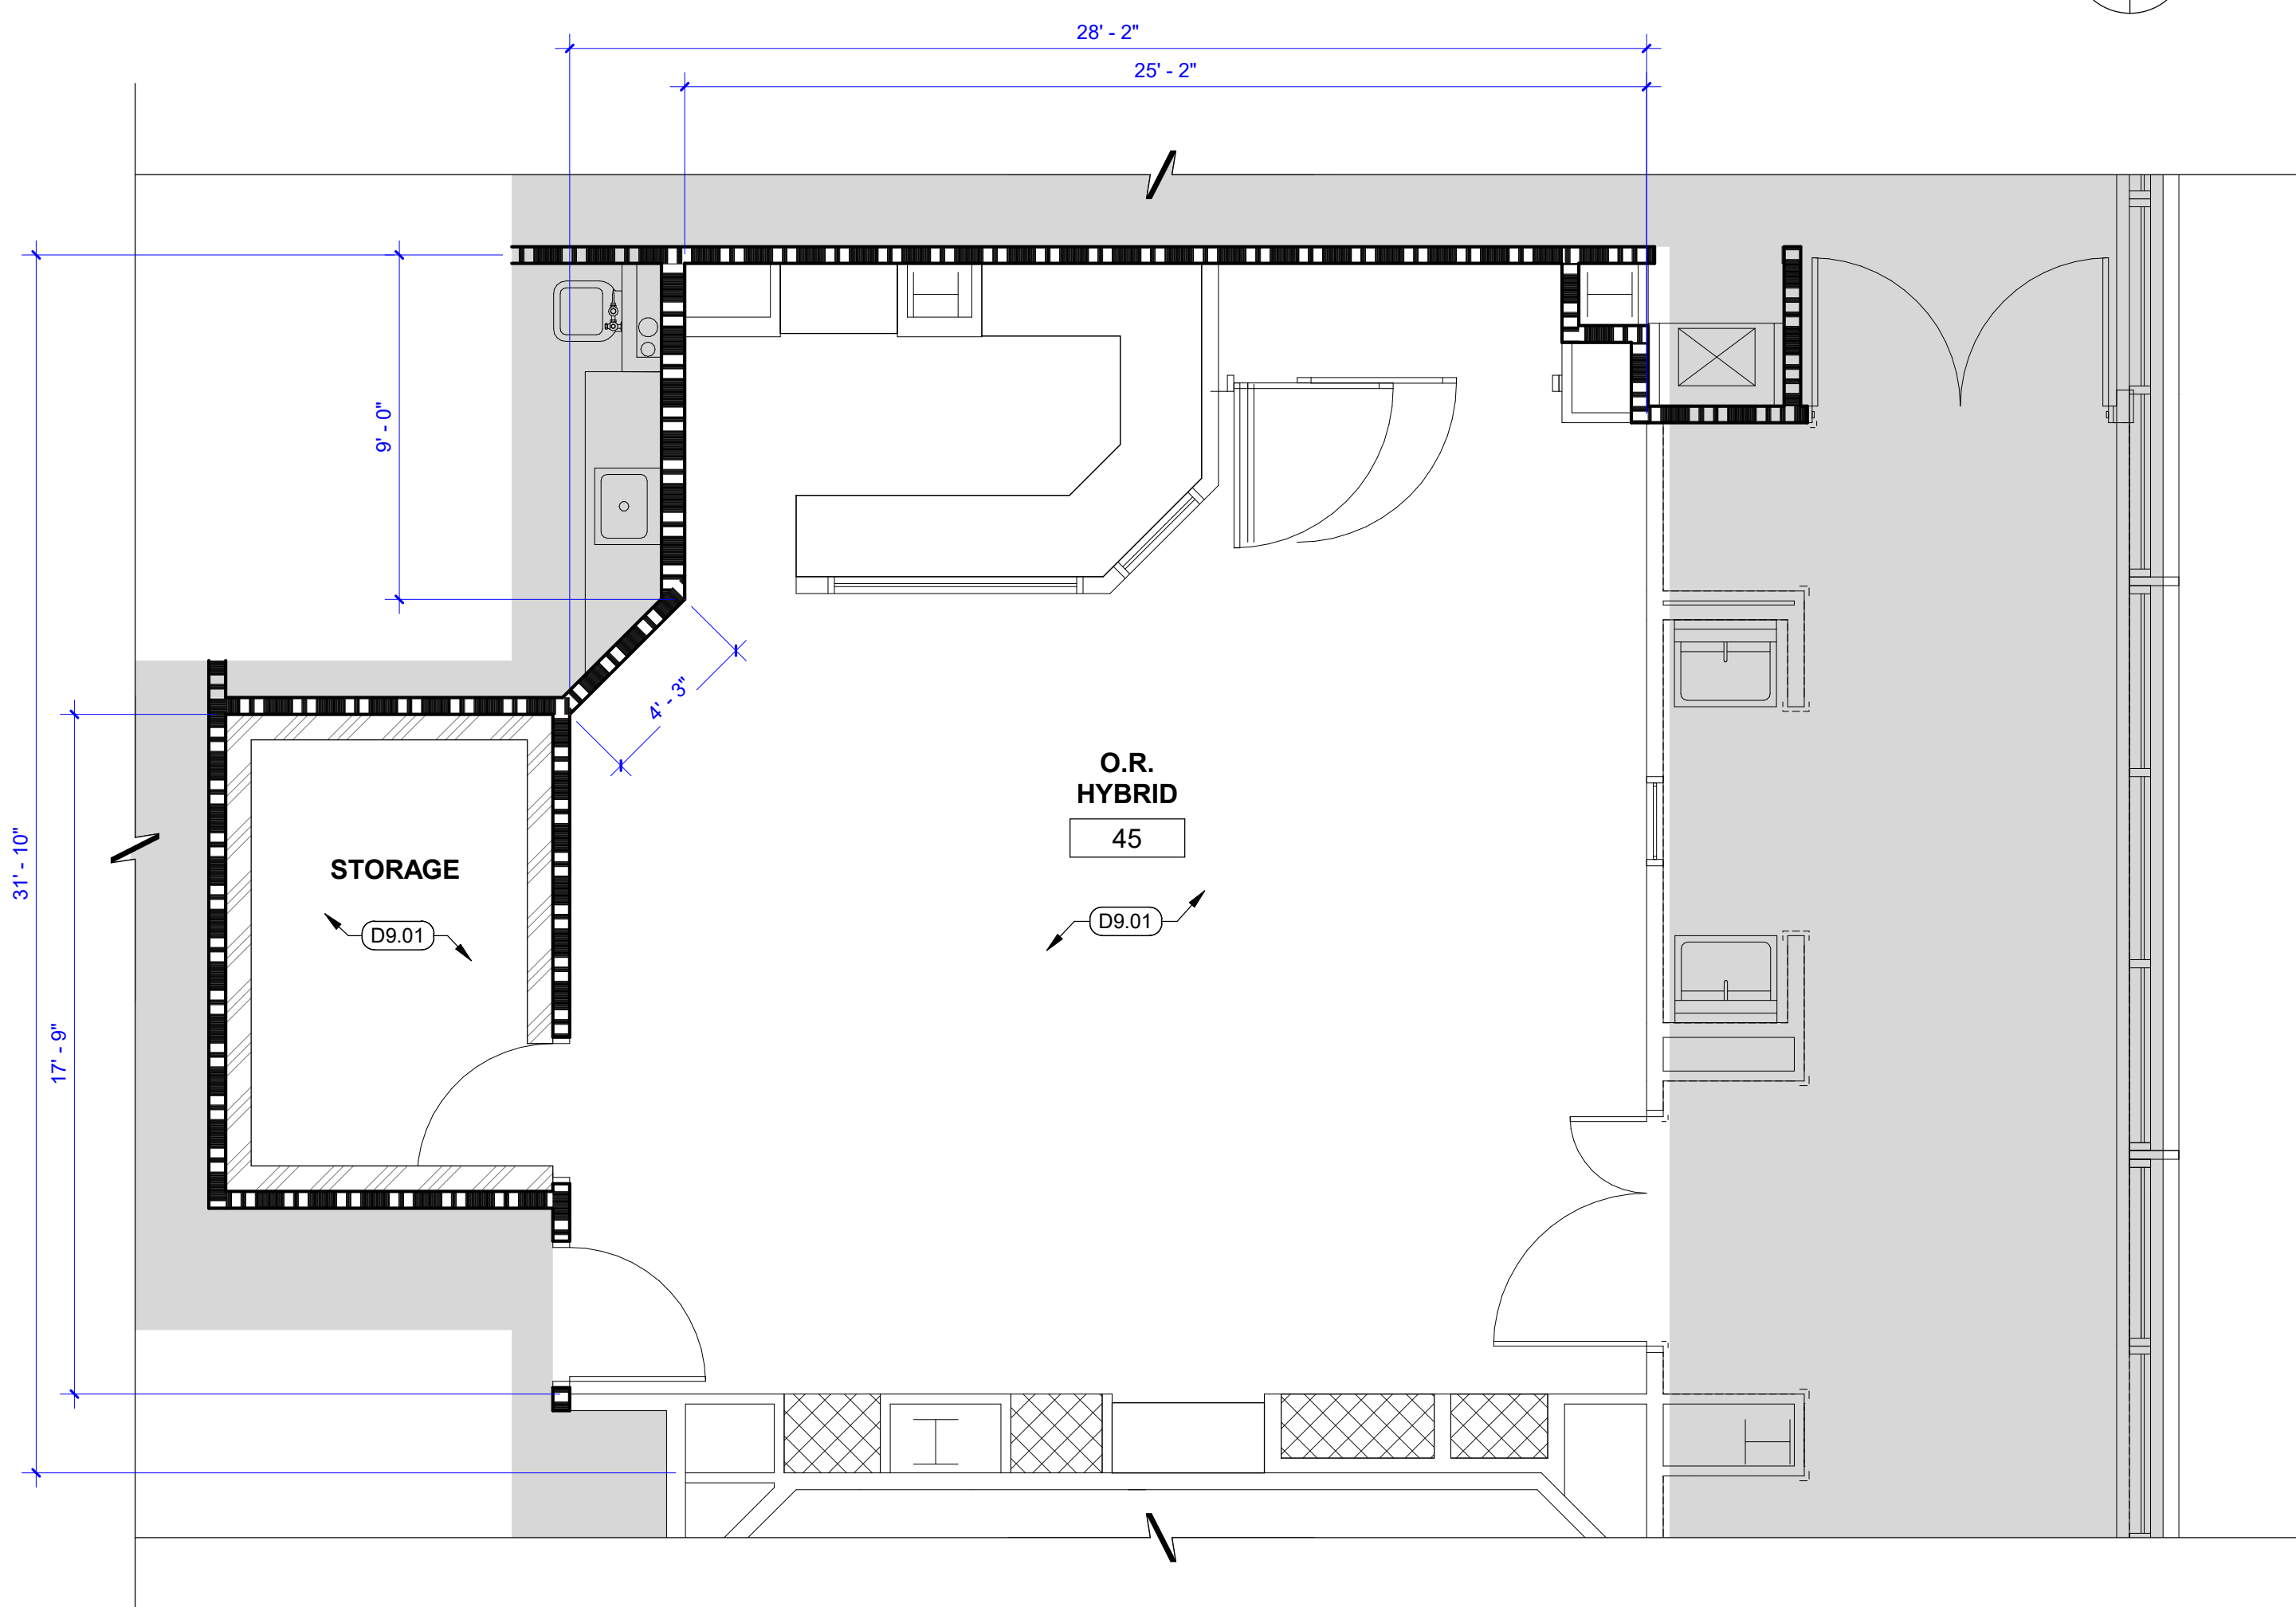
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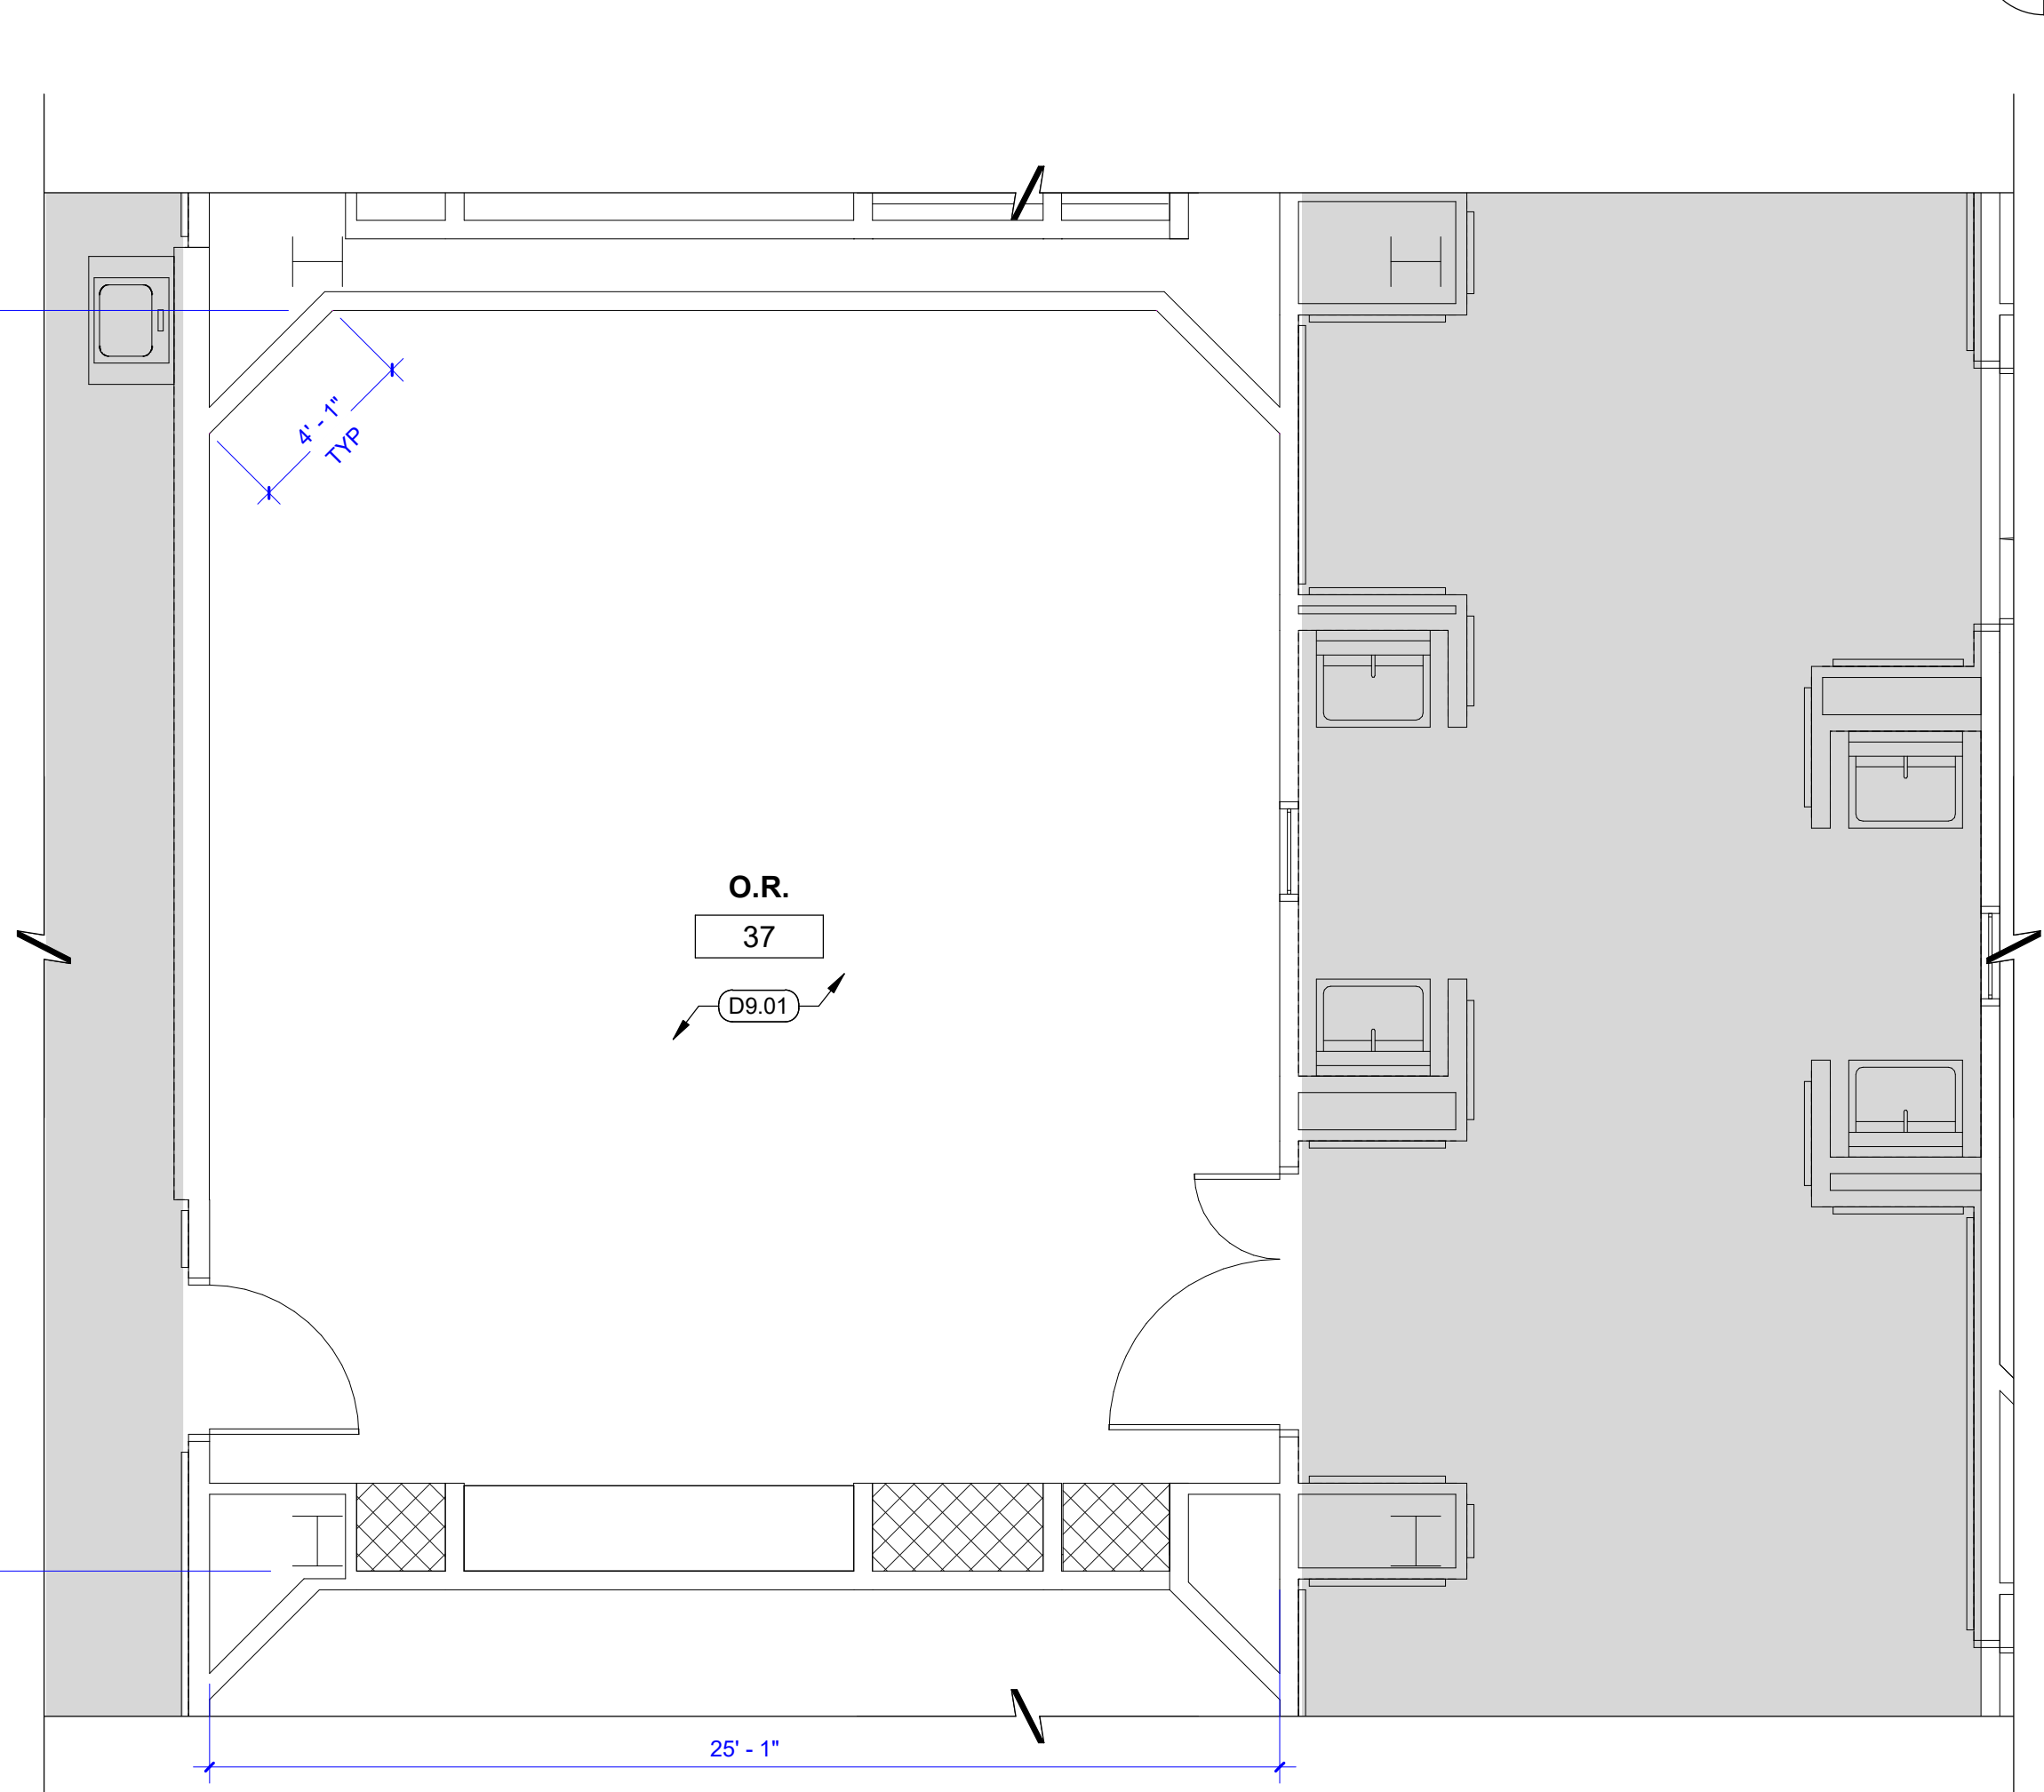
**28 ENLARGED REMODEL PLAN - HYBRID OPERATING ROOM, #45**  
1/4" = 1'-0"



**13 ENLARGED REMODEL PLAN - TYPICAL OPERATING ROOM, #37 (#48 SIM)**  
1/4" = 1'-0"



**30 ENLARGED DEMO PLAN - HYBRID OPERATING ROOM, #45**  
1/4" = 1'-0"



**15 ENLARGED DEMO PLAN - TYPICAL OPERATING ROOM, #37 (#48 SIM)**  
1/4" = 1'-0"

**GENERAL NOTES**

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**LEGEND**

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- (E) 2HR. FIRE RATED PARTITION
- (E) NON- RATED FIRE- RESISTIVE PARTITION (W/ UNPROTECTED OPENINGS) AND/ OR EXTERIOR WALL TO REMAIN.
- (N) VISQUEEN TEMPORARY CONSTRUCTION BARRIER
- (E) EQUIPMENT TO REMAIN
- NOT IN SCOPE

**DEMO NOTES**

- 09.01 REMOVE (E) FLOORING. PREPARE SUBSTRATE TO RECEIVE (N) FLOORING PER MANUFACTURER RECOMMENDATIONS. SCRAPING, BRUSHING, VACUUMING, COMPRESSED AIR BLOWDOWN AND MECHANICALLY CLEAN (I.E. DUSTLESS DIAMOND GRINDING, BEAD-BLAST OR SIMILAR WITH A SUITABLE HEPA VACUUM ATTACHMENT). MOISTURE SEAL WITH KOSTER SEAL WATERPROOF MEMBRANE. AND FLOAT WITH ARDEX SELF-LEVELING COMPOUND. SEE SPECIFICATIONS FOR ADDITIONAL INFO.

**REMODEL NOTES**

- 09.01 INSTALL (N) RESILIENT FLOORING W/ COLD WELD SEAMS, AND INTEGRAL COVERED BASE TO 6" AFF; REFER TO FINISH SCHEDULE, FINISH PLAN AND DETAILS: 1/A8.01 AND 3/A9.01.
- 09.05 VISQUEEN TEMPORARY CONSTRUCTION BARRIERS, DOORS AND ACRYLYN WALL PROTECTIVE PANELS, CRASH RAILS AND CORNER GUARDS ARE N.I.C. FOR BID.

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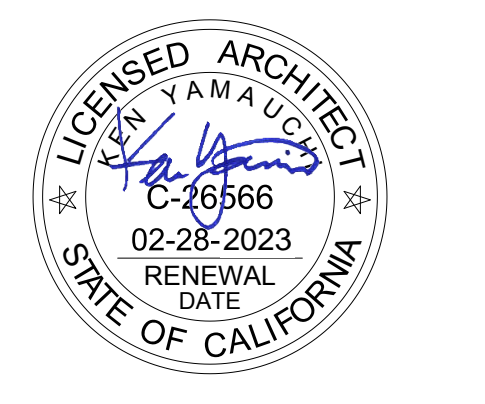
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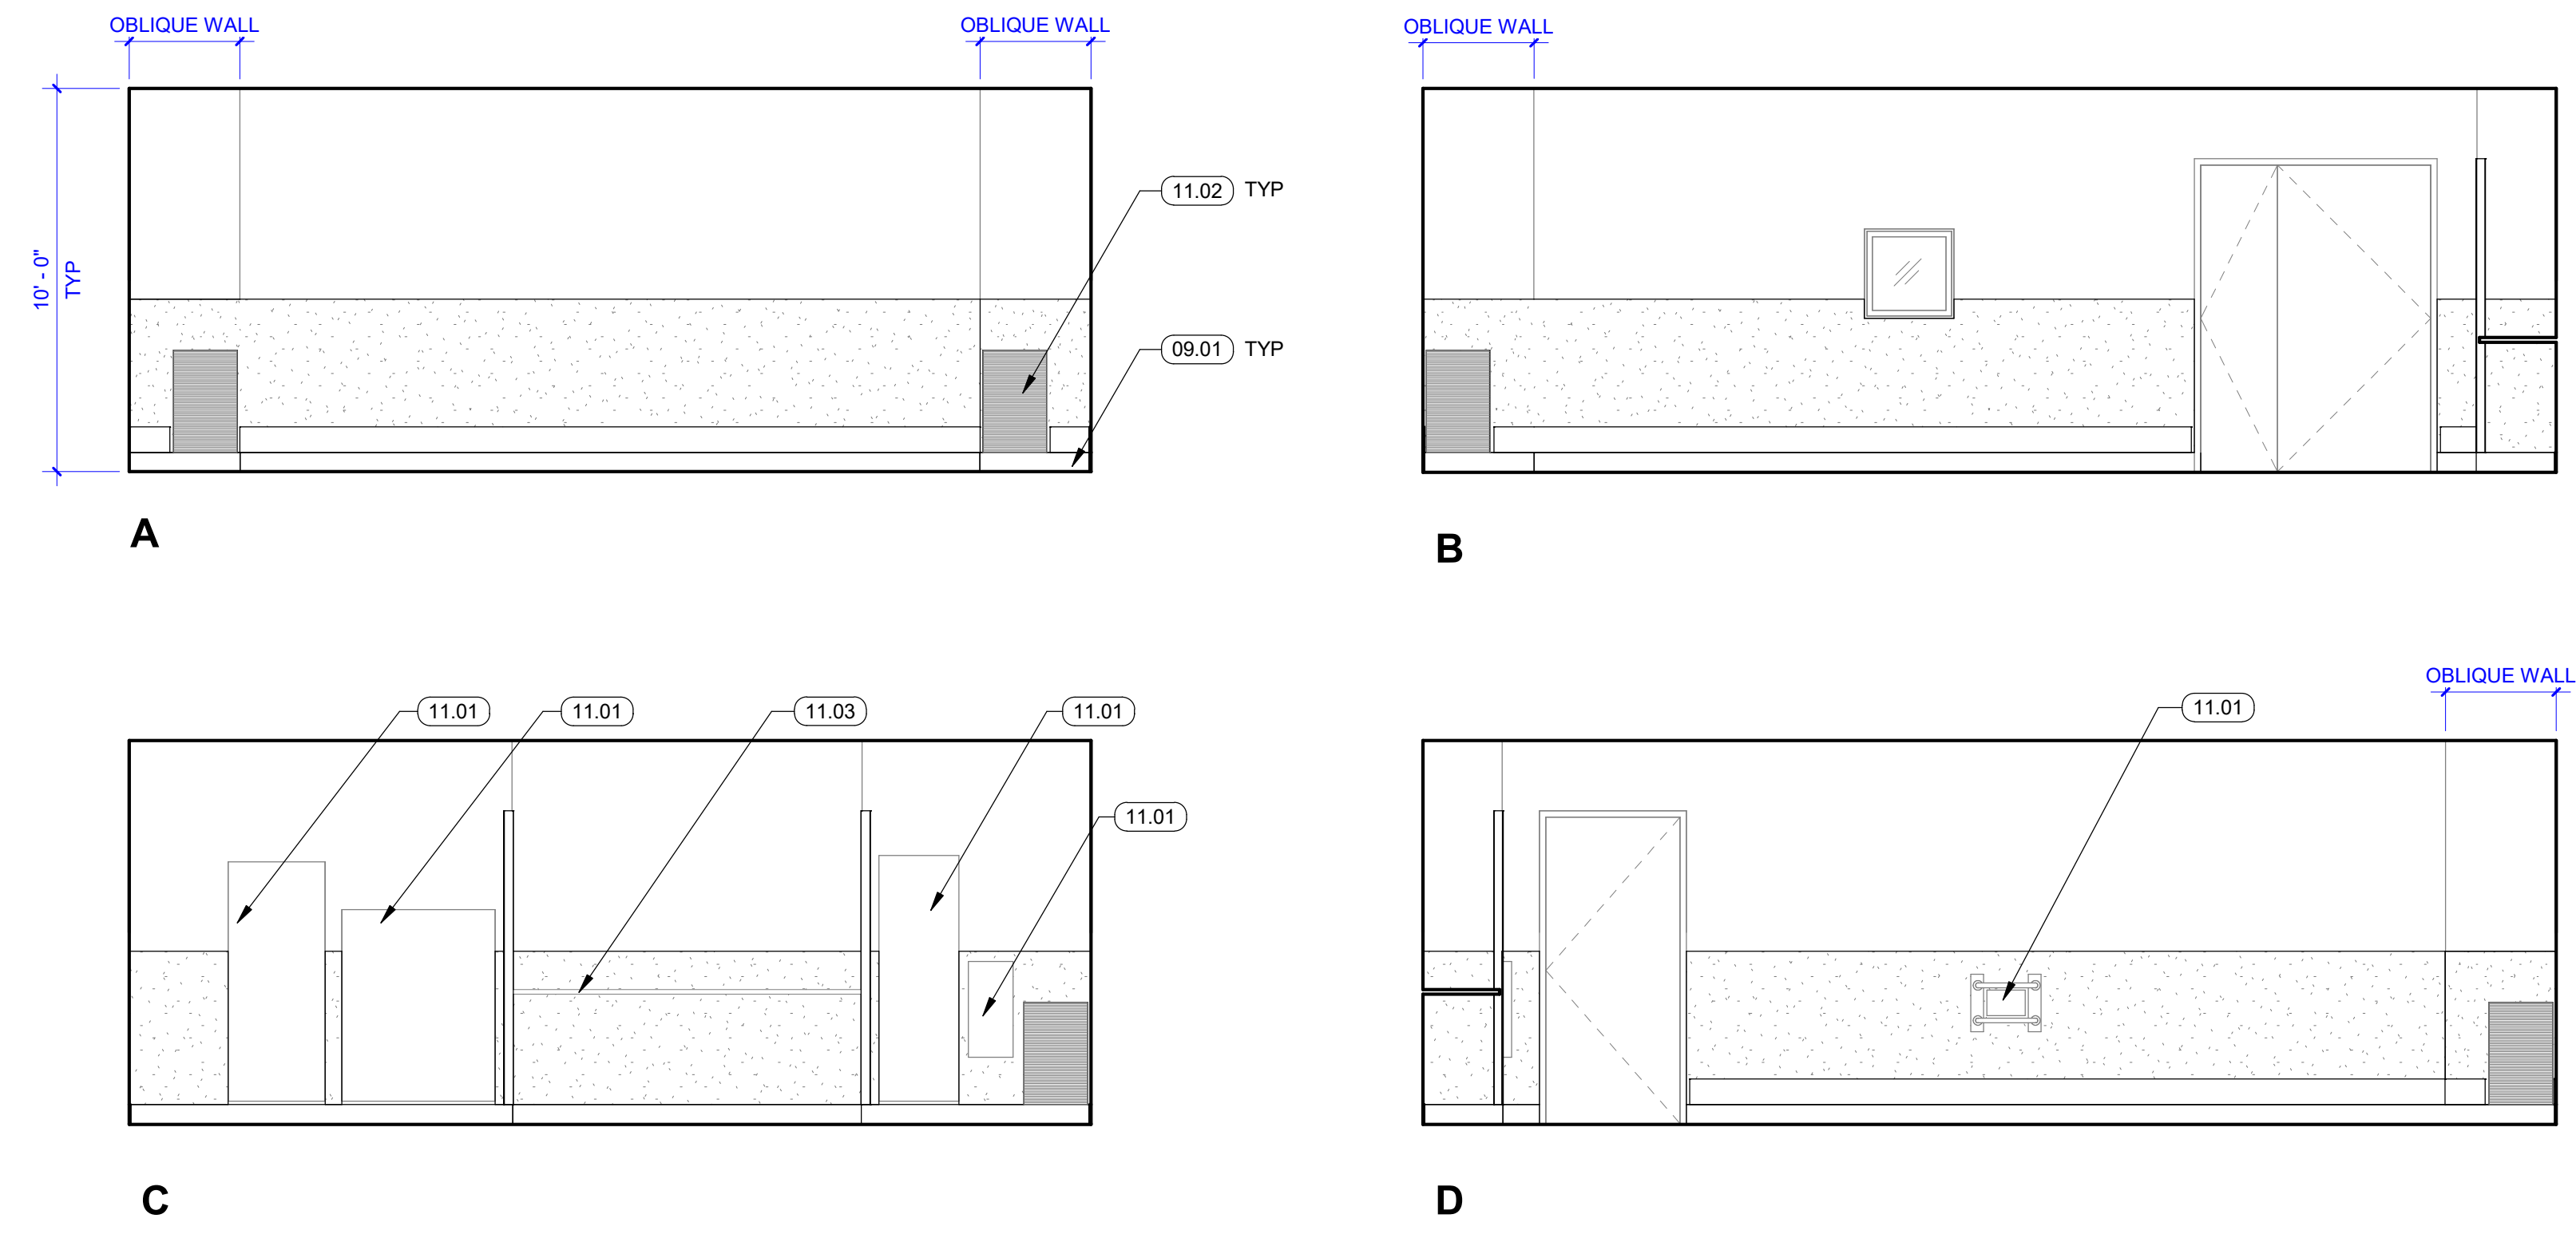
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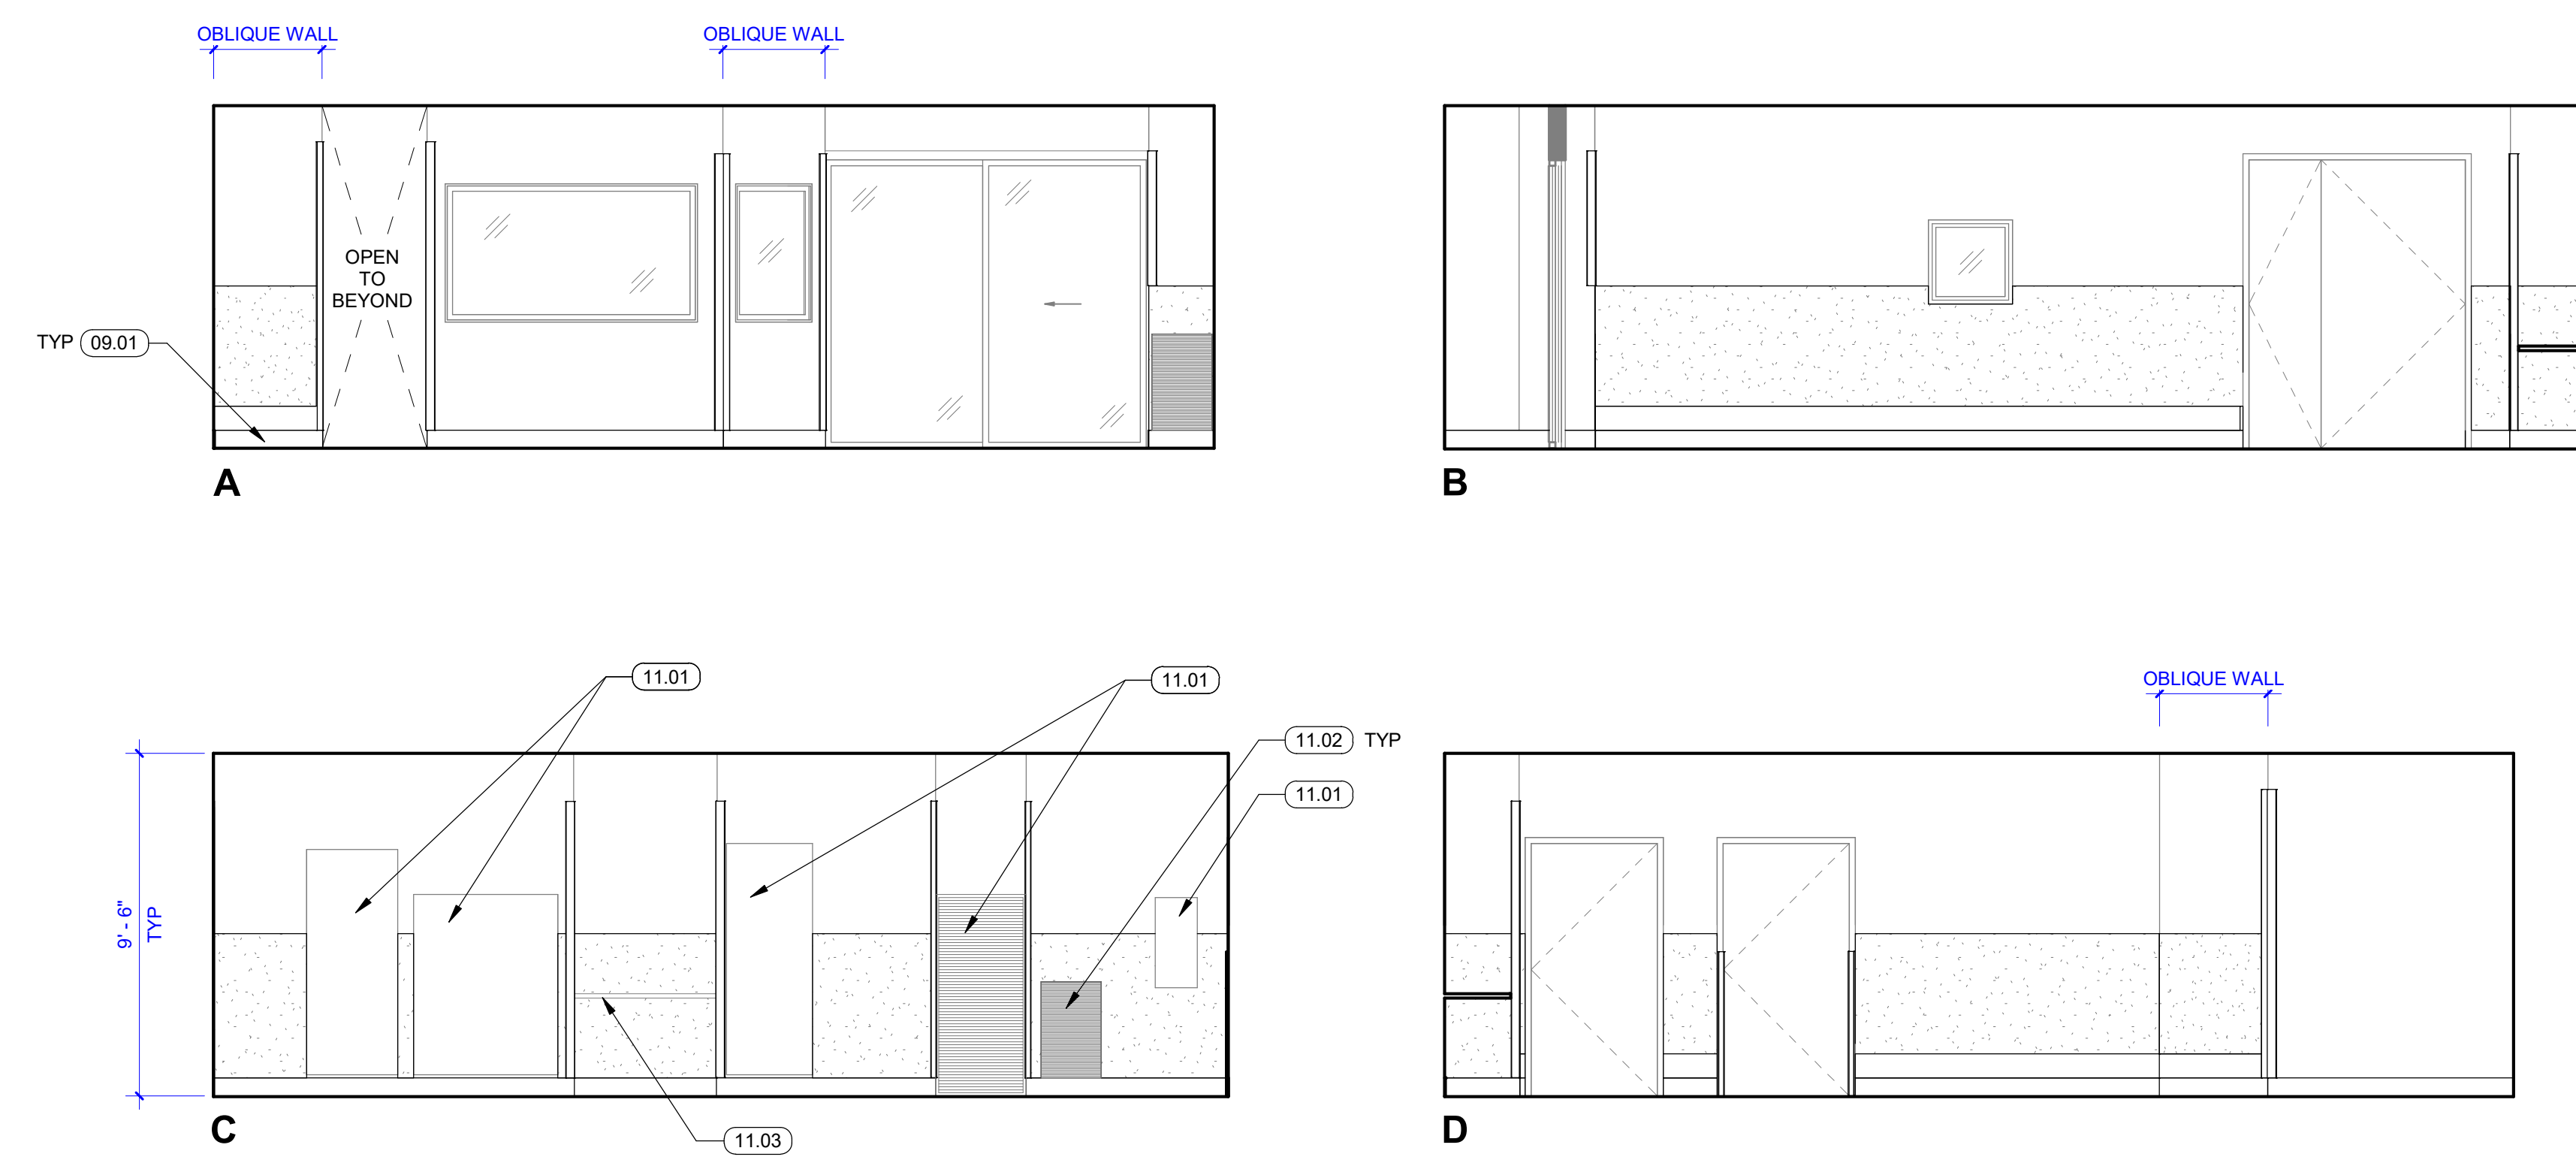
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**SESP OR PO&M FLOORING REPLACEMENT ENLARGED DEMO & REMODEL**

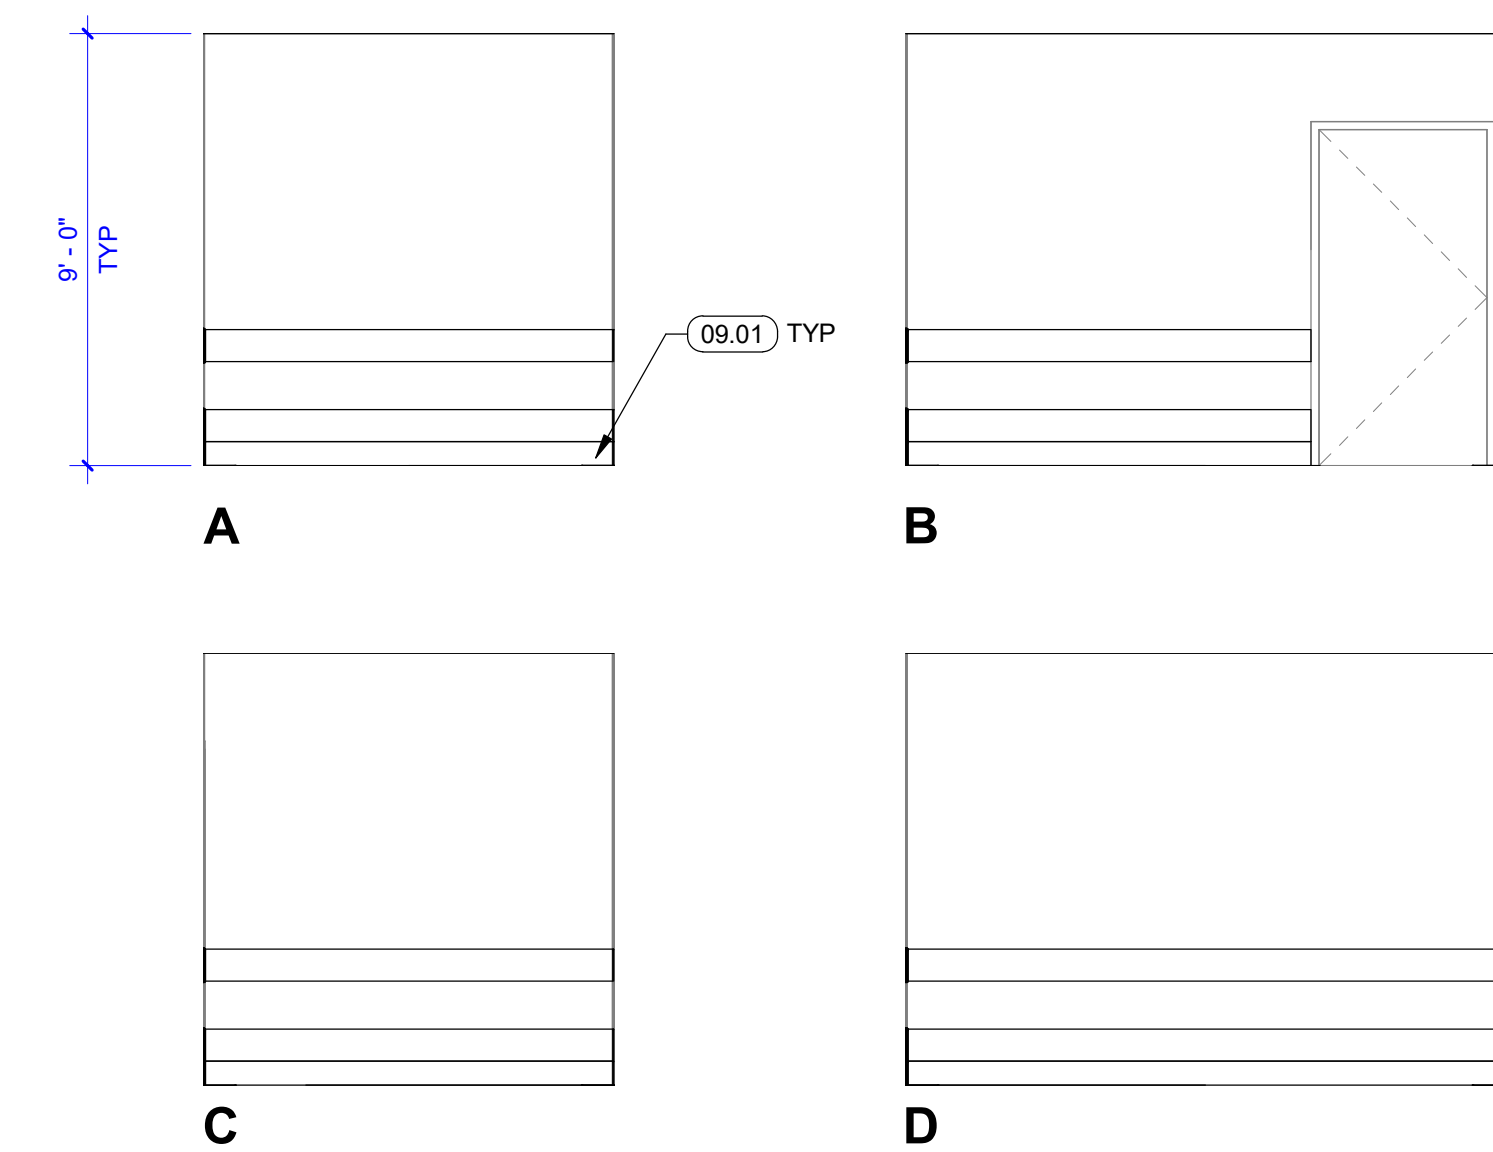
ACCOUNT NO.:	HY JOB NO.:	SHEET NO.:
ROOM:	5839	
BUILDING:	SCALE:	<b>A4.02</b>
FLOORING:	1/4" = 1'-0"	
PROJECT TITLE:	ISSUE DATE:	
3	7/25/2022	
ARCHITECT:	DESIGNED BY:	
KEN Y.	PP	
UCDMG PROJECT MGR:	REVTY VERSION:	
ATOSA A.	2019	5 of 16 SHEETS



**17 INTERIOR ELEVATIONS - TYPICAL OPERATING ROOM, #37 (#48 SIM)**  
1/4" = 1'-0"



**19 INTERIOR ELEVATIONS - HYBRID OPERATING ROOM, #45**  
1/4" = 1'-0"



**15 INTERIOR ELEVATIONS - STORAGE**  
1/4" = 1'-0"

**GENERAL INTERIOR ELEVATION NOTES**

1. REFER TO ID2.02 FOR GENERAL FINISH NOTES, FINISH LEGEND & FINISH SCHEDULE.

**LEGEND**

(E) PROTECTIVE WALL PANEL

**REMODEL NOTES**

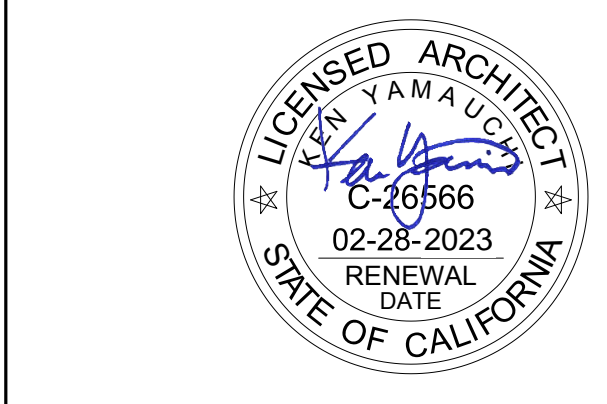
- 09.01 (N) RESILIENT FLOORING W/ COLD WELD SEAMS, AND INTEGRAL COVERED BASE TO 6" AFF. REFER TO FINISH SCHEDULE, FINISH PLAN AND DETAILS: 1/A9.01 AND 3/A9.01
- 11.01 (E) EQUIPMENT TO REMAIN.
- 11.02 (E) GRILL TO REMAIN.
- 11.03 (E) COUNTER TO REMAIN.

**UC DAVIS HEALTH**  
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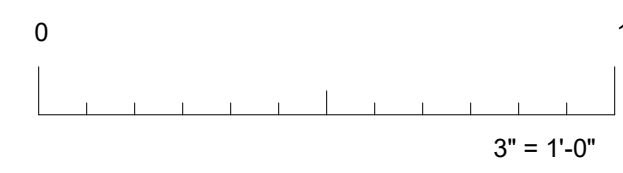
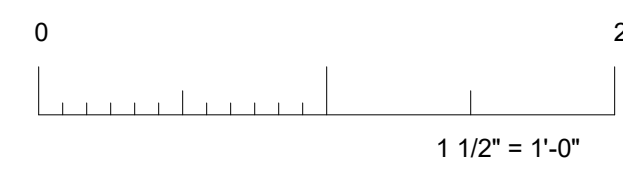
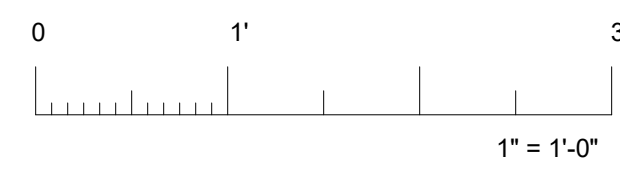
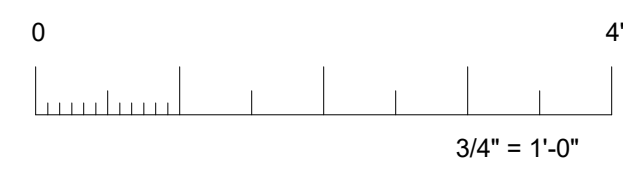
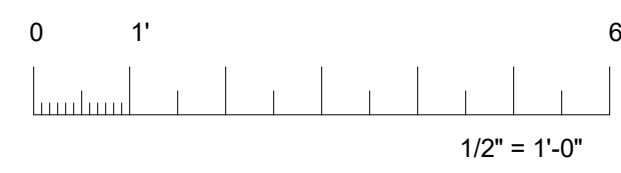
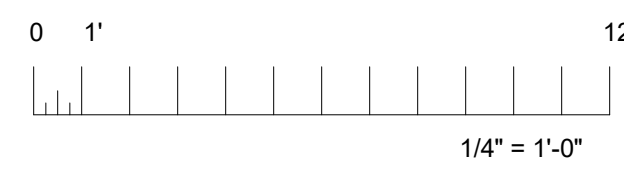
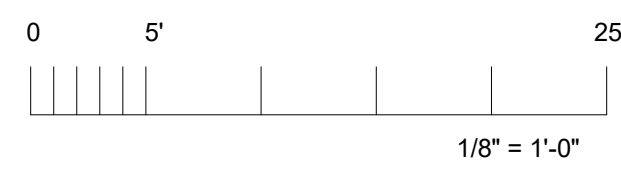
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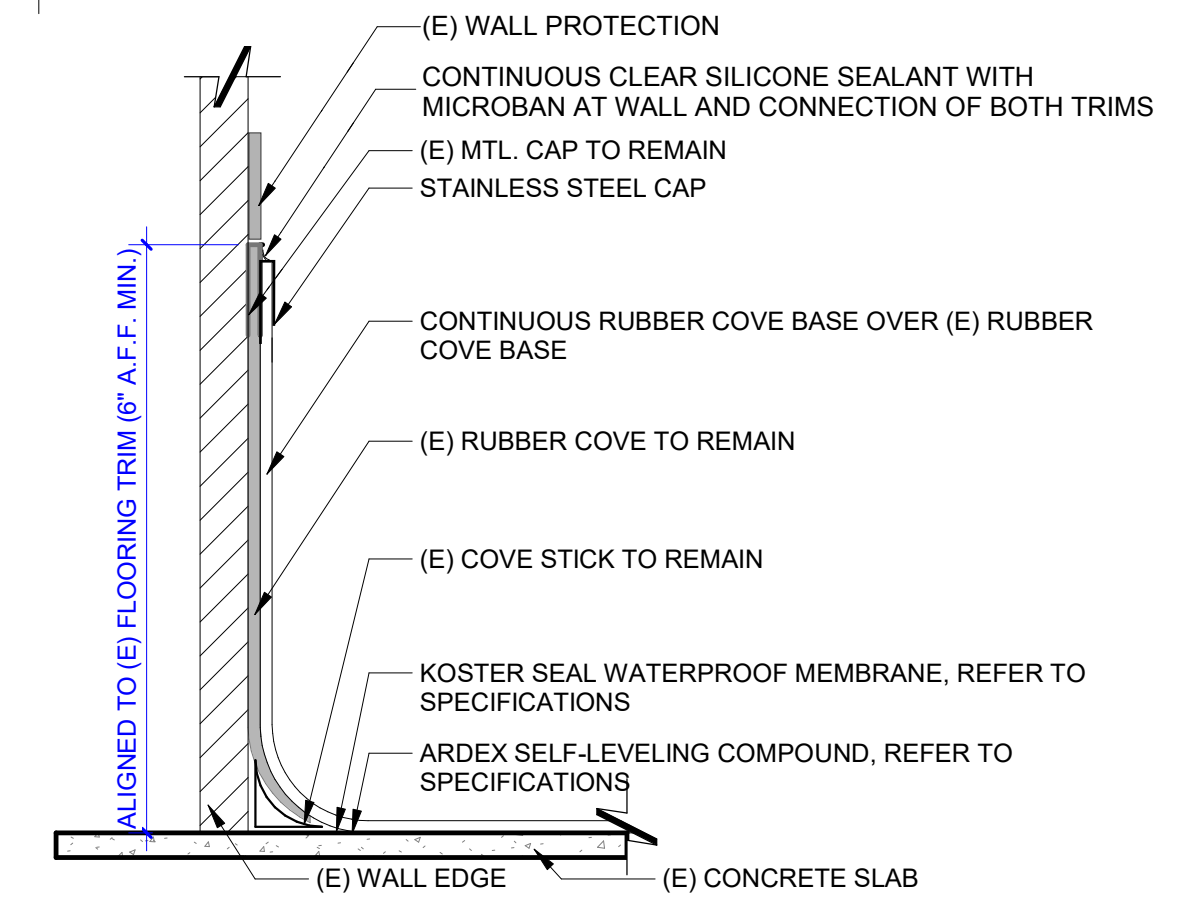
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**SESP OR PO&M FLOORING REPLACEMENT INTERIOR ELEVATIONS**

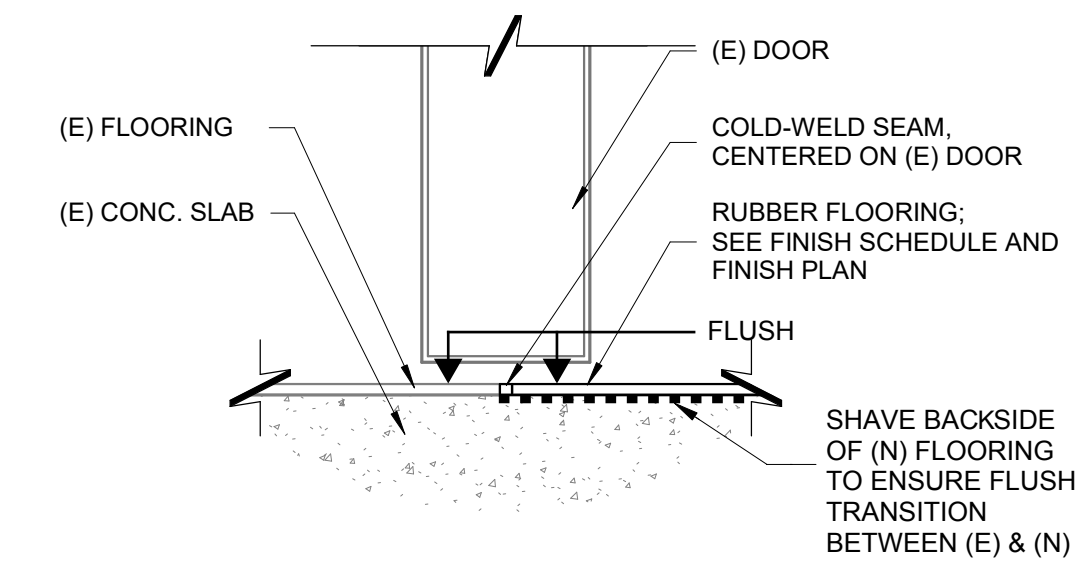
ACCOUNT NO.	HY JOB NO.	SHEET NO.
KEN Y.	5839	A5.01
UCDMG PROJECT MGR.	SCALE	
ATOSA A.	1/4" = 1'-0"	
DESIGNED BY	ISSUE DATE	
PP	7/25/2022	
DRAWN BY	REVIT VERSION	
PP	2019	6 OF 16 SHEETS



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**1 COVE BASE**  
6" = 1'-0"



**2 TRANSITION @ (E) DOOR THRESHOLD**  
6" = 1'-0"

**UC DAVIS HEALTH**

FACILITIES DESIGN & CONSTRUCTION  
4602 2ND STREET, SUITE 300  
DAVIS, CALIFORNIA 95618  
(530) 754-7024

HY ARCHITECTS PROJECT #: 5839

**HY HIBSER YAMAUCHI**  
Architects, Inc.  
4602 2nd Street, Suite 3  
Davis, CA 95618  
530.758.1270 tel | 530.758.4789 fax

CONSULTANTS:

STAMPS OF RECORD:

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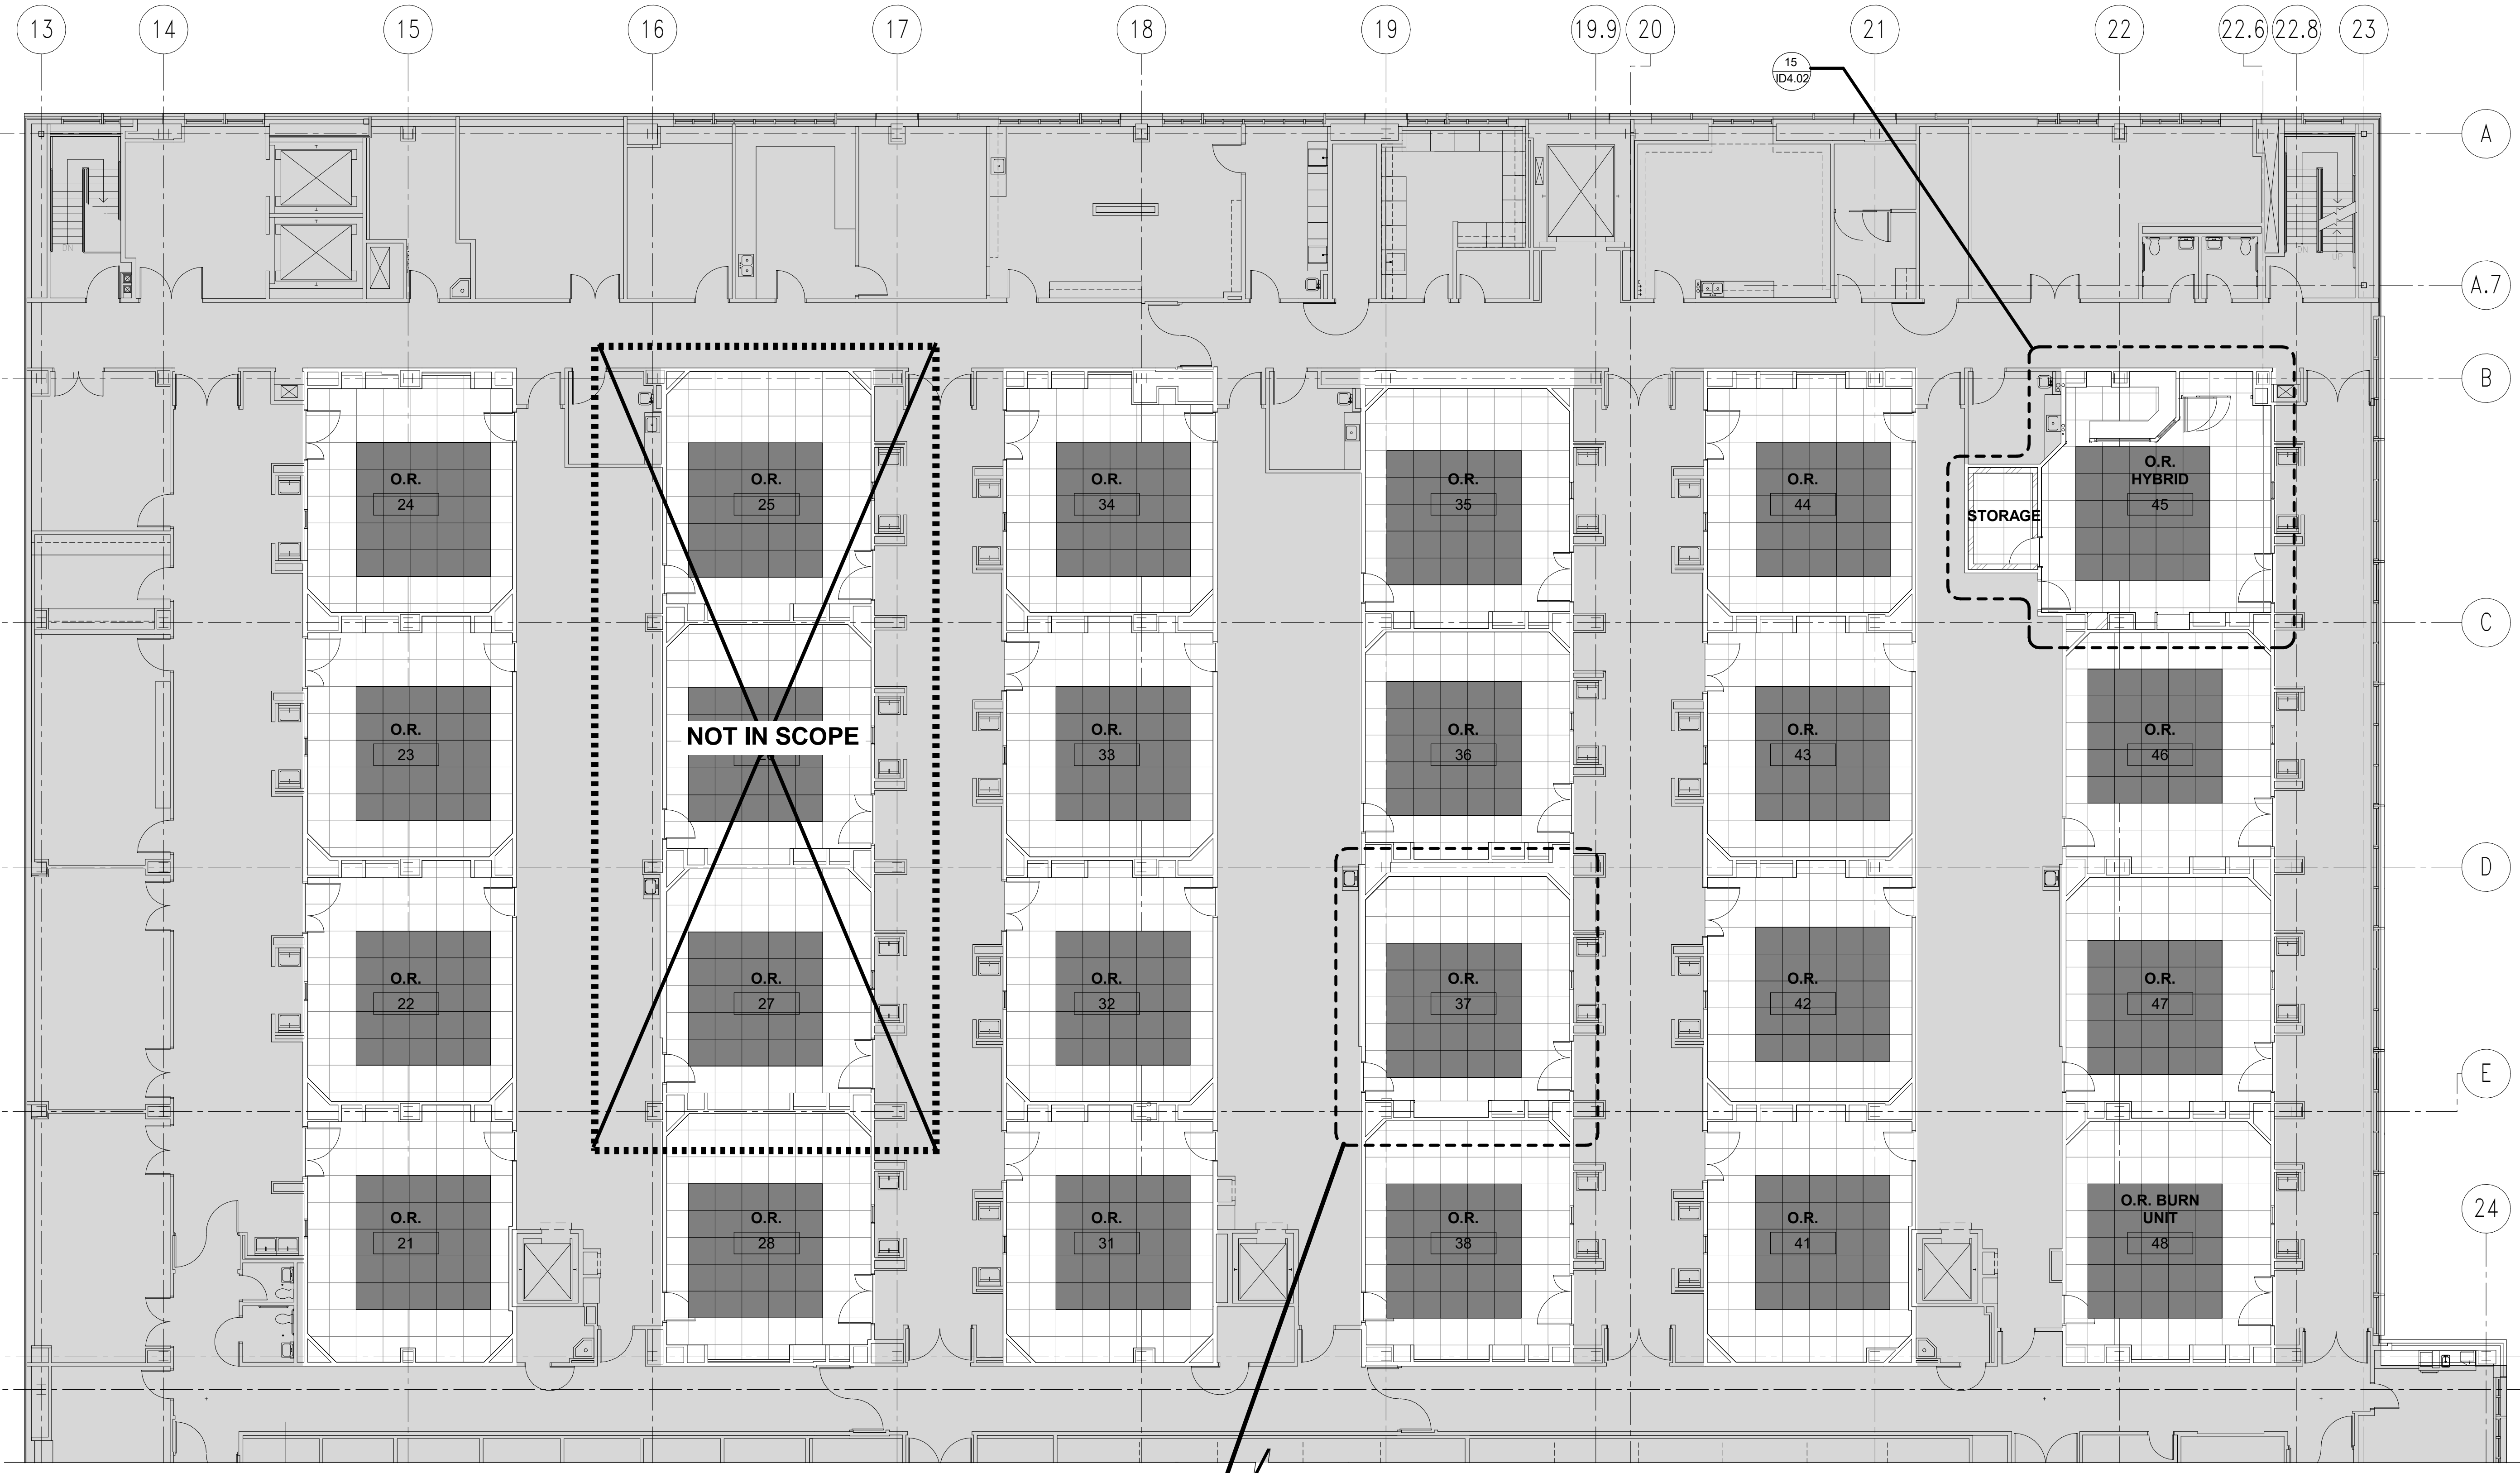
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FD&C #: M056973

100% CONSTRUCTION DOCUMENTS

**SESP OR PO&M FLOORING REPLACEMENT DETAILS**

ACCOUNT NO:			
ROOM:			
BUILDING:			
FLOORING:	3		
PROJECT TITLE:			
ARCH/ENGR:	KEN Y.	HY JOB NO:	5839
UCDMG PROJECT MGR:	ATOSA A.	SCALE:	6" = 1'-0"
DESIGNED BY:	PP	ISSUE DATE:	7/25/2022
DRAWN BY:	PP	REVIT VERSION:	2019
		SHEET NO:	<b>A9.01</b>
			7 of 16 SHEETS



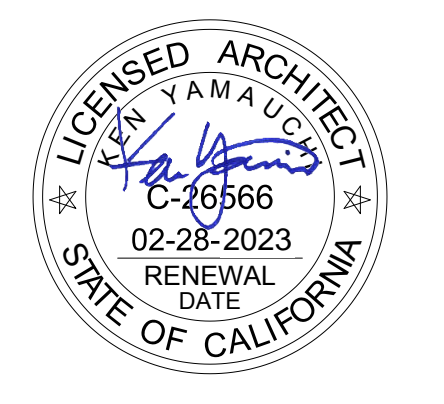
**GENERAL FINISH NOTES**

- CONTRACTOR TO VERIFY (E) CONDITIONS AND NOTIFY ARCHITECT OF ANY IN THE FIELD DISCREPANCIES PRIOR TO START OF CONSTRUCTION.
- CONTRACTOR TO VERIFY ACCURACY OF ALL (E) DIMENSIONS AND NOTIFY ARCHITECT OF ANY CONFLICTS PRIOR TO PERFORMING NEW WORK.
- ALL (E) WALLS WITH (E) FINISHES TO REMAIN ARE DIMENSIONED TO FACE OF FINISH.
- PROTECT ALL (E) FINISHES TO REMAIN DURING CONSTRUCTION.
- PATCH & REPAIR WALLS & FLOORS THAT ARE (E) TO REMAIN AND AFFECTED BY THE WORK.
- GROUT FILL ALL HOLES IN WALL WHERE ARE REMOVED AND RELOCATED.
- GENERAL CONTRACTORS & SUB-CONTRACTORS SHALL TEST FLOORING SUBSTRATE FOR ALL FLOORING MANUFACTURER REQUIRED TESTING INCLUDING MOISTURE CONTENT, POROSITY & RADIANT HEAT LEVELS. SUBMIT TEST RESULTS FOR ARCHITECTS REVIEW PRIOR TO ORDERING FLOORING & START OF INSTALLATION.
- GENERAL CONTRACTOR & SUB-CONTRACTORS TO VERIFY LEAD TIMES ON ALL PRODUCTS IMMEDIATELY UPON PROJECT AWARDMENT. SOME PRODUCTS REQUIRE 6-12 WEEKS LEAD TIME AND SUBSTITUTIONS ARE NOT ALLOWED, UON.
- REFER TO FINISH SCHEDULE, INTERIOR ELEVATIONS AND SPECIFICATIONS FOR ADDITIONAL FINISH INFORMATION.
- INTERIOR FLOOR FINISH AND COVERINGS TO COMPLY WITH 2019 CBC SECTION 804, TESTED IN ACCORDANCE WITH NFPA 253, TO COMPLY WITH ASTM E 648. HAVE A SPECIFIC OPTICAL DENSITY SMOKE RATING NOT TO EXCEED 450 PER ASTM E 682, AND MINIMUM CRITICAL RADIANT FLUX NOT LESS THAN CLASS II. SEE SPECIFICATIONS FOR MORE INFORMATION.

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**LEGEND**

- FIELD TILE
- ACCENT TILE
- NOT IN SCOPE

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100% CONSTRUCTION DOCUMENTS

**SESP OR PO&M FLOORING REPLACEMENT ENLARGED FINISH PLAN**

**30 ENLARGED THIRD FLOOR FINISH PLAN - NORTH**  
 3/32" = 1'-0"

ACCOUNT NO.:	ARCH/ENGR:	HY JOB NO.:	SHEET NO.:
	KEN Y.	5839	
	UCDMG PROJECT MGR.:	SCALE:	<b>ID4.01</b>
	ATOSA A.	As indicated	
	DESIGNED BY:	ISSUE DATE:	
	PP	7/25/2022	
	DRAWN BY:	REVTY VERSION:	
	PP	2019	8 of 16 SHEETS



FINISH SCHEDULE					
CODE	PRODUCT DESCRIPTION	MANUFACTURER	MODEL INFORMATION	COLOR & FINISH INFORMATION	FIRE RATING / FLAME SPREAD
FLOORING					
RF1	RESILIENT RUBBER TILE, FIELD; 6" INTEGRAL COVERED BASE, WHERE APPLIES; COLD WELDED SEAMS	NORA	COLLECTION: NORAMENT; SERIES NAME: XP; SIZE: 39.53" x 39.53" x .14"	COLOR NO.: 5110; COLOR NAME: ARA; FINISH: HAMMERED; COLD WELDED SEAMS TO MATCH	CLASS A / 450
RF2	RESILIENT RUBBER TILE, ACCENT; COLD WELDED SEAMS	NORA	COLLECTION: NORAMENT; SERIES NAME: XP; SIZE: 39.53" x 39.53" x .14"	COLOR NO.: 5111; COLOR NAME: CASTOR; FINISH: HAMMERED; COLD WELDED SEAMS TO MATCH	CLASS A / 450

**GENERAL FINISH NOTES**

- CONTRACTOR TO VERIFY (E) CONDITIONS AND NOTIFY ARCHITECT OF ANY IN THE FIELD DISCREPANCIES PRIOR TO START OF CONSTRUCTION.
- CONTRACTOR TO VERIFY ACCURACY OF ALL (E) DIMENSIONS AND NOTIFY ARCHITECT OF ANY CONFLICTS PRIOR TO PERFORMING NEW WORK.
- ALL (E) WALLS WITH (E) FINISHES TO REMAIN ARE DIMENSIONED TO FACE OF FINISH.
- PROTECT ALL (E) FINISHES TO REMAIN DURING CONSTRUCTION.
- PATCH & REPAIR WALLS & FLOORS THAT ARE (E) TO REMAIN AND AFFECTED BY THE WORK.
- GROUT FILL ALL HOLES IN WALL WHERE ARE REMOVED AND RELOCATED.
- GENERAL CONTRACTORS & SUB-CONTRACTORS SHALL TEST FLOORING SUBSTRATE FOR ALL FLOORING MANUFACTURER REQUIRED TESTING INCLUDING MOISTURE CONTENT, POROSITY & RADIANT HEAT LEVELS. SUBMIT TEST RESULTS FOR ARCHITECTS REVIEW PRIOR TO ORDERING FLOORING & START OF INSTALLATION.
- GENERAL CONTRACTOR & SUB-CONTRACTORS TO VERIFY LEAD TIMES ON ALL PRODUCTS IMMEDIATELY UPON PROJECT AWARDMENT. SOME PRODUCTS REQUIRE 6-12 WEEKS LEAD TIME AND SUBSTITUTIONS ARE NOT ALLOWED, UON.
- REFER TO FINISH SCHEDULE, INTERIOR ELEVATIONS AND SPECIFICATIONS FOR ADDITIONAL FINISH INFORMATION.
- INTERIOR FLOOR FINISH AND COVERINGS TO COMPLY WITH 2019 CBC SECTION 804, TESTED IN ACCORDANCE WITH NFPA 253, TO COMPLY WITH ASTM E 648, HAVE A SPECIFIC OPTICAL DENSITY SMOKE RATING NOT TO EXCEED 450 PER ASTM E 682, AND MINIMUM CRITICAL RADIANT FLUX NOT LESS THAN CLASS II. SEE SPECIFICATIONS FOR MORE INFORMATION.

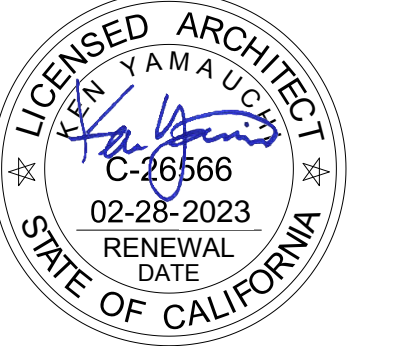
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HY ARCHITECTS PROJECT #: 5839

**HIBSER YAMAUCHI Architects, Inc.**  
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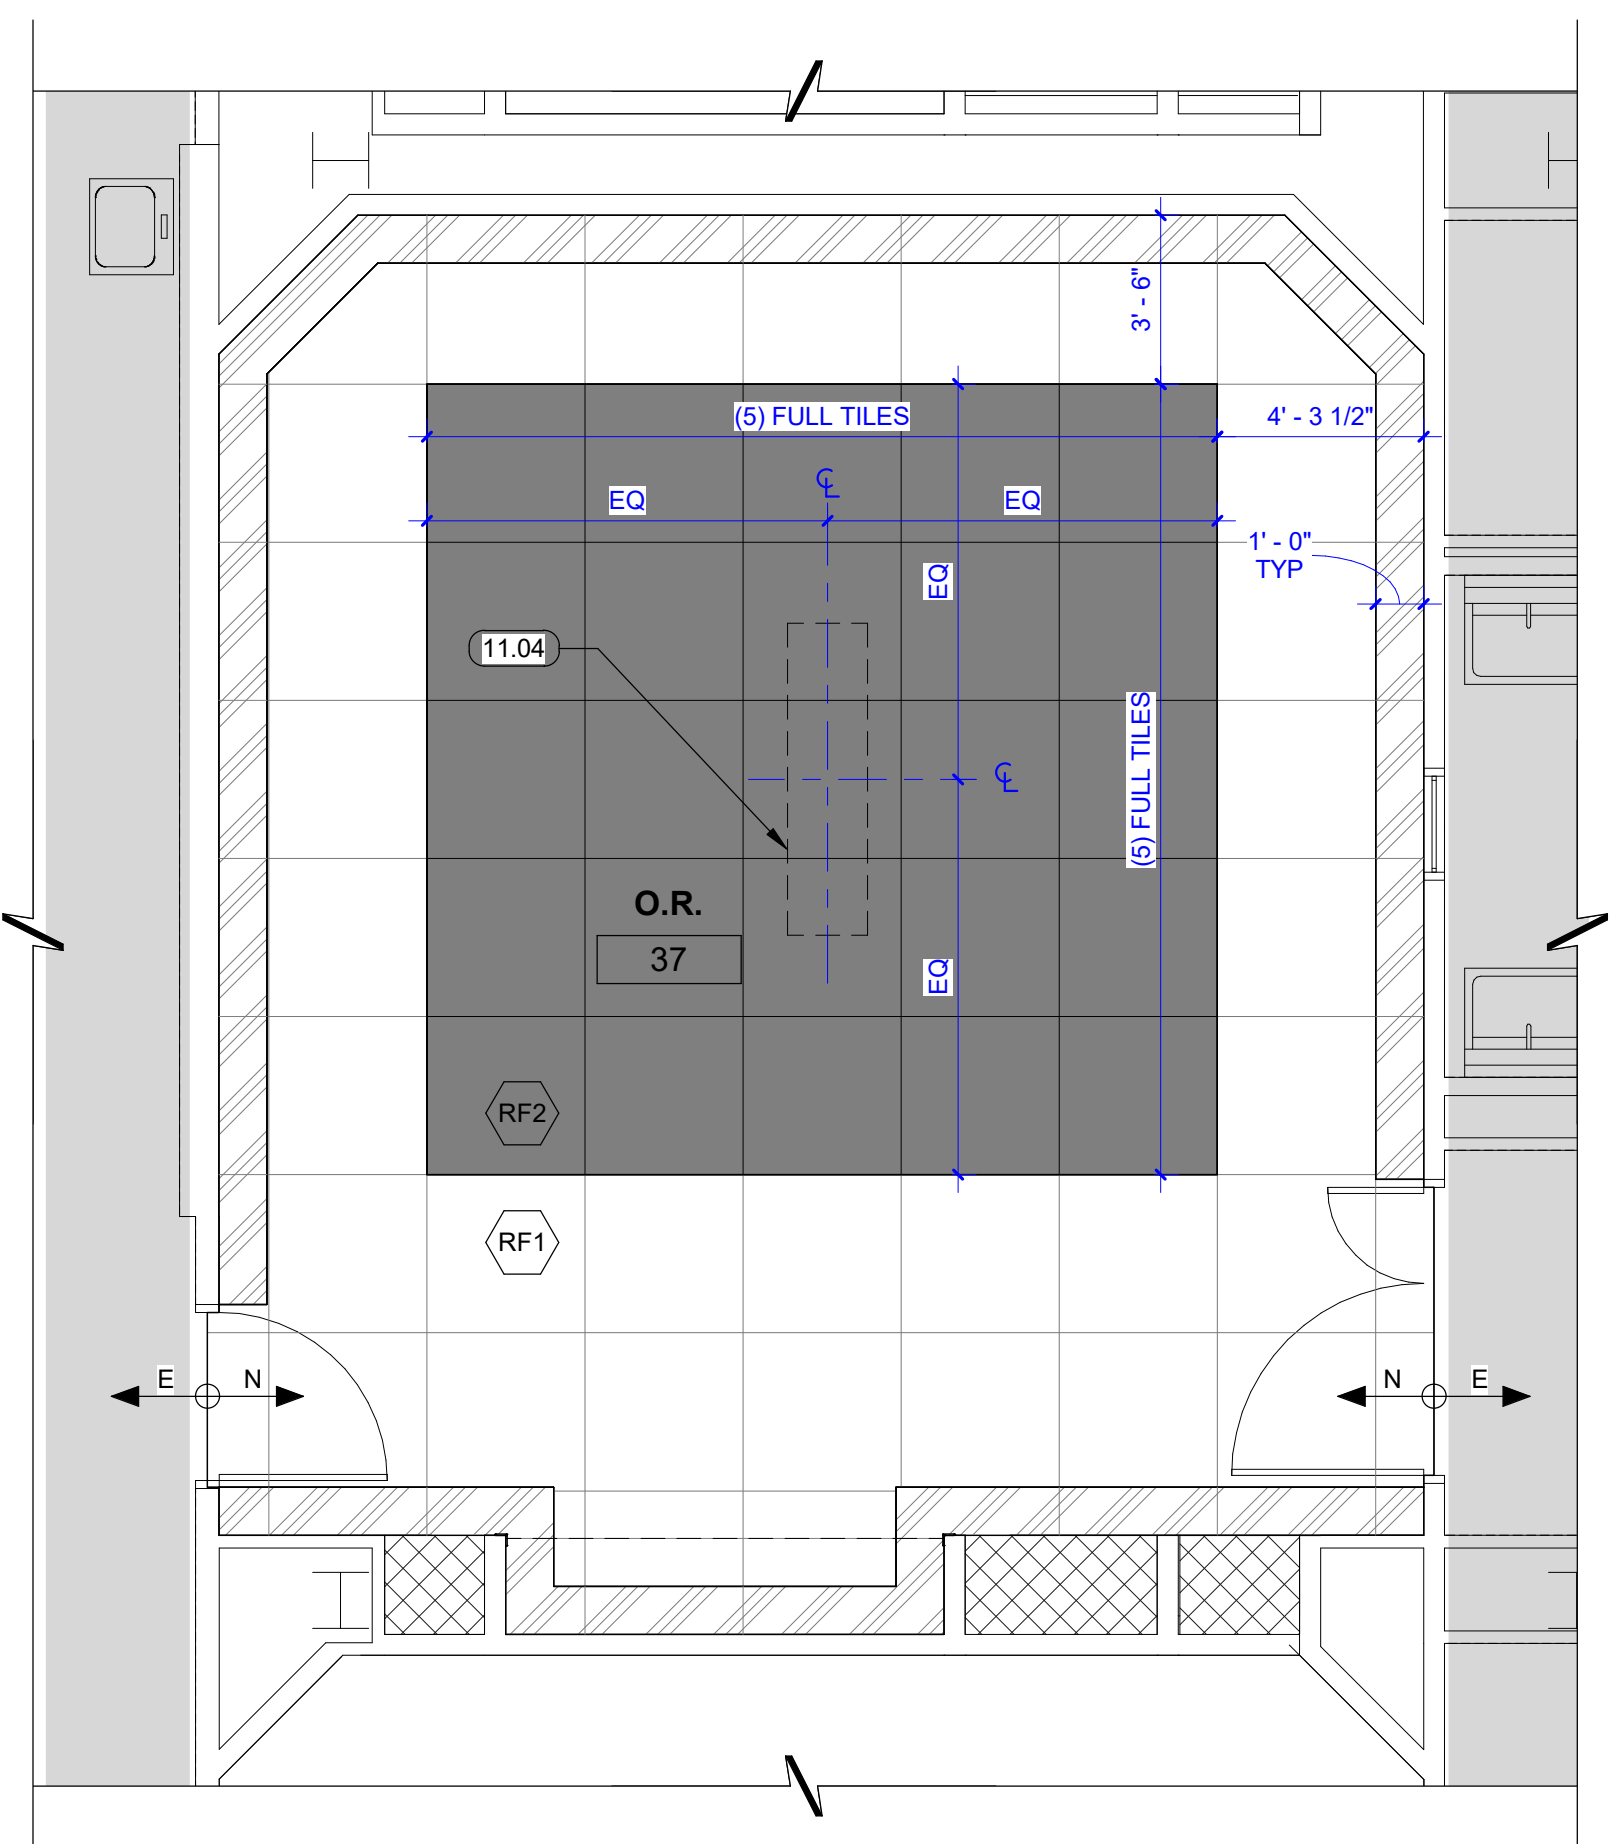
**LEGEND**

- FIELD TILE
- ACCENT TILE
- START OF (N) FIELD TILE W/ INTEGRAL COVE
- (E) EQUIPMENT TO REMAIN
- NOT IN SCOPE
- INDICATES EXTENT OF EXISTING (E) & NEW (N) FLOORING
- INDICATES FLOORING FINISH

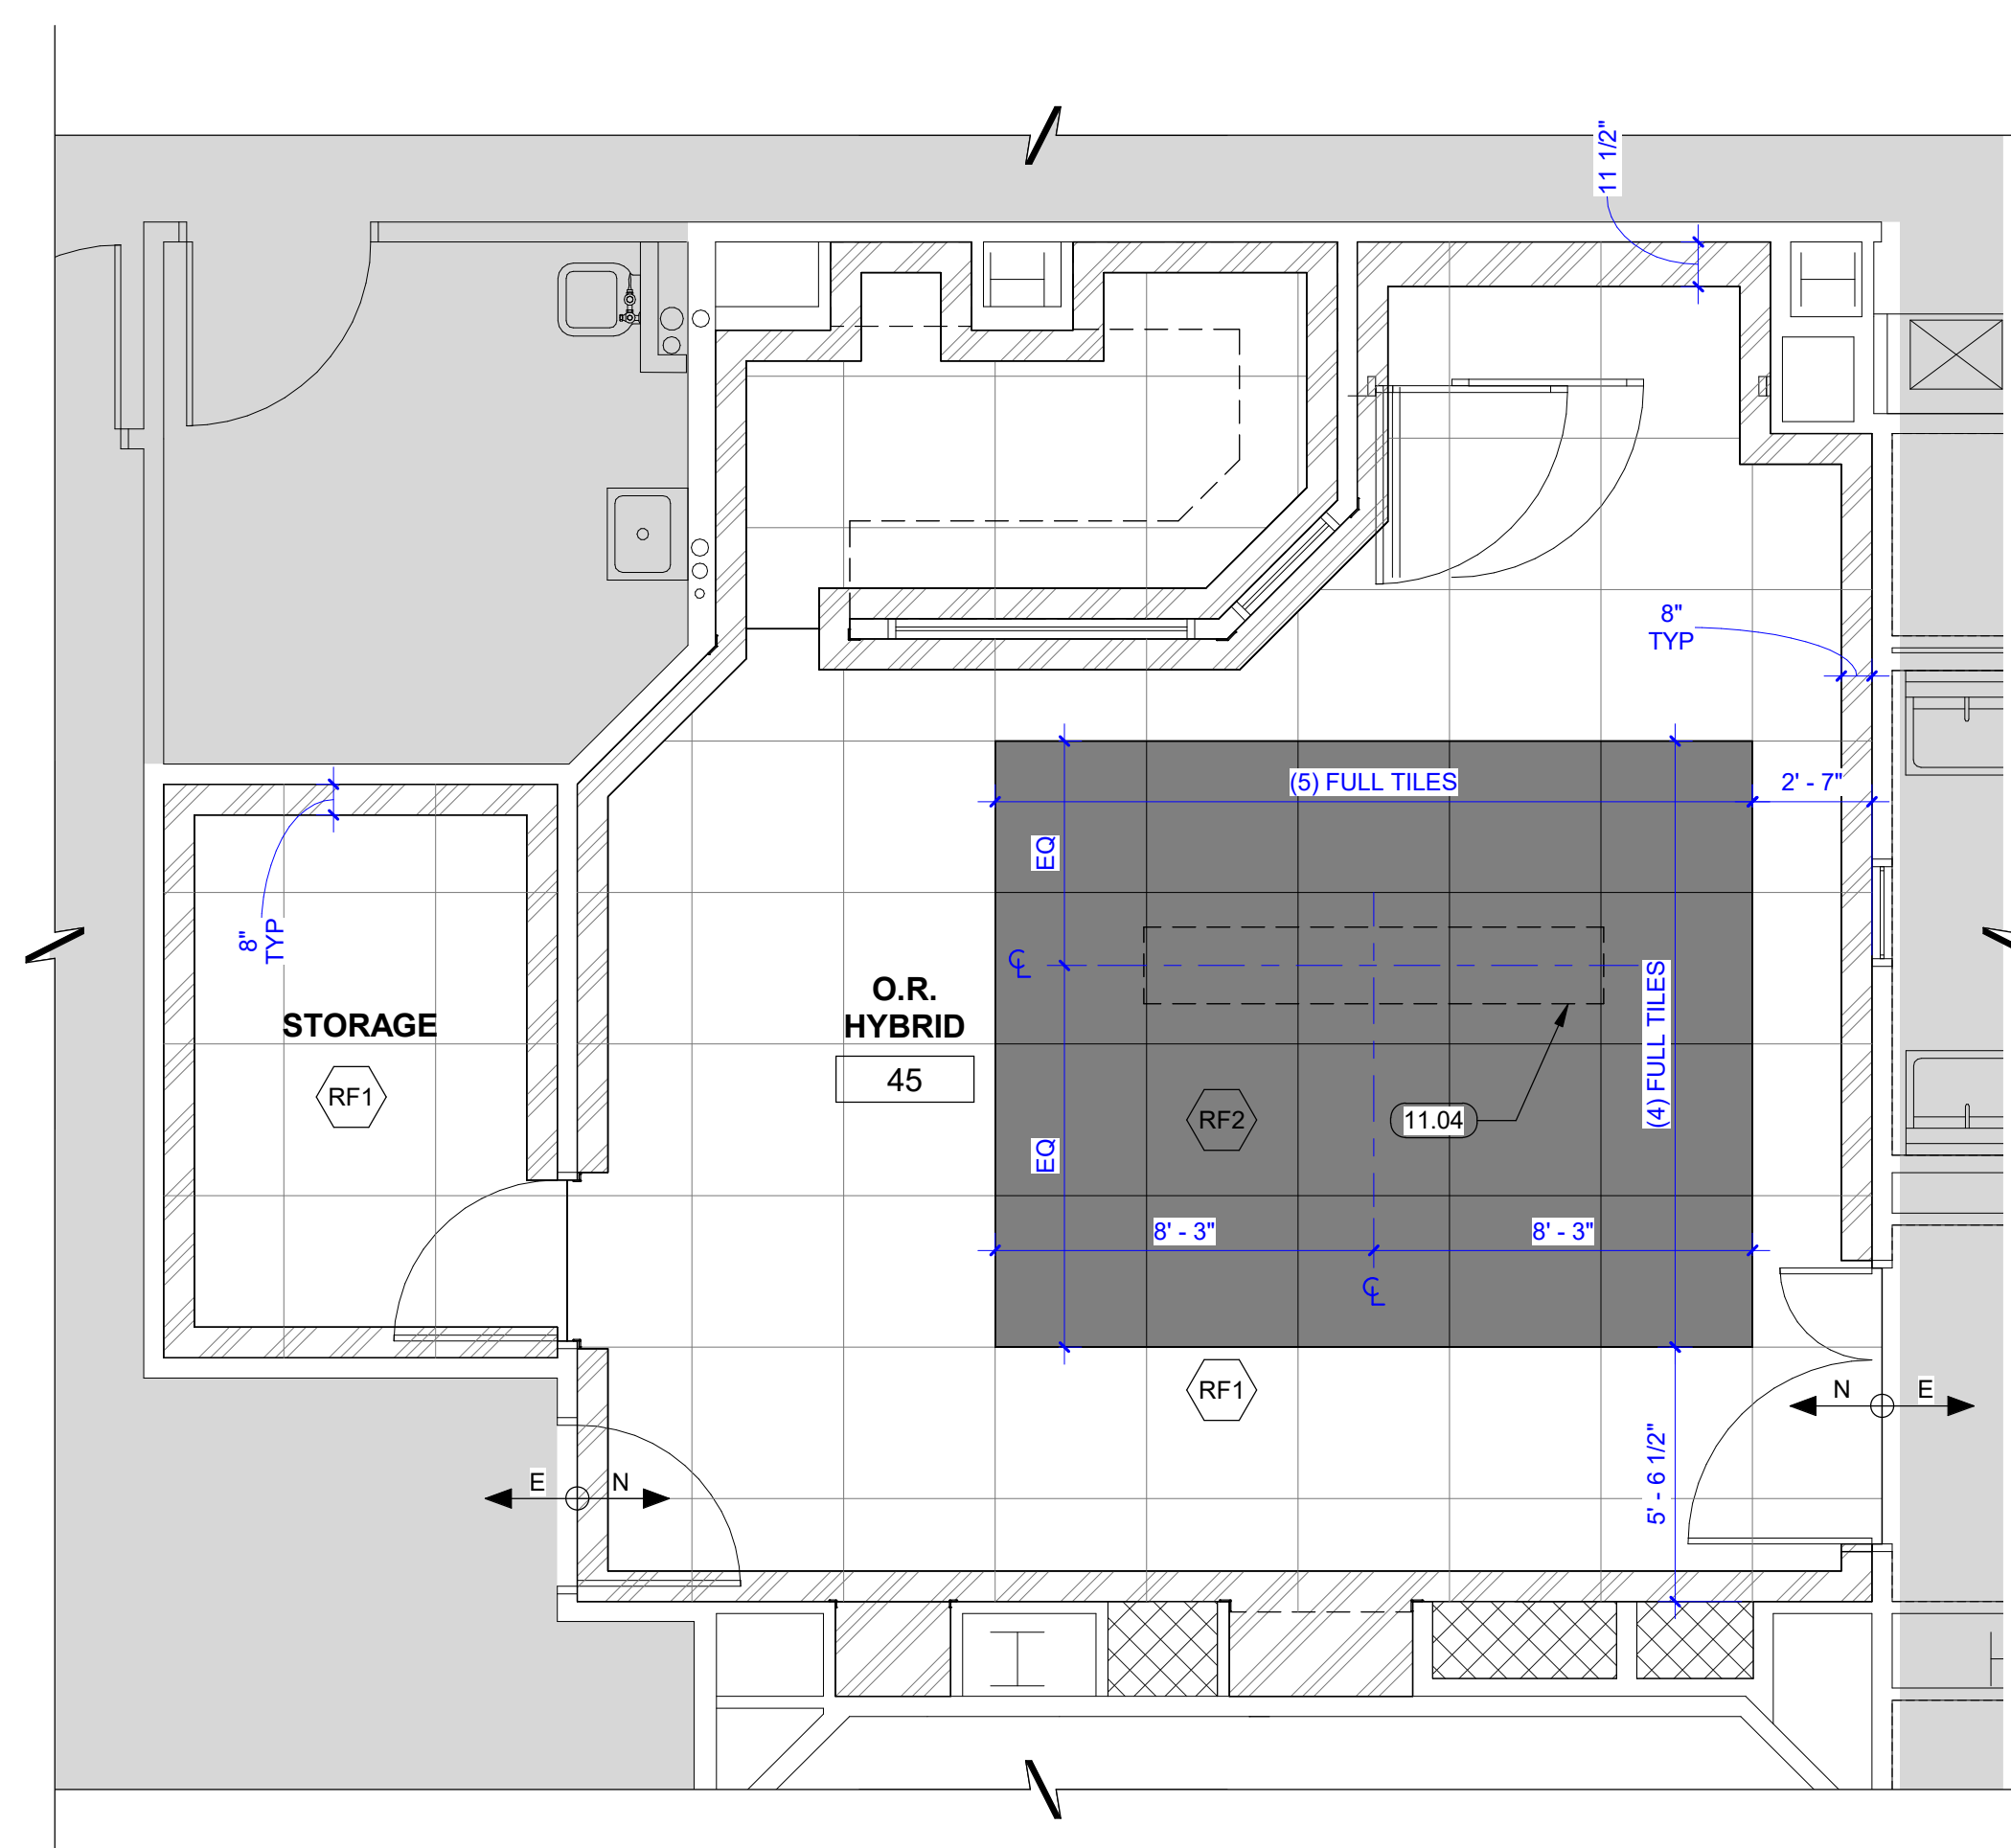
**REMODEL NOTES**

11.04 (E) SURGICAL TABLE TO REMAIN.

**13 ENLARGED FINISH PLAN - TYP OPERATING ROOM, #37 (#48 SIM)**  
 1/4" = 1'-0"



**15 ENLARGED FINISH PLAN - HYBRID OPERATING ROOM, #45**  
 1/4" = 1'-0"



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 REVIEWED FOR CODE COMPLIANCE  
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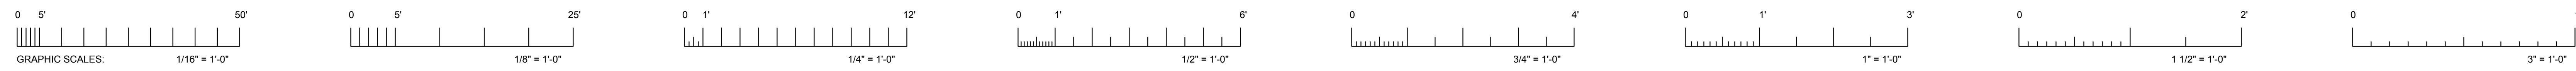
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**SESP OR PO&M FLOORING REPLACEMENT ENLARGED FINISH PLANS**

ACCOUNT NO.	HY JOB NO.	SHEET NO.
ARCH/ENGR	5839	
UCDMG PROJECT MGR	SCALE	<b>ID4.02</b>
ATOSA A.	1/4" = 1'-0"	
DESIGNED BY	ISSUE DATE	
PP	7/25/2022	
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PP	2019	



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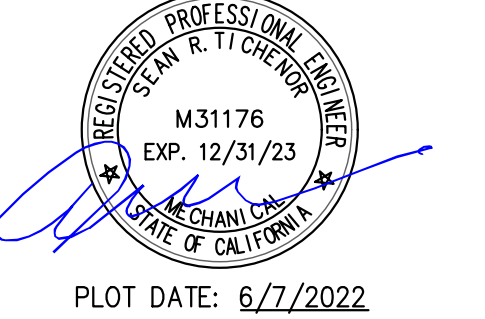
- SHEET NOTES:**
- ALL EXISTING EQUIPMENT, DUCTWORK, TERMINALS, ETC. SHOWN ON PLANS ARE BASED ON AVAILABLE EXISTING DRAWINGS AND LIMITED SITE SURVEYS, AND SHOWN FOR REFERENCE ONLY.
  - SEE DETAILED SCOPE OF WORK ON SHEET **M2.02**.



HY ARCHITECTS PROJECT #: 5839  
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 4602 2nd Street, Suite 3  
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CONSULTANTS:  
 7750 College Town Dr. ste.101  
 Sacramento, CA 95826  
 Tel (916) 447-2841  
 www.peterseng.com  
 job no. 22.016  
 consulting mechanical and electrical engineers

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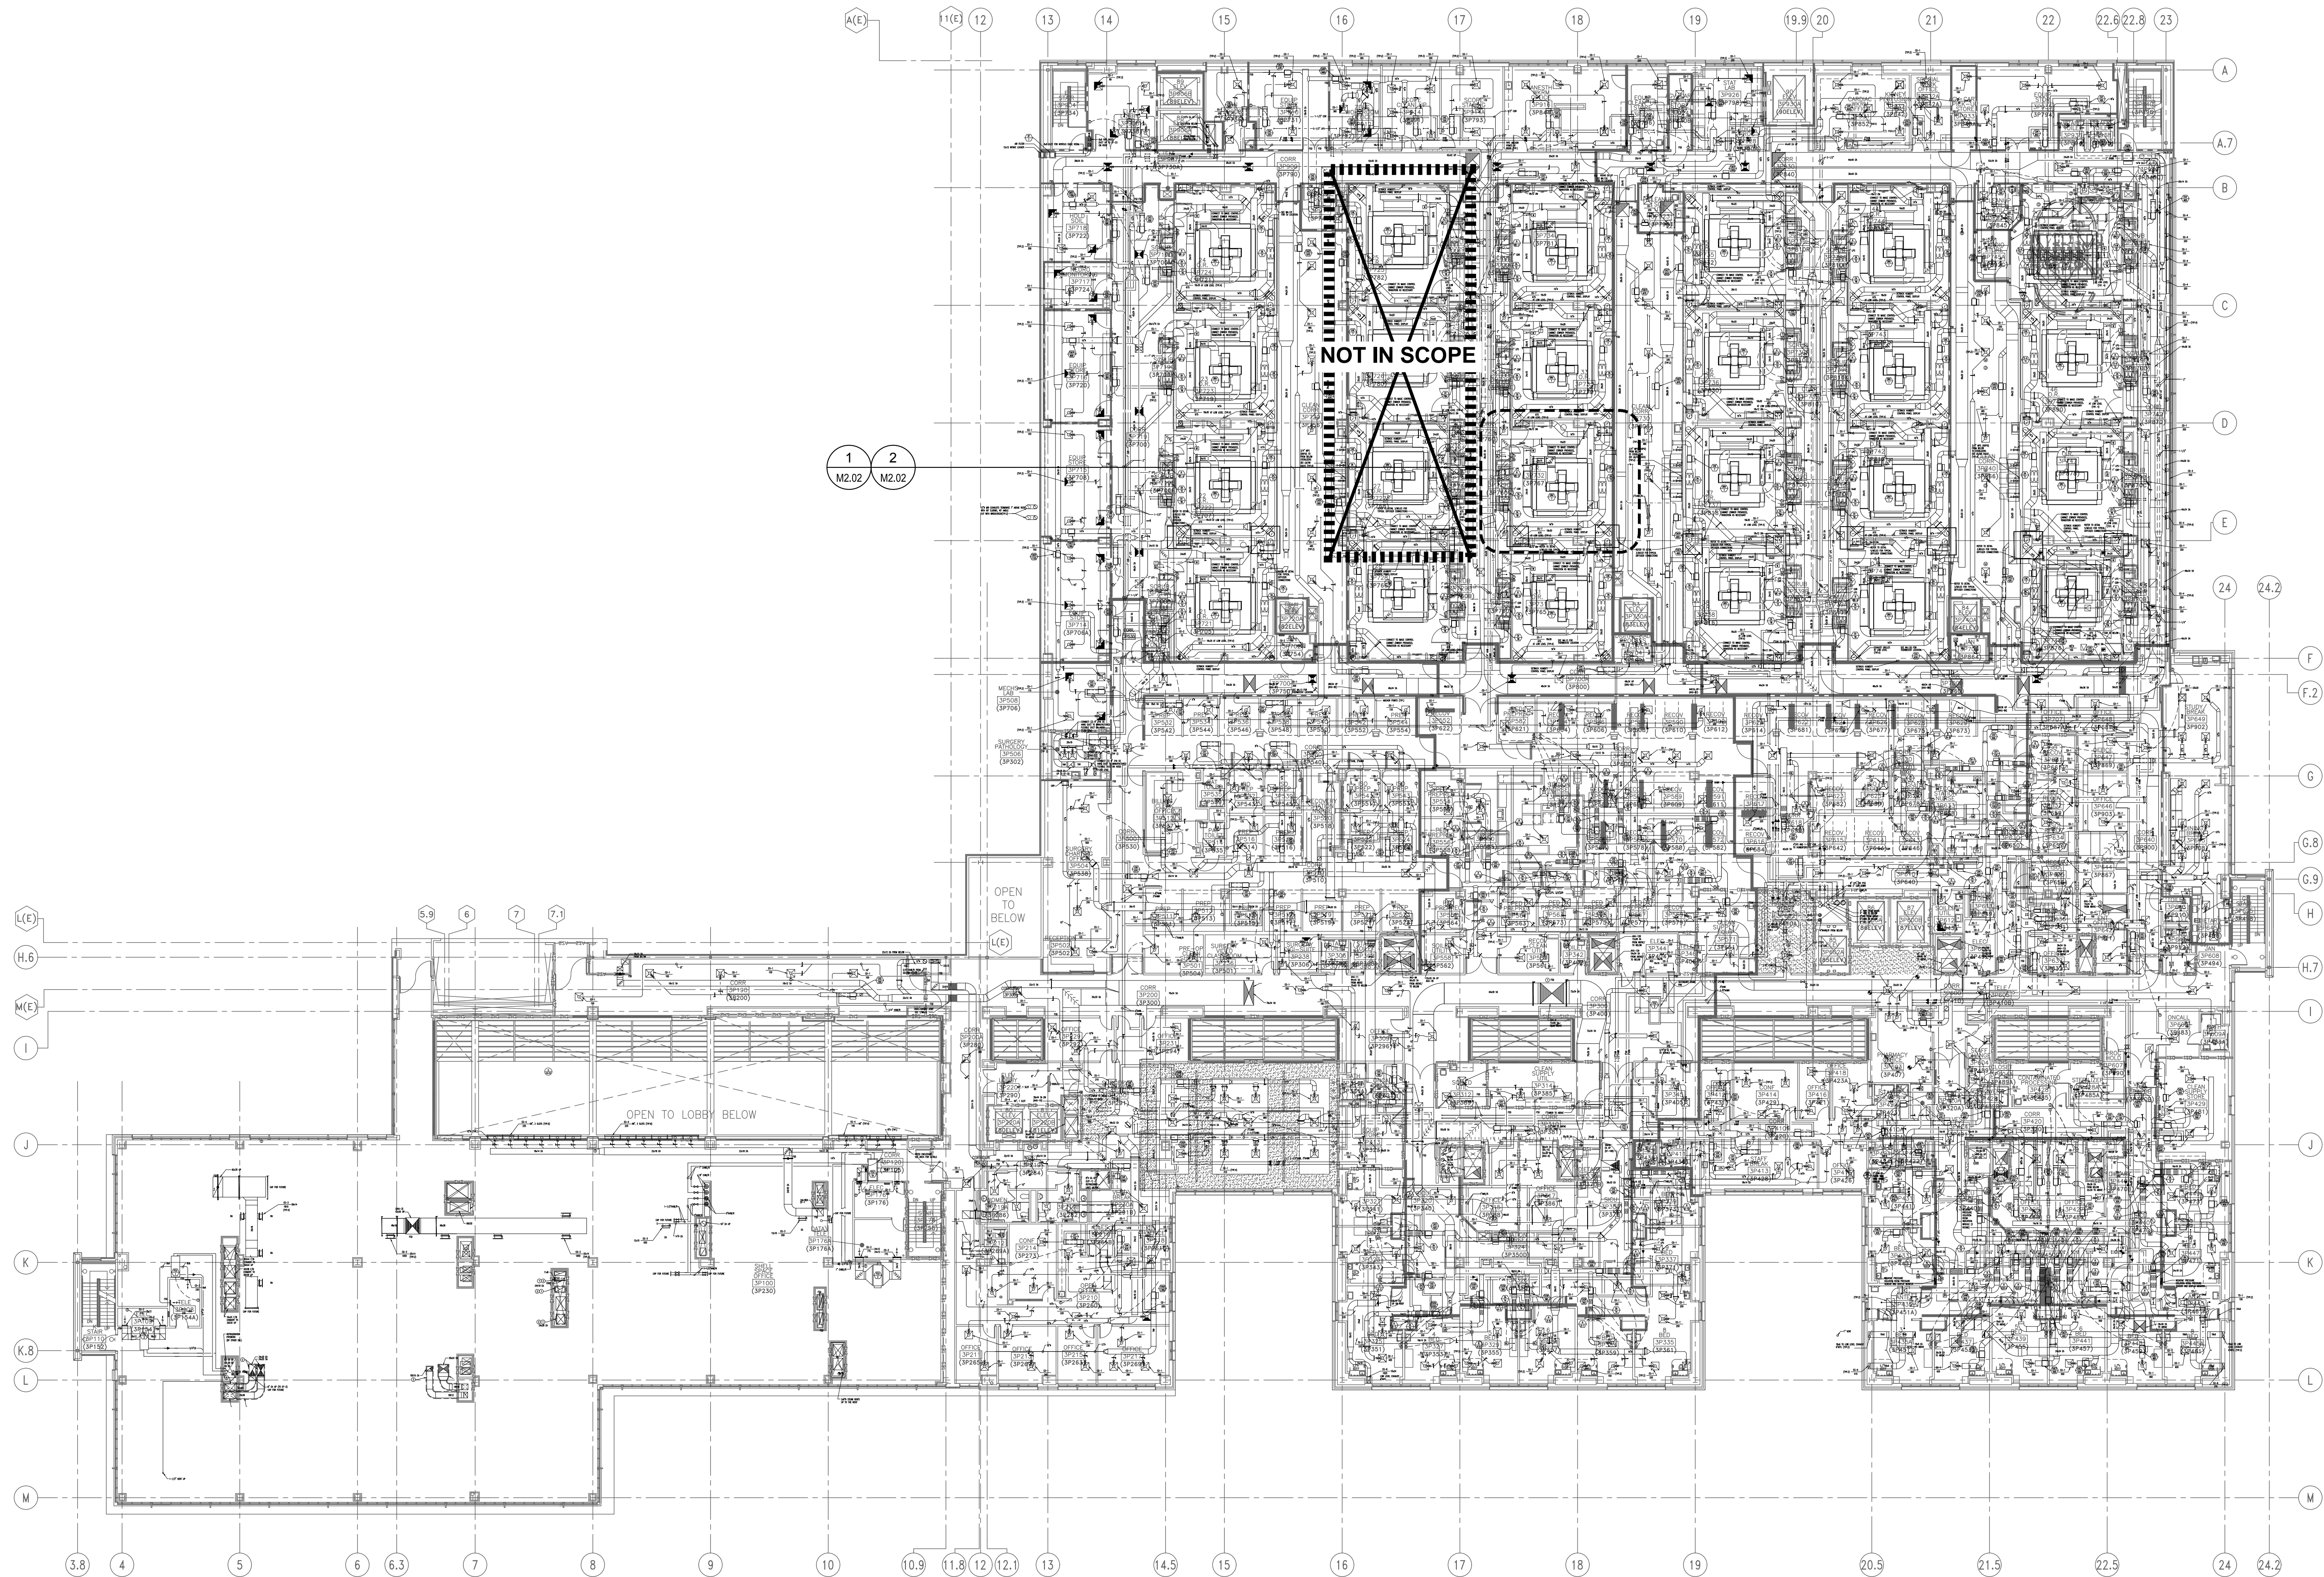
PLOT DATE: 6/7/2022

THIS ISSUE:	ISSUED FOR:	Date

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FOR REFERENCE ONLY

**SESP OR PO&M FLOORING REPLACEMENT**  
**OVERALL THIRD FLOOR PLAN - MECHANICAL**



**1 OVERALL THIRD FLOOR PLAN - MECHANICAL**  
 SCALE: 1"=20'

**MECHANICAL SHEET LIST**  
 Sheet Number Sheet Title

ACCOUNT NO:	ARCH-ENGR:	HY JOB NO:	SHEET NO:
	ST	5839	
	UCDMC PROJECT MGR:	SCALE:	<b>M2.01</b>
	ATOSA A.		
	DESIGNED BY:	ISSUE DATE:	
	RM	7/25/2022	
	DRAWN BY:	REVIT VERSION:	
	RM	2019	OF 16 SHEETS



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**PROFESSIONAL SEAL**  
REGISTERED MECHANICAL ENGINEER  
M31176  
EXP. 12/31/23  
STATE OF CALIFORNIA  
PLOT DATE: 6/7/2022

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**SHEET NOTES:**

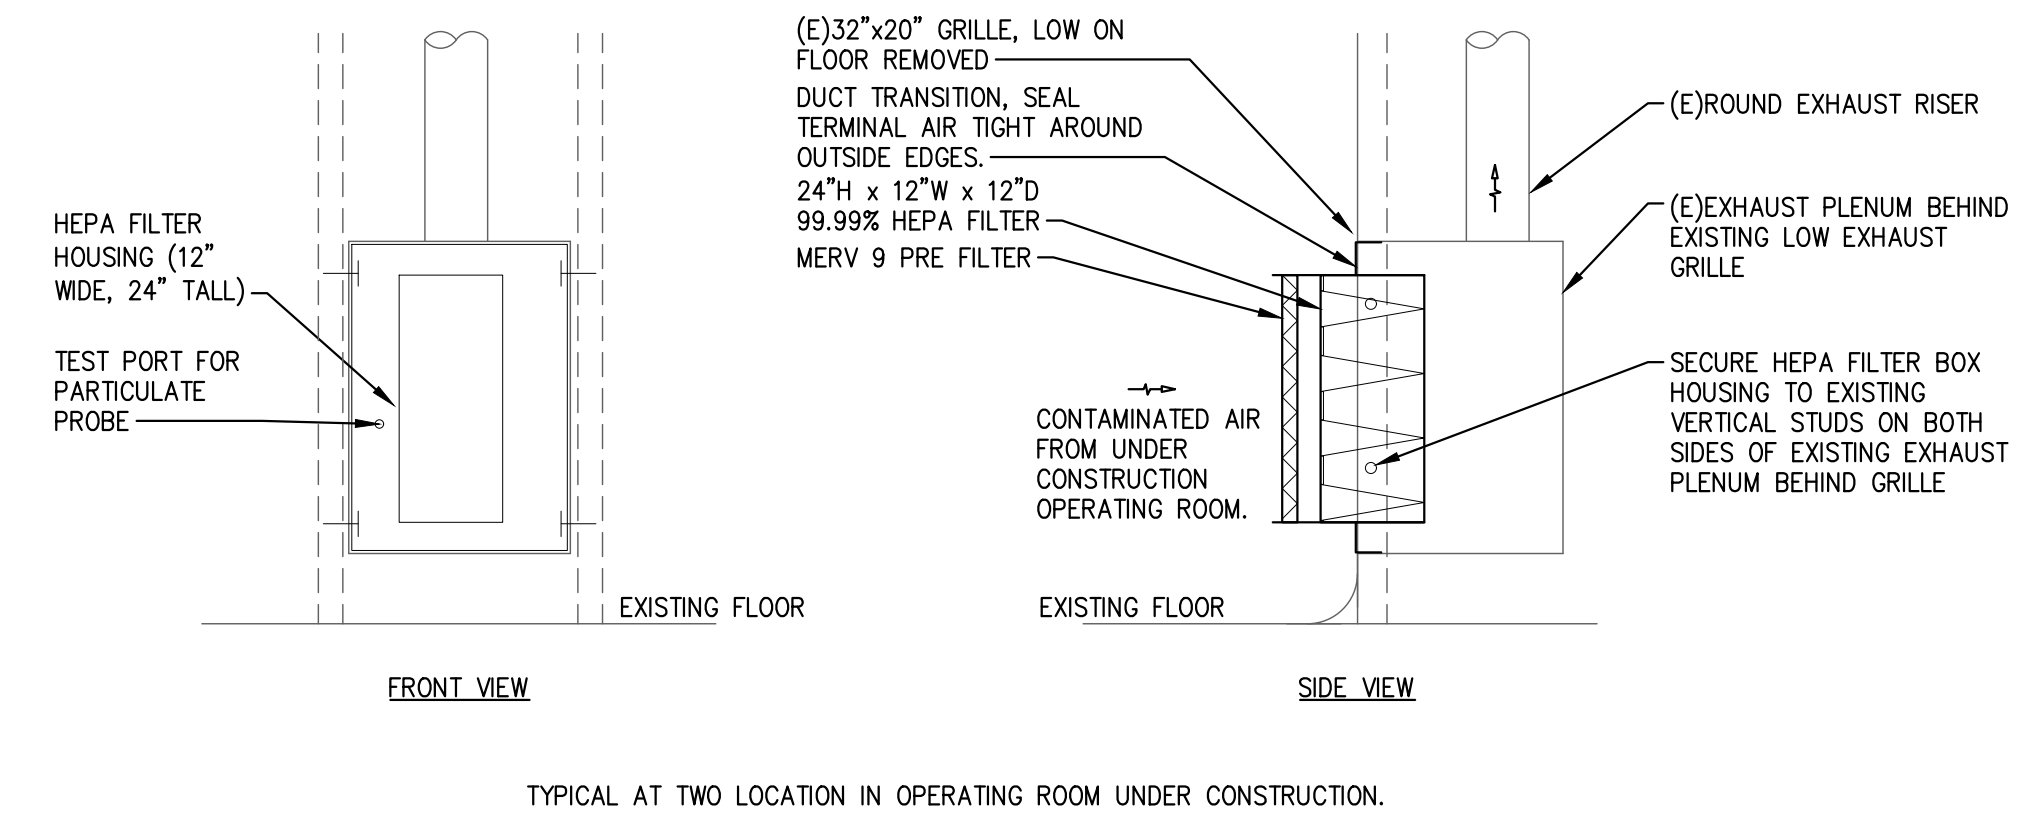
- ALL EXISTING EQUIPMENT, DUCTWORK, TERMINALS, ETC. SHOWN ON PLANS ARE BASED ON AVAILABLE EXISTING DRAWINGS AND LIMITED SITE SURVEYS, AND SHOWN FOR REFERENCE ONLY.
- PRIOR TO CONSTRUCTION, THE CONTRACTOR SHALL PRE-READ ALL SUPPLY AND EXHAUST AIRFLOWS ACROSS THE CAV BOXES SERVING THE UNDER CONSTRUCTION OPERATING ROOM. THE CONTRACTOR SHALL MEASURE THE SUPPLY AND EXHAUST AIR FLOW AT THE ADJACENT SCRUB AND STERILE CORRIDORS.
- AFTER CONSTRUCTION IS COMPLETE, THE ANTE ROOM WILL BE DECONSTRUCTED, ALL TEMPORARY AIR OUTLETS AND DOORWAYS THAT WERE SEALED SHALL BE RESTORED AND A POST CONSTRUCTION AIR BALANCE SHALL BE PROVIDED TO RESTORE ALL AIR OUTLETS AND CAV BOXES TO THEIR PREVIOUSLY MEASURED VALUES. ANY AIR TERMINALS THAT WERE RELOCATED DUE TO THE LOCATION OF THE ANTE ROOM SHALL BE RETURNED TO THEIR ORIGINAL LOCATIONS PRIOR TO FINAL AIR BALANCING.
- OPERATING ROOM 32 SHOWN HERE IS EXAMPLE OF A TYPICAL OPERATING ROOM BALANCING AND CONSTRUCTION PROCEDURE. THIS IS TYPICAL FOR ALL OPERATING ROOMS IN THE SCOPE OF WORK.
- LOCATIONS WHERE OPERATING ROOMS ARE ON THE OPPOSITE SIDE OF THE SCRUB CORRIDOR, THE OPERATING ROOM IS A MIRRORED IMAGE.

**KEYED NOTES - OPTION 1:**

- PRIOR TO CONSTRUCTION, SEAL ALL SUPPLY AIR OPENINGS INTO THE UNDER CONSTRUCTION OPERATING ROOM, TYPICAL.
- PRIOR TO CONSTRUCTION, DEACTIVATE THE SUPPLY CAV SERVING THE OPERATING ROOM.
- PRIOR TO CONSTRUCTION, SEAL THE DOORWAY TO THE STERILE CORRIDOR.
- CONSTRUCT A NEGATIVELY PRESSURIZED ANTE ROOM AT THE SCRUB CORRIDOR ENTRANCE.
- PLACE HEPA FILTER BOXES AT TWO OF THE EXISTING EXHAUST AIR INLETS IN THE OPERATING ROOM. THE EXISTING HOUSE EXHAUST SYSTEM SHALL MAINTAIN A NEGATIVE PRESSURE THROUGH THE CONSTRUCTED ANTE ROOM (-0.020" W.C.) AT ALL TIMES DURING CONSTRUCTION. MAKEUP AIR FOR THE OPERATING ROOM WILL BE DRAWN FROM THE EXISTING SCRUB CORRIDOR. SEE DETAIL **M2.02** FOR FILTER BOX CONSTRUCTION.
- TEMPORARILY REBALANCE THE NEGATIVELY PRESSURIZED SCRUB CORRIDOR TO ACCOUNT FOR THE LOSS OF POSITIVE AIRFLOW PROVIDED BY THE UNDER CONSTRUCTION OPERATING ROOM AND THE ADDITIONAL AIRFLOW REQUIRED TO KEEP THE ANTE ROOM AT -0.020" W.C. RELOCATE EXISTING AIR TERMINALS IMPACTED BY THE PROVISION OF THE ANTE ROOM (OR OFFSET ANTE ROOM CONSTRUCTION AROUND TERMINALS TO KEEP THEM IN THE SCRUB CORRIDOR THROUGHOUT CONSTRUCTION).
- SEAL OFF EXHAUST OPENING IN OPERATING ROOM, TYPICAL OF 3 OUT OF 5 EXHAUST OPENINGS.

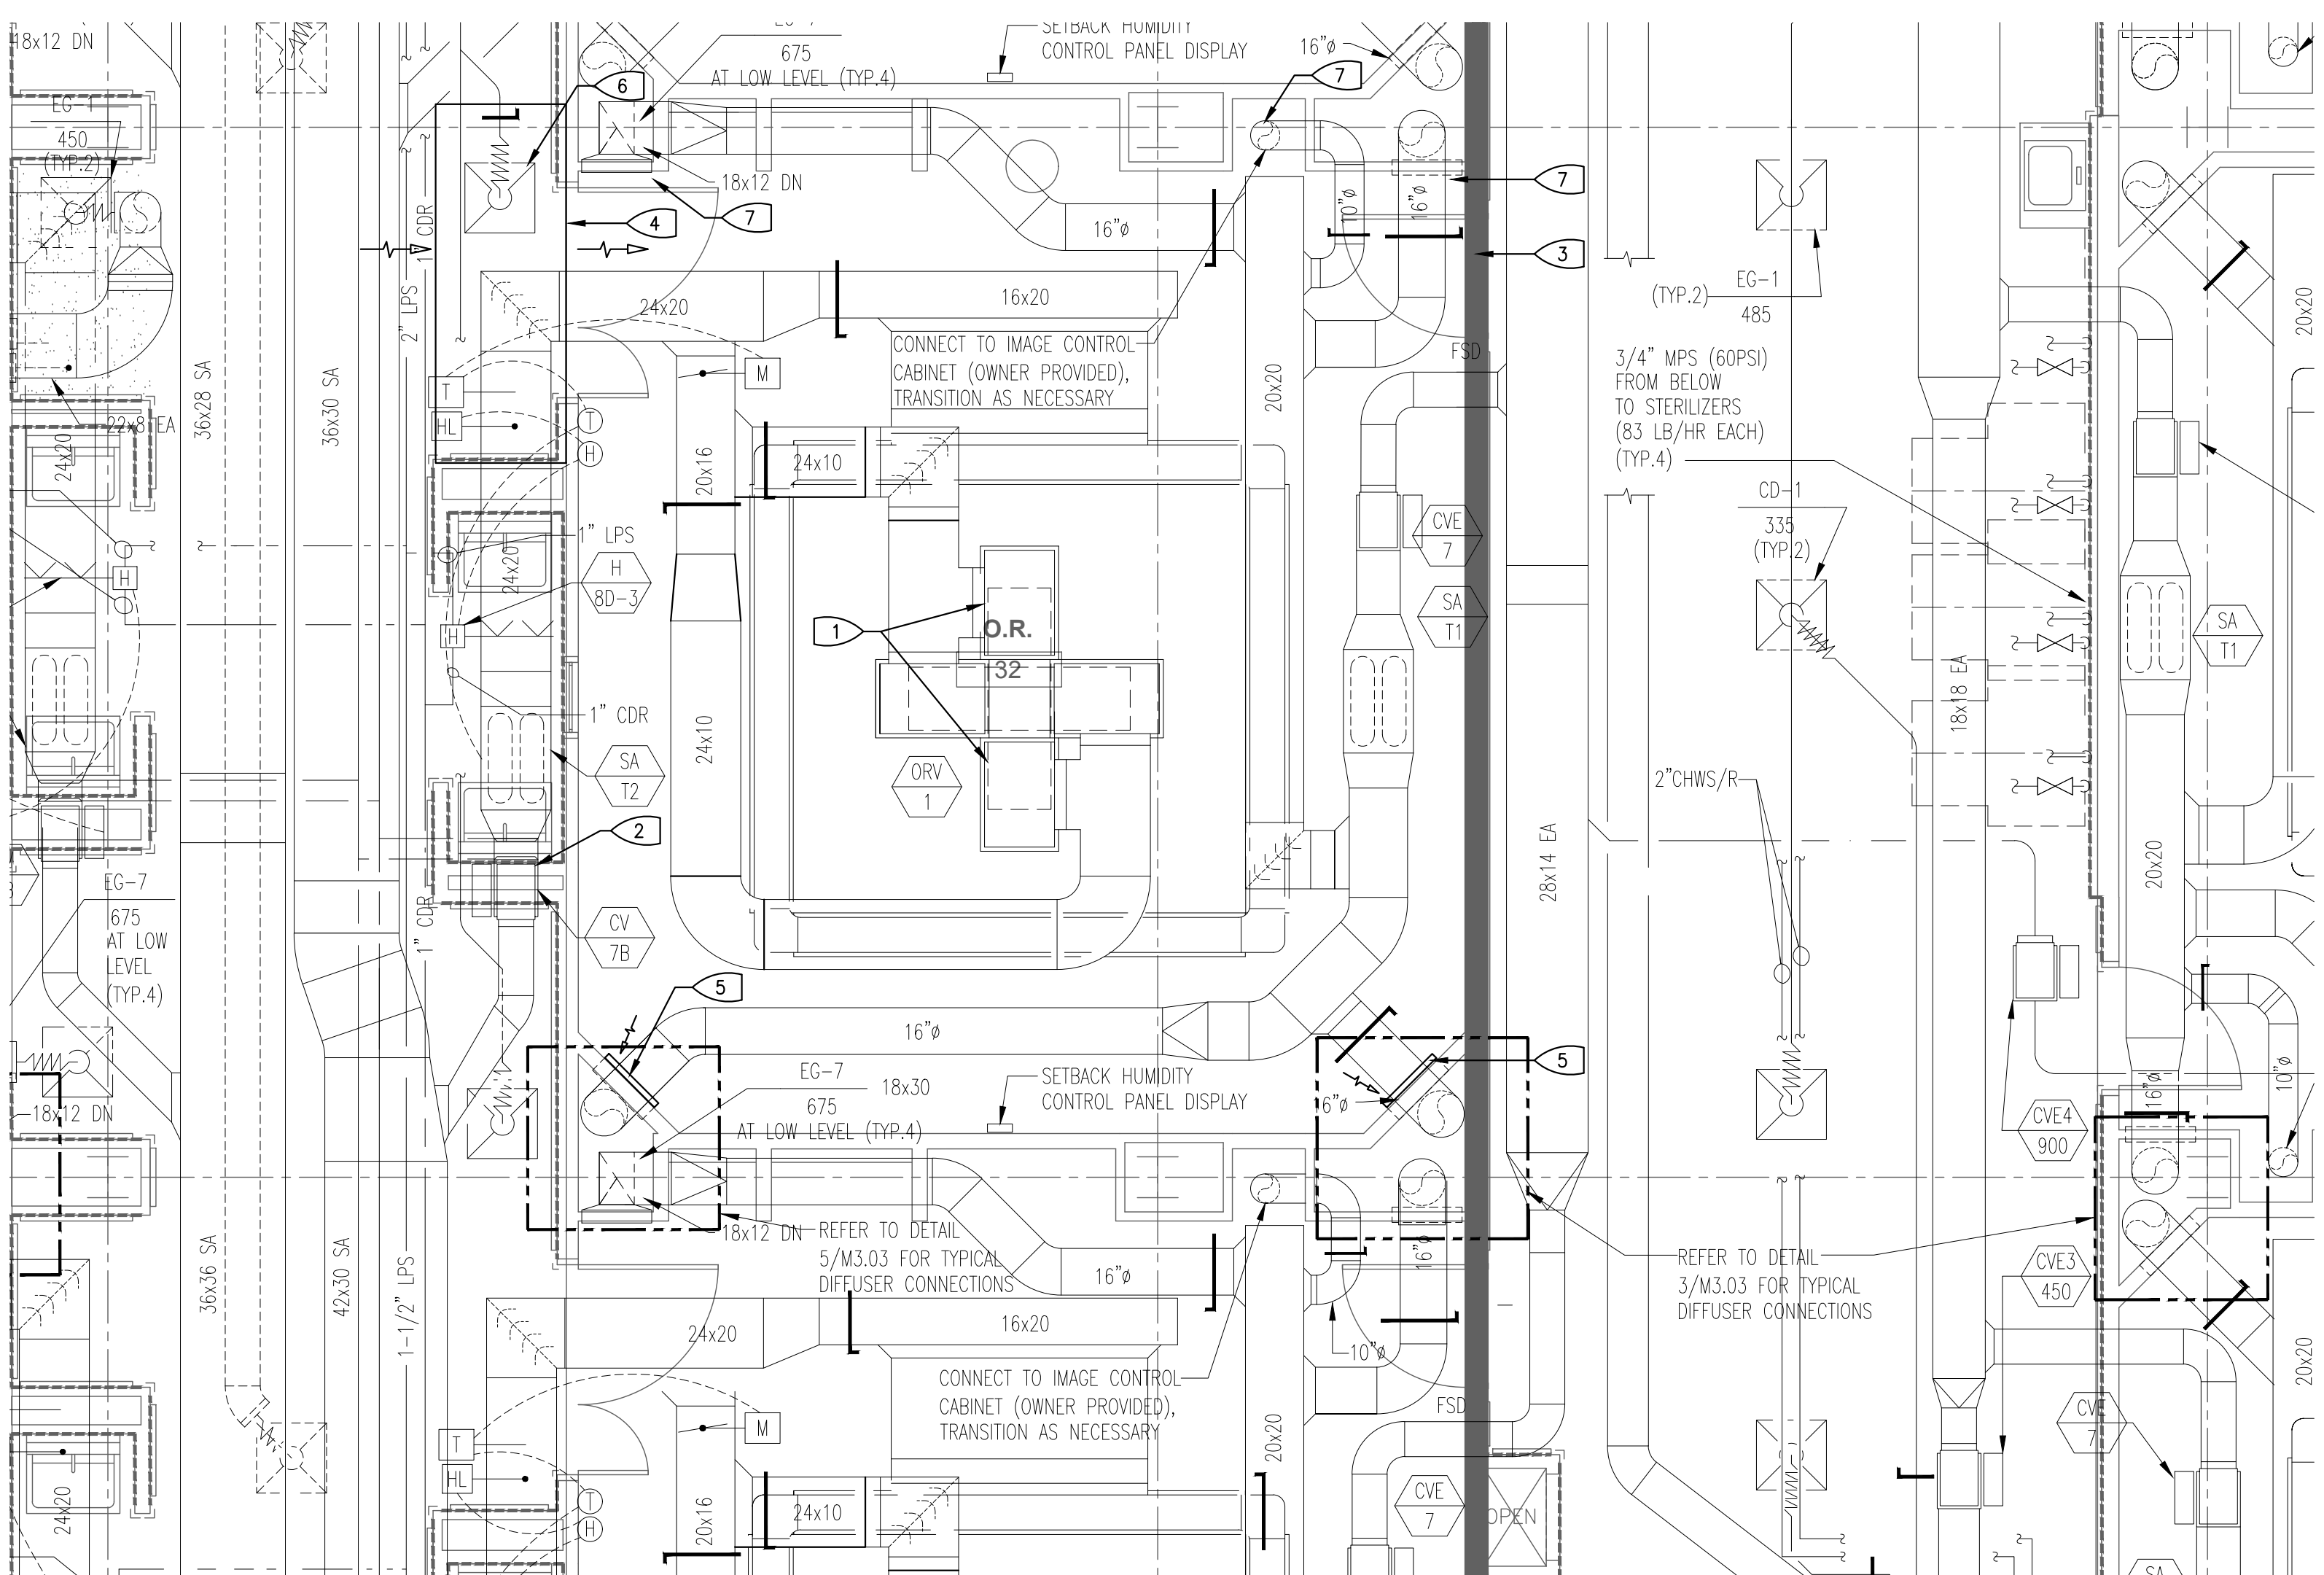
**KEYED NOTES - OPTION 2:**

- PRIOR TO CONSTRUCTION, SEAL ALL SUPPLY AND EXHAUST AIR OPENINGS INTO THE UNDER CONSTRUCTION OPERATING ROOM, TYPICAL.
- PRIOR TO CONSTRUCTION, DEACTIVATE THE SUPPLY CAV AND EXHAUST CAV SERVING THE OPERATING ROOM.
- PRIOR TO CONSTRUCTION, SEAL THE DOORWAY TO THE STERILE CORRIDOR.
- CONSTRUCT A NEGATIVELY PRESSURIZED ANTE ROOM AT THE SCRUB CORRIDOR ENTRANCE.
- PROVIDE AIRHOOGS (OR OTHER SIMILAR PIECE OF EQUIPMENT), LOCATED IN THE ANTE ROOM, TO DRAW AIR IN FROM THE EXISTING SCRUB CORRIDOR, THROUGH THE ANTE ROOM AND BACK OUT INTO THE SCRUB CORRIDOR, THROUGH HEPA FILTERS. THE ANTE ROOM SHALL BE KEPT AT -0.020" W.C. VIA THE AIRHOOGS AT ALL TIMES DURING CONSTRUCTION.
- TEMPORARILY REBALANCE THE NEGATIVELY PRESSURIZED SCRUB CORRIDOR TO ACCOUNT FOR THE LOSS OF POSITIVE AIRFLOW PROVIDED BY THE UNDER CONSTRUCTION OPERATING ROOM. RELOCATE EXISTING AIR TERMINALS IMPACTED BY THE PROVISION OF THE ANTE ROOM (OR OFFSET ANTE ROOM CONSTRUCTION AROUND TERMINALS TO KEEP THEM IN THE SCRUB CORRIDOR THROUGHOUT CONSTRUCTION).

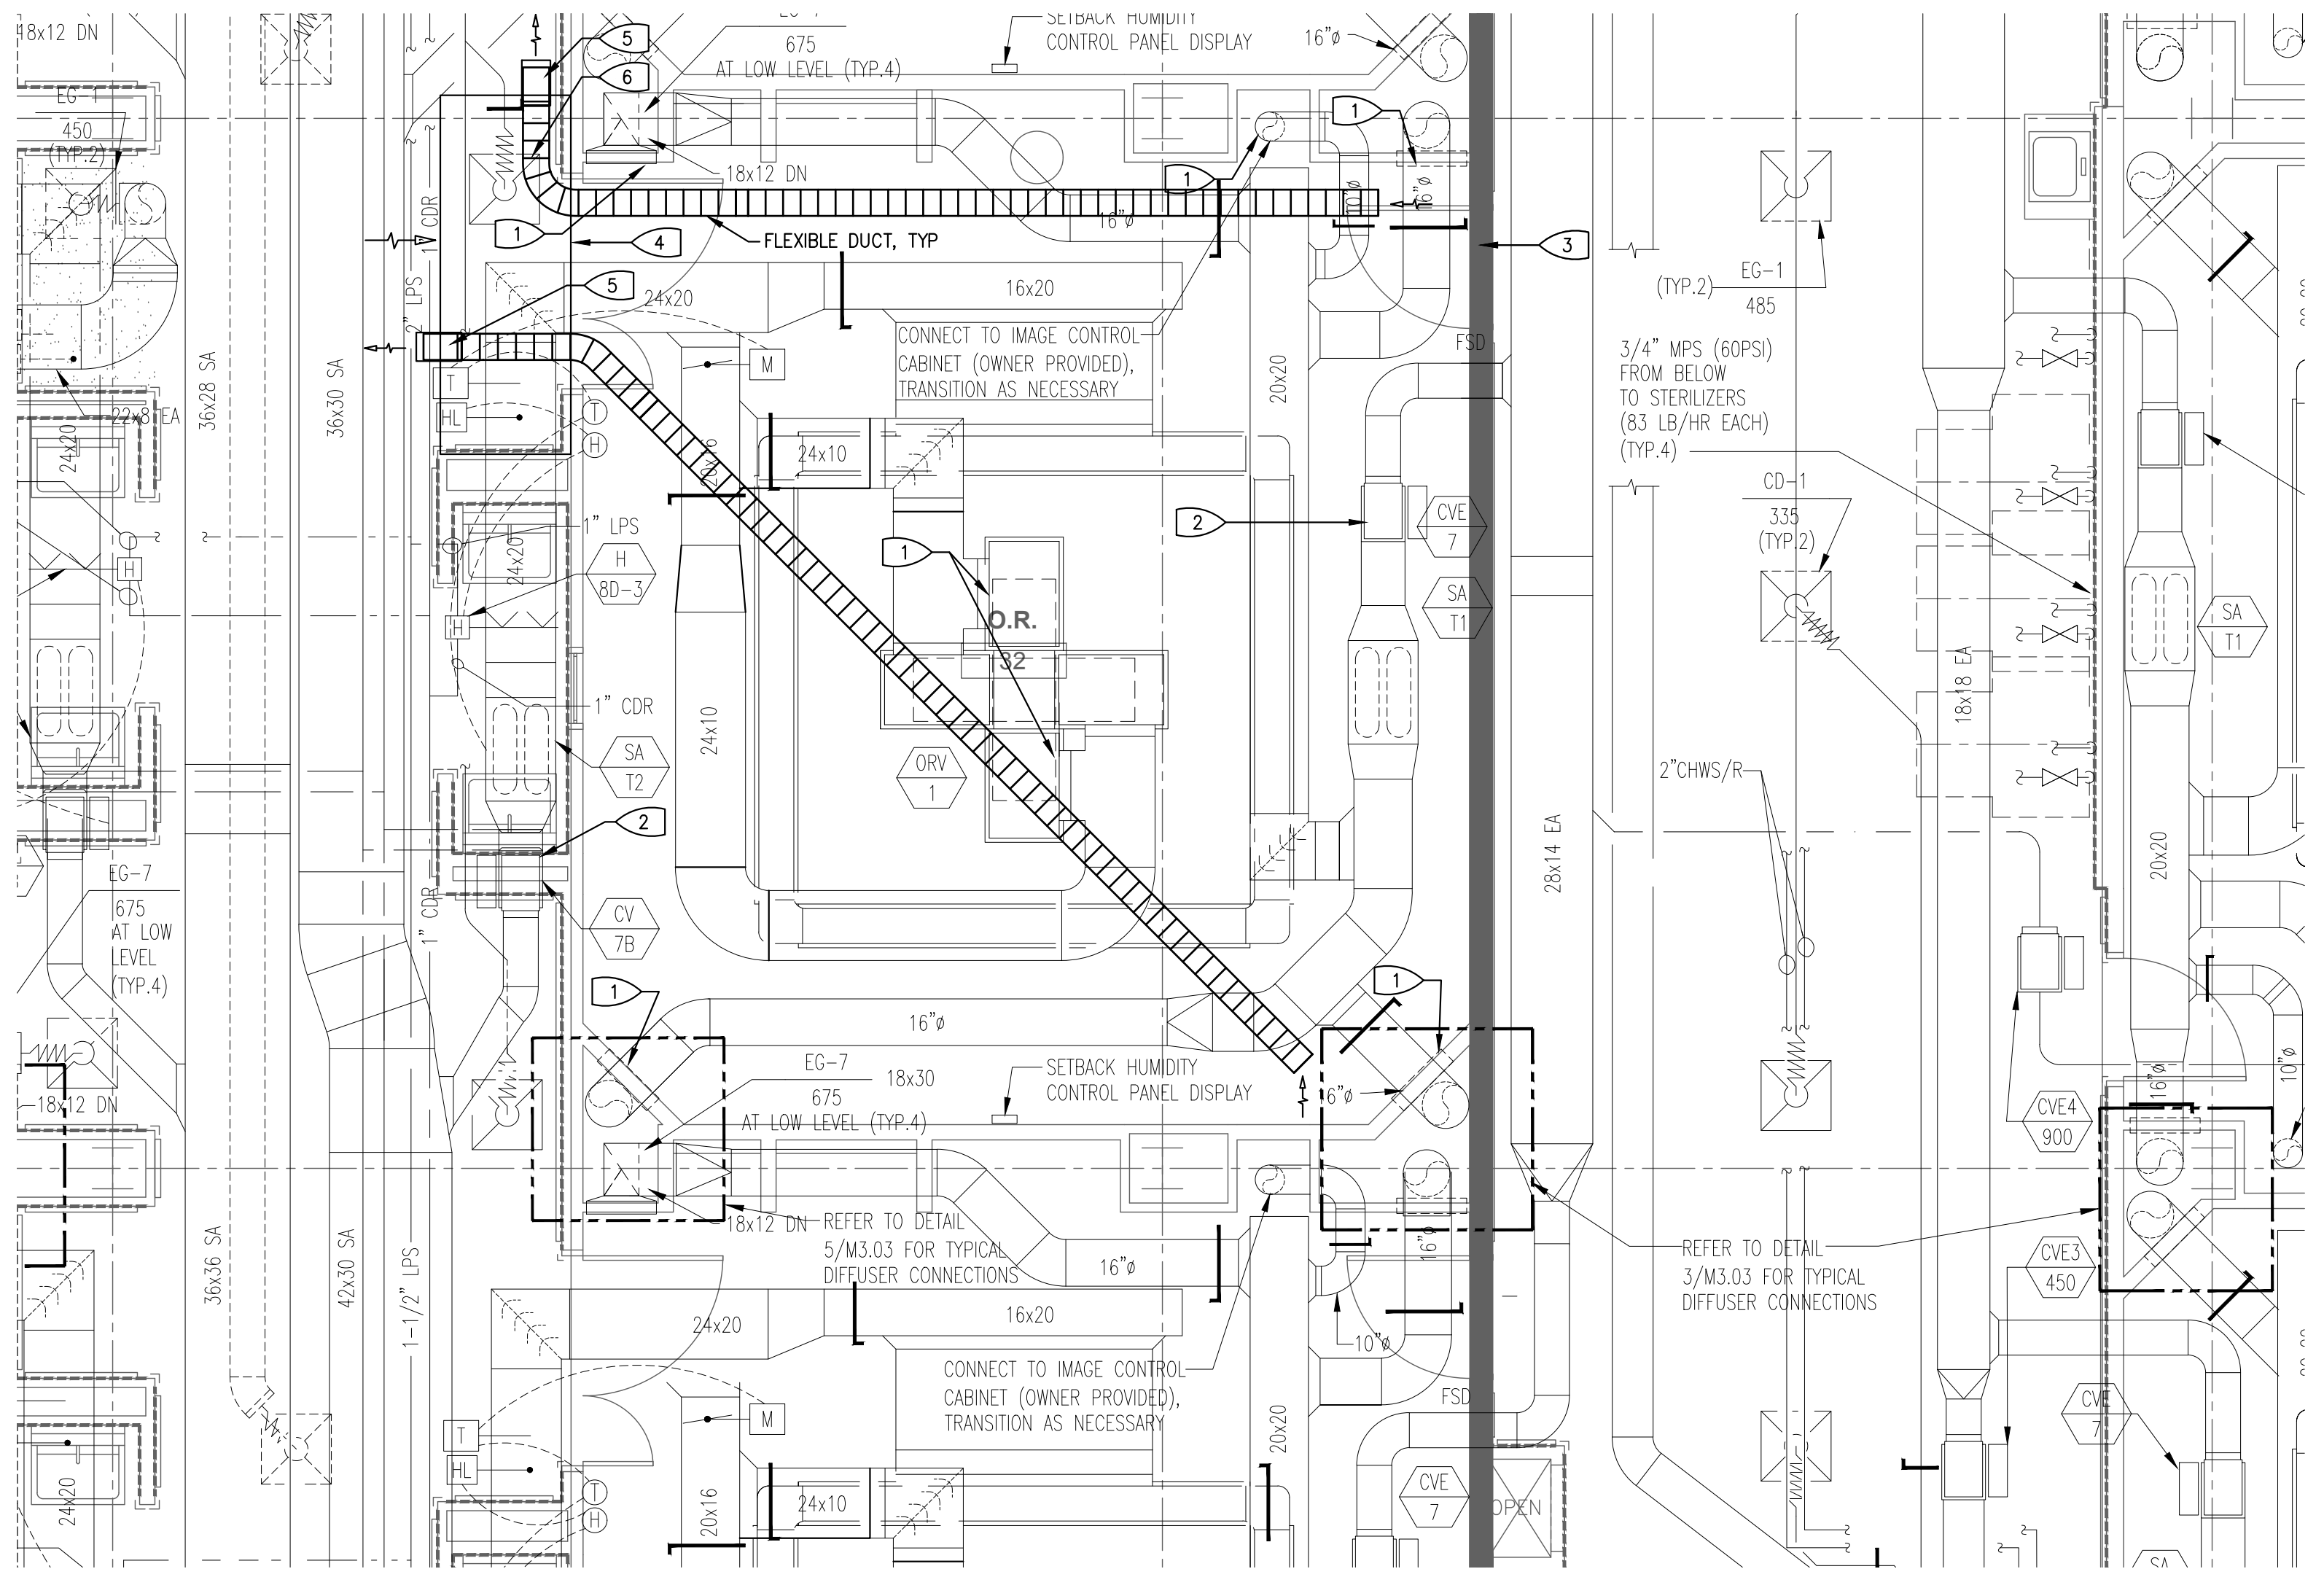


TYPICAL AT TWO LOCATION IN OPERATING ROOM UNDER CONSTRUCTION.

**3 OPTION 1 - HEPA FILTER BOX HOUSING**  
SCALE: NONE



**1 ENLARGED FLOOR PLAN - MECHANICAL - OPTION 1**  
SCALE: 1/4" = 1'-0"



**2 ENLARGED FLOOR PLAN - MECHANICAL - OPTION 2**  
SCALE: 1/4" = 1'-0"

FD&C #: M056973

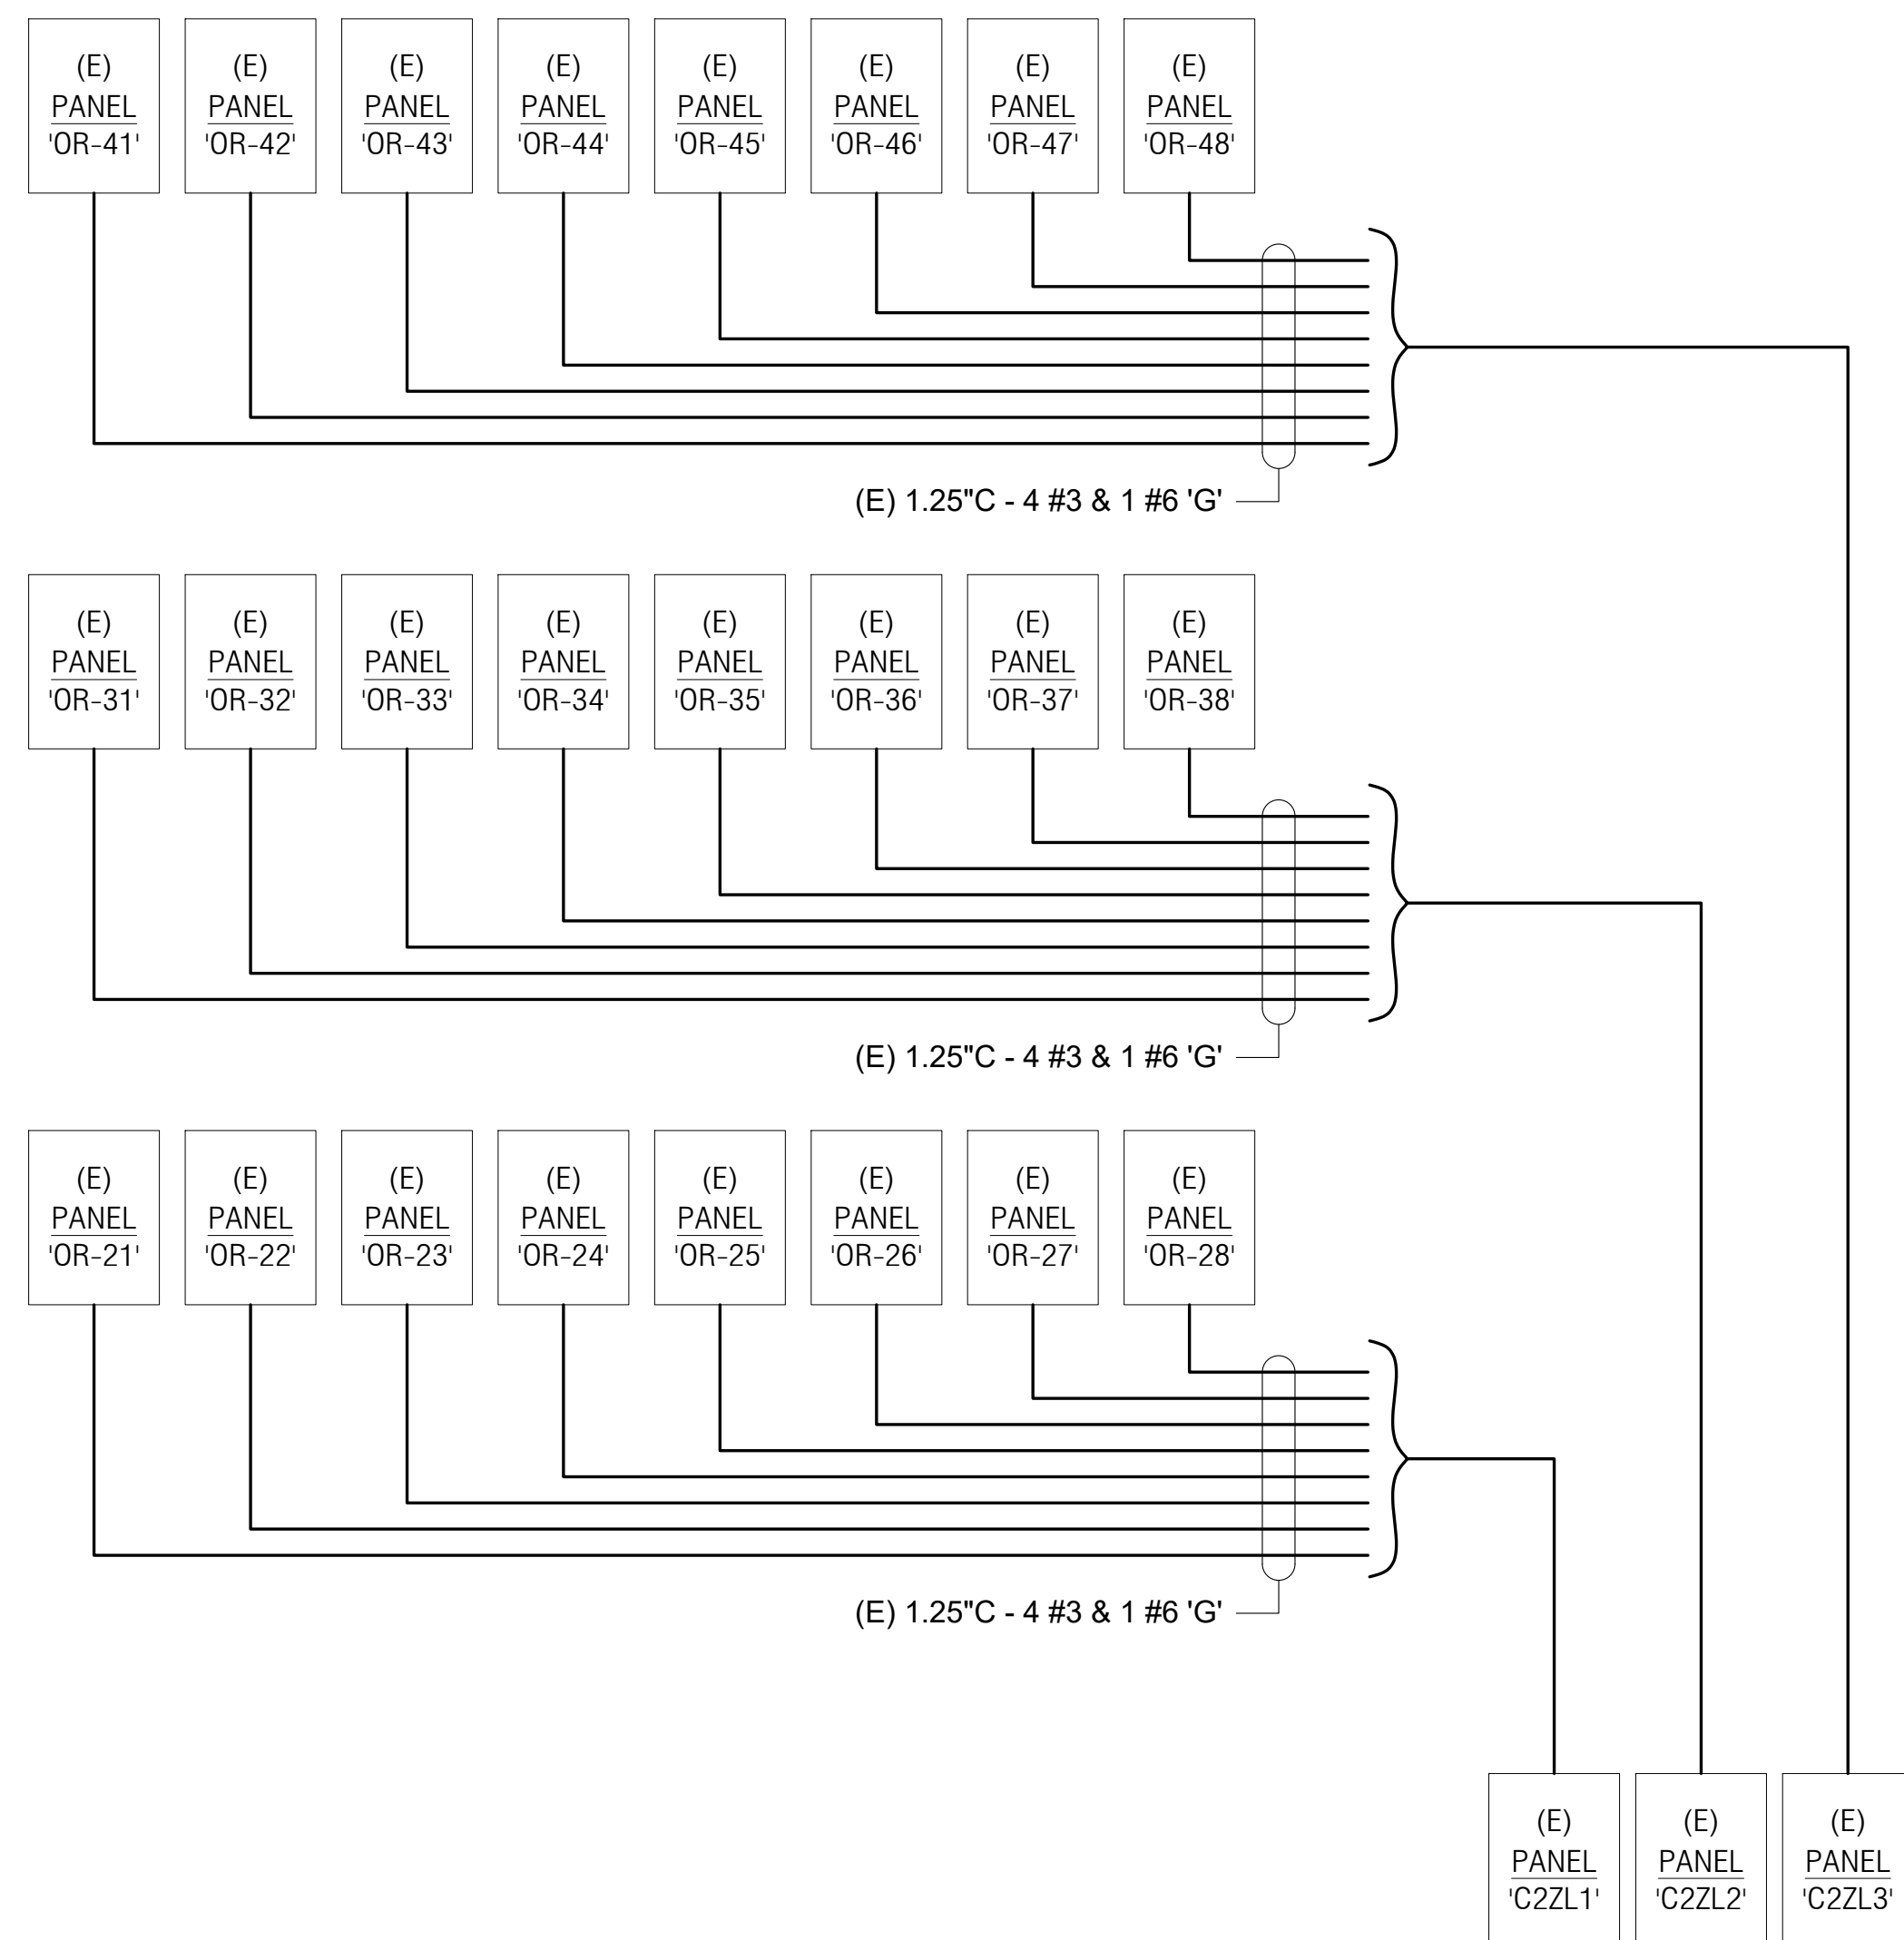
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**SESP OR PO&M FLOORING REPLACEMENT**  
**ENLARGED FLOOR PLAN - MECHANICAL**

ACCOUNTING:	HY JOB NO:	SHEET NO:
ARCH/ENGR:	5839	
ST		
UCDMC PROJECT MGR:	SCALE:	<b>M2.02</b>
ATOSA A.		
DESIGNED BY:	ISSUE DATE:	
RM	7/25/2022	
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RM	2019	OF 16 SHEETS



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CRITICAL BRANCH

28 PARTIAL ONE-LINE DIAGRAM  
NO SCALE

RACEWAY SYMBOLS	
SYMBOL	DESCRIPTION
	RACEWAY INSTALLED IN CEILING OR WALL. ROUTE EXPOSED IN ALL UNFINISHED AREAS.
	EXISTING CONDUIT RUN, VERIFY ROUTING ON THE JOB.
	ARROW AT END OF RACEWAY INDICATES HOME RUN TO RESPECTIVE PANELBOARD OR SWITCHBOARD.
	20 AMP 125V 3W DUPLEX CONVENIENCE RECEPTACLE.
	CONTROL AND/OR EQUIPMENT, PROVIDED UNDER ANOTHER DIVISION, PROVIDE POWER CONNECTION AS INDICATED.
	JUNCTION BOX, SIZE AND TYPE AS INDICATED OR REQUIRED.
	BRANCH CIRCUIT PANELBOARD, FLUSH MOUNTED.
	20 AMP 125V 3W DUPLEX CONVENIENCE RECEPTACLE, CONNECTED TO EMERGENCY POWER SOURCE.
	SPECIAL RECEPTACLE. REFER TO FLOOR PLAN FOR NEMA CONFIGURATION, CONNECTED TO EMERGENCY POWER SOURCE.

ABBREVIATIONS			
1PH, 3PH 1P, 2P, 3P 3W, 4W (D) (E) (ER) (N) (R)	1 PHASE, 3 PHASE 3 POLE, 2 POLE, 3 POLE 3 WIRE, 4 WIRE DEMO, DEMOLISH EXISTING EXISTING RELOCATED NEW RELOCATE	MCA MCB MCC MLO MOCP  MT	<b>-M-</b> MINIMUM CIRCUIT AMPACITY MAIN CIRCUIT BREAKER MOTOR CONTROL CENTER MAIN LUGS ONLY MAXIMUM OVER-CURRENT PROTECTION EMPTY CONDUIT W/ PULL-LINE
A, AMPS AC AF AFF AIC	<b>-A-</b> AMPERES ALTERNATING CURRENT FRAME RATING IN AMPERES ABOVE FINISHED FLOOR AMPERES INTERRUPTING CAPACITY	NC NCTC NEC NEMA  NIES	<b>-N-</b> NORMALLY CLOSED NURSE CALL TERMINAL CABINET NATIONAL ELECTRIC CODE NATIONAL ELECTRICAL MANUFACTURER ASSOCIATION NOT INCLUDED IN ELECTRICAL SCOPE
AL, ALUM ATS AT AWG	ALUMINUM AUTO TRANSFER SWITCH TRIP RATING IN AMPERES AMERICAN WIRE GAUGE	NL NO NTS	<b>-NL-</b> NIGHT LIGHT NORMALLY OPEN NOT TO SCALE
BTR	<b>-B-</b> BUILDING TELECOM ROOM	OCP OFCI  OFOI	<b>-O-</b> OVER-CURRENT PROTECTION OWNER FURNISHED CONTRACTOR INSTALLED OWNER FURNISHED OWNER INSTALLED
C CB, C/B CEC CT CU	<b>-C-</b> CONDUIT CIRCUIT BREAKER CALIFORNIA ELECTRICAL CODE CURRENT TRANSFORMER COPPER	PT PVC	<b>-P-</b> POTENTIAL TRANSFORMER POLYVINYL CHLORIDE CONDUIT
DC	<b>-D-</b> DIRECT CURRENT	RLA RSC	<b>-R-</b> RUNNING LOAD AMP RIGID STEEL CONDUIT
EA ELEC EMT	<b>-E-</b> EACH ELECTRICAL ELECTRICAL METALLIC TUBING	SPD SPDT SPST SST	<b>-S-</b> SURGE PROTECTION DEVICE SINGLE POLE DOUBLE THROW SINGLE POLE SINGLE THROW SOLID STATE TRIP
FA FACP FATC FLA FT	<b>-F-</b> FIRE ALARM FIRE ALARM CONTROL PANEL FIRE ALARM TERMINAL CABINET FULL LOAD AMPS FOOT OR FEET	TER TR TM TTB	<b>-T-</b> TELECOM EQUIPMENT ROOM TELECOM ROOM THERMAL MAGNETIC TERMINAL BACKBOARD
G, GND GA GFCI	<b>-G-</b> GROUND GAUGE GROUND FAULT CIRCUIT INTERRUPTER	UG UL UON UPS	<b>-U-</b> UNDERGROUND UNDERWRITERS LAB. UNLESS OTHERWISE NOTED UNINTERRUPTIBLE POWER SUPPLY
HOA HP	<b>-H-</b> HAND-OFF-AUTO HORSE POWER	V VA VAC	<b>-V-</b> VOLTS VOLT-AMPS VOLTS ALTERNATE CURRENT
J-BOX	<b>-J-</b> JUNCTION BOX	W WCR WP	<b>-W-</b> WATTS WITHSTAND & CLOSING RATING WEATHERPROOF
KVA KW	<b>-K-</b> ONE THOUSAND VOLT-AMPS ONE THOUSAND WATTS	XFMR XFER	<b>-X-</b> TRANSFORMER TRANSFER SWITCH
LCP LTG	<b>-L-</b> LIGHTING CONTROL PANEL LIGHTING		

SHEET INDEX	
SHEET	DESCRIPTION
E0.01	ABBREVIATIONS, SYMBOLS, ONE-LINE DIAGRAM, & SHEET INDEX
E1.00	OVERALL 3RD FLR PLAN - ELEC
E3.01	ENLARGED 3RD FLR PLAN - ELEC
E5.01	PANEL SCHEDULES (OPTION 1)
E5.02	PANEL SCHEDULES (OPTION 2)

**GENERAL ELECTRICAL NOTES**

- WHERE PROVIDED, THROUGH-PENETRATION FIRESTOP SYSTEM AND MEMBRANE PENETRATION DETAILS SHOWN IN THE DETAILS ARE FOR REFERENCE ONLY. THROUGH-PENETRATIONS AND MEMBRANE PENETRATIONS SHALL BE PROTECTED BY AN APPROVED PENETRATION FIRESTOP SYSTEM OR MEMBRANE PENETRATION FIRESTOP SYSTEM INSTALLED AS TESTED IN ACCORDANCE WITH ASTM E 814 OR UL 1479, WITH A MINIMUM POSITIVE PRESSURE DIFFERENTIAL OF 0.01 INCH (2.49 PA) OF WATER OR AS OTHERWISE PERMITTED BY CBC, SECTION 714. LISTED THROUGH-PENETRATION FIRESTOP SYSTEMS AND MEMBRANE PENETRATIONS SHALL BE INSTALLED IN ACCORDANCE WITH THE INSTALLATION DETAILS FOR LISTED SYSTEMS. LISTED THROUGH-PENETRATION FIRESTOP SYSTEMS, MEMBRANE PENETRATION PROTECTION AND OTHER PERMITTED MEANS AND METHODS OF PENETRATION PROTECTION SHALL BE SUBMITTED FOR HCAI FLSO/LOCAL FIRE MARSHAL REVIEW AND APPROVAL PRIOR TO INSTALLATION.
- ALL ELECTRICAL EQUIPMENT TO BE INSTALLED OR PERMANENTLY CONNECTED (HARDWIRED) SHALL BE LISTED, LABELED, OR CERTIFIED BY A NATIONALLY RECOGNIZED TESTING LABORATORY (NRTL) PER CEC 110.2.
- ALL EQUIPMENT SHALL BE USED IN ACCORDANCE WITH LISTING PER CEC 110.3B.



HY ARCHITECTS PROJECT #: 5839  
**HIBSER YAMAUCHI**  
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 4602 2nd Street, Suite 3  
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 1151 Harbor Bay Pkwy, Suite 1235, Alameda, CA 94502, 510.634.7200  
 Project Number: 1458, Contact: GORDON

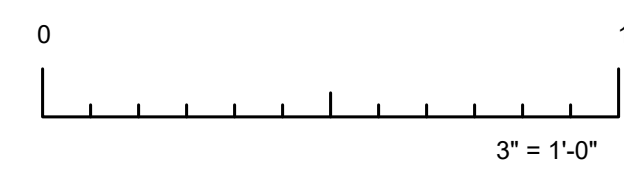
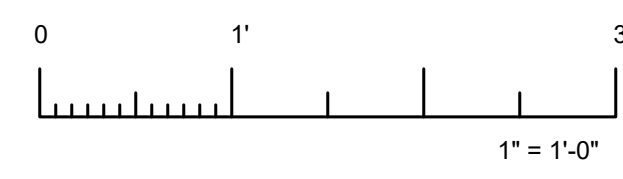
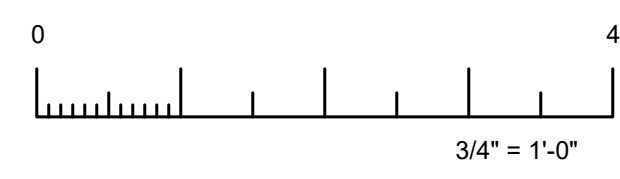
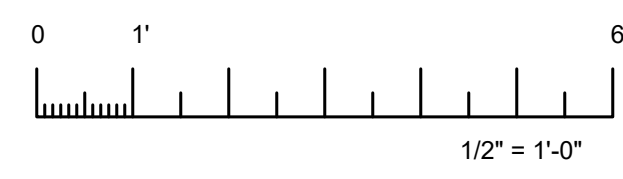
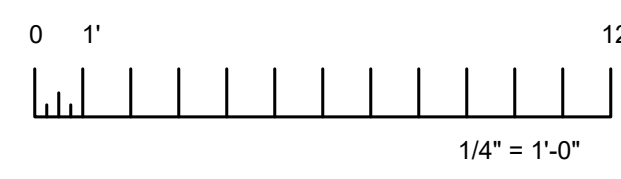
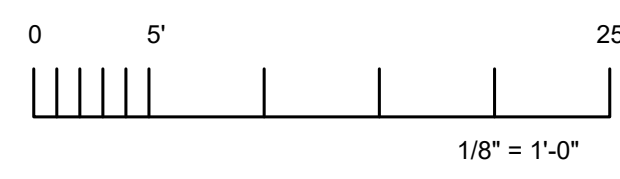
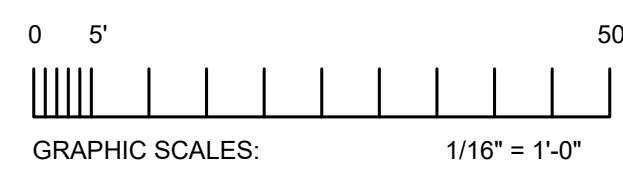
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 SHEET TITLE  
 ARCHITECT: HY ARCHITECTS  
 PROJECT NO: 5839  
 SHEET NO: E0.01  
 ARCH ENGR: KEN Y.  
 UCDM PROJECT MGR: ATOSA A.  
 DESIGNED BY: GORDON  
 ISSUE DATE: 7/25/2022  
 DRAWN BY: CORY  
 REVIT VERSION: 2019  
 OF SHEETS:



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HY ARCHITECTS PROJECT # 5839

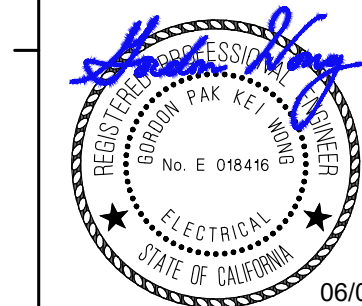
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 Project Number: 1458 Contact: GORDON

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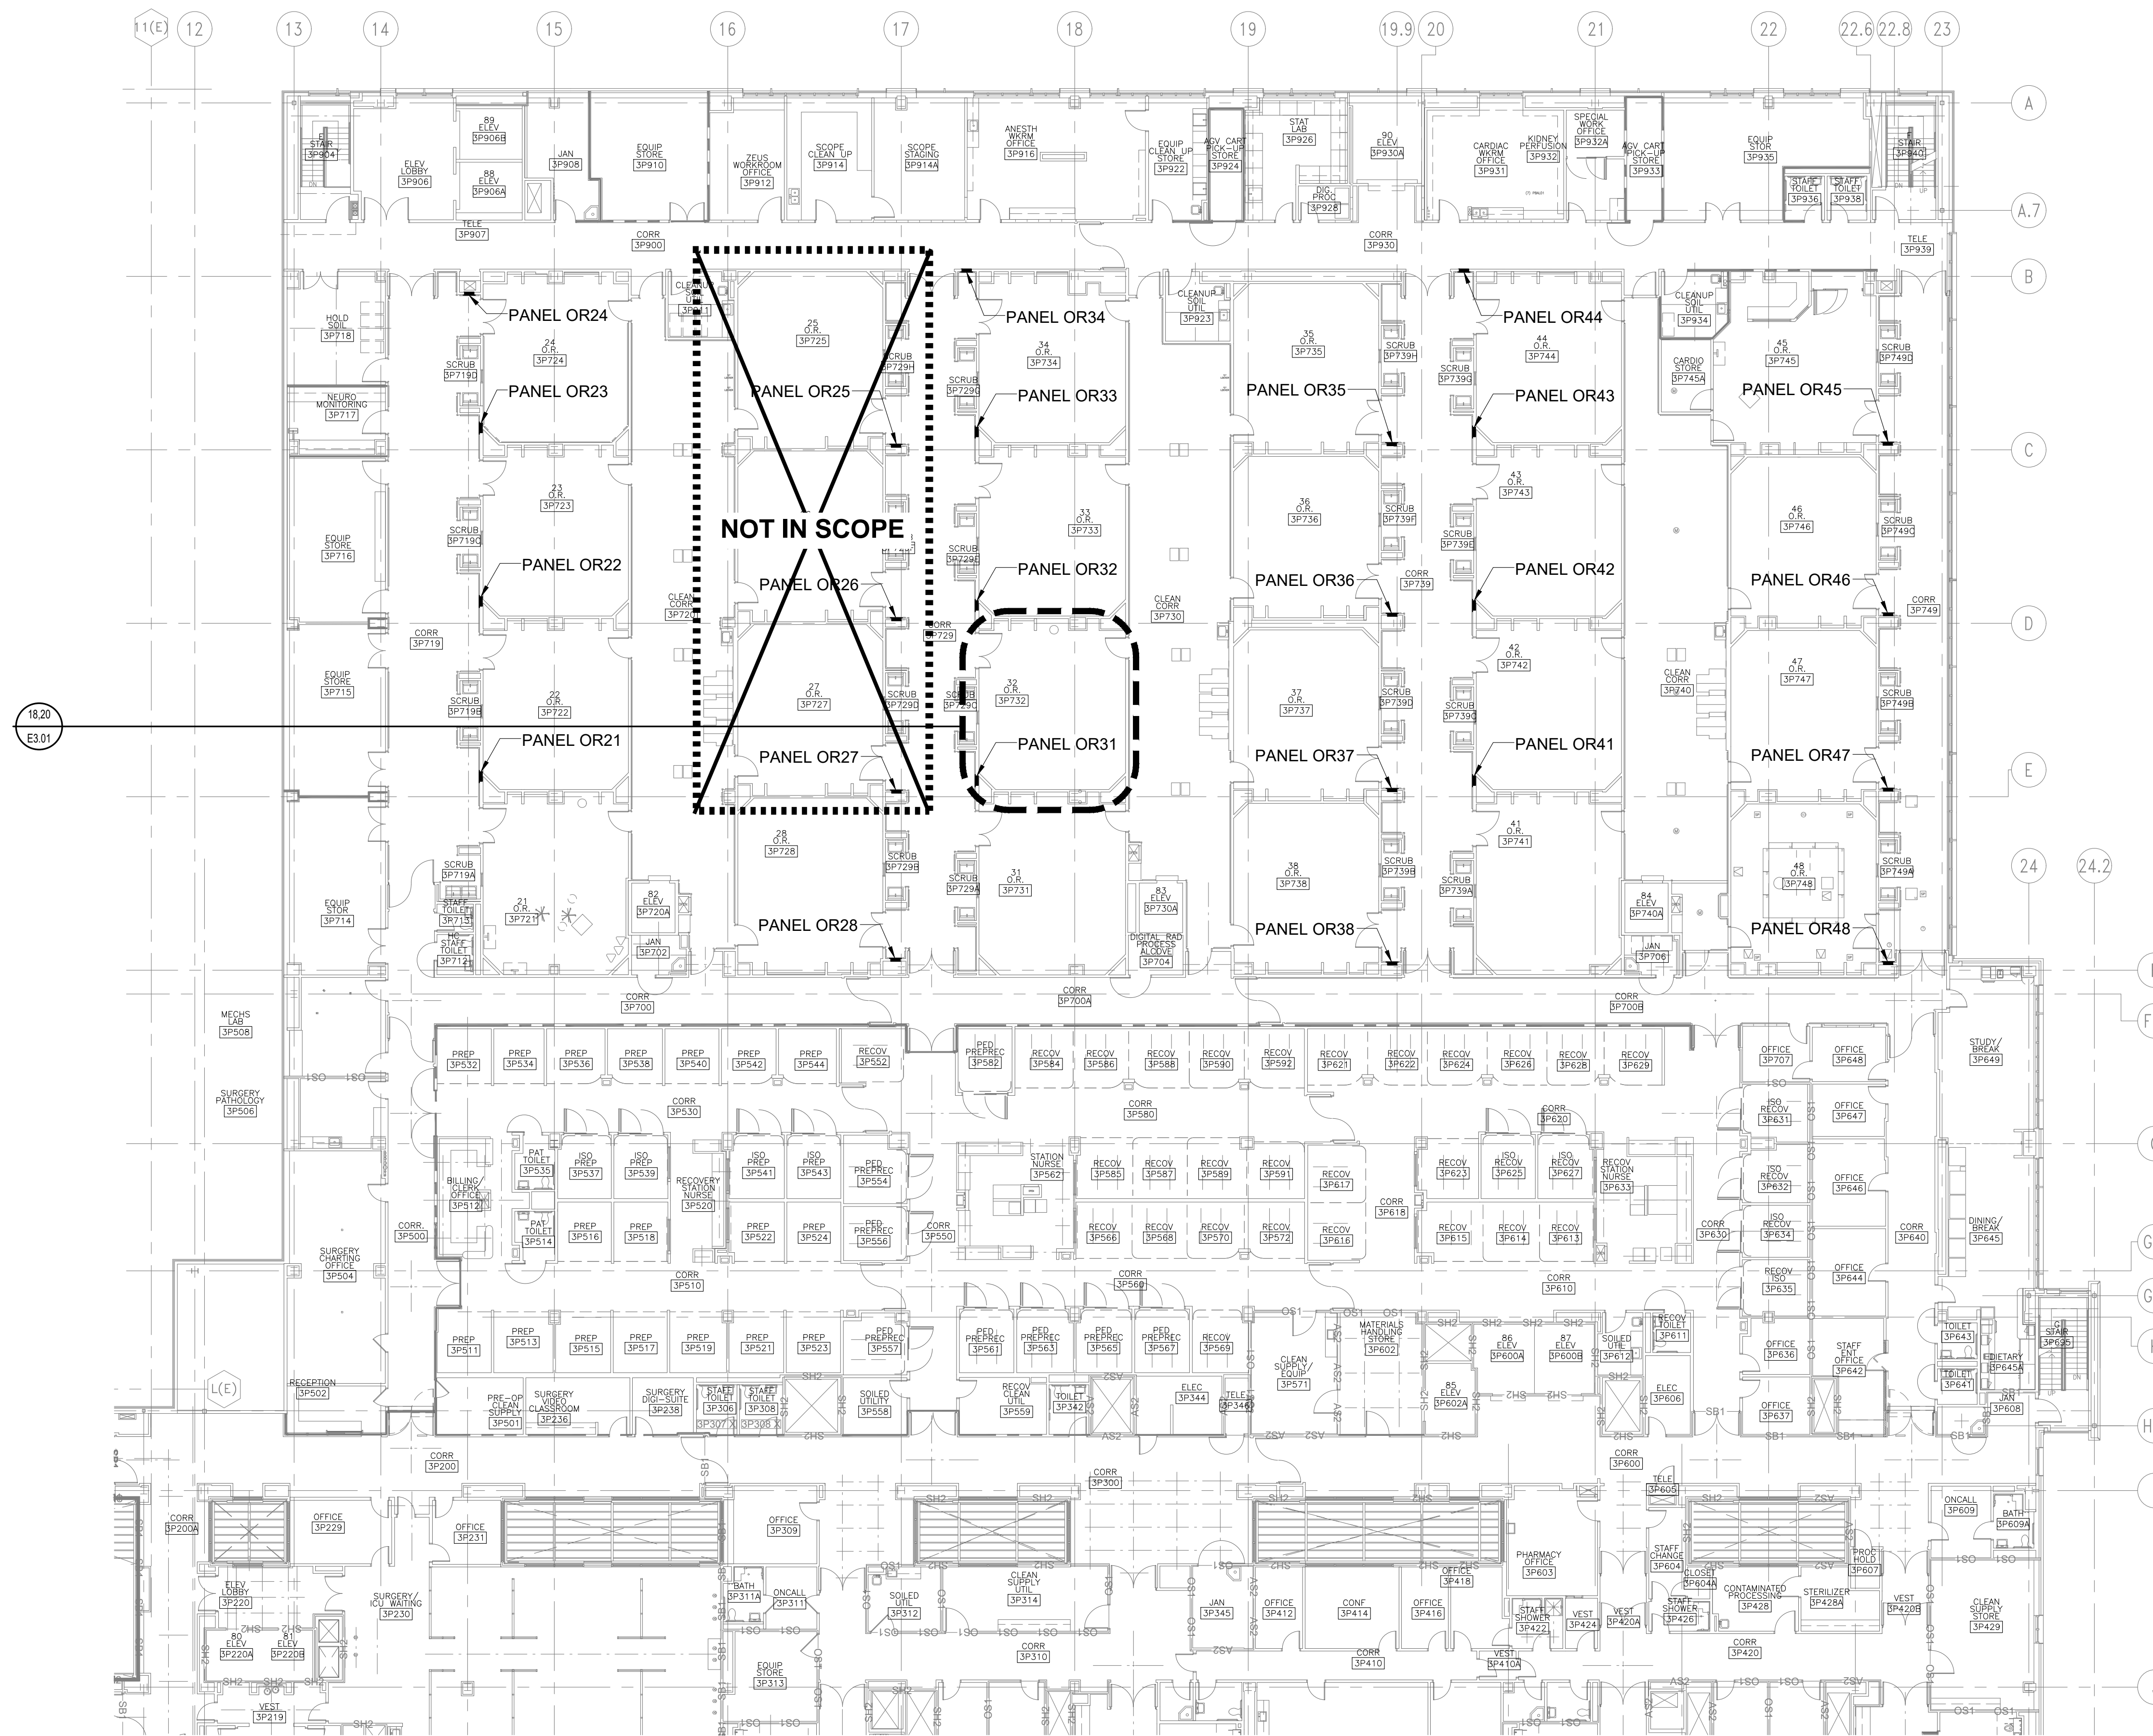


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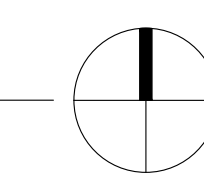
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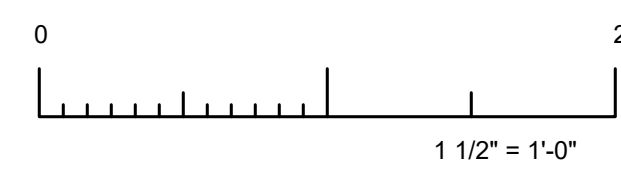
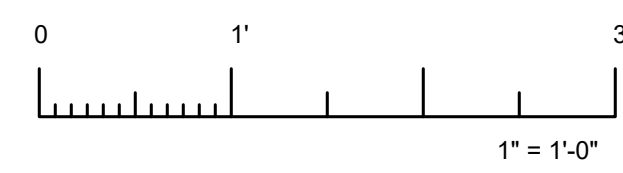
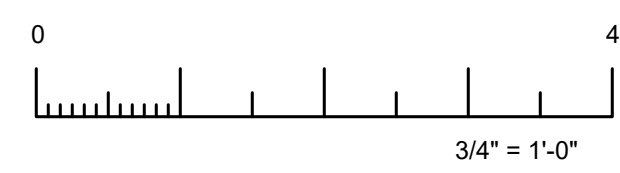
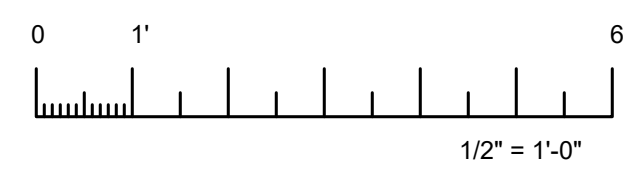
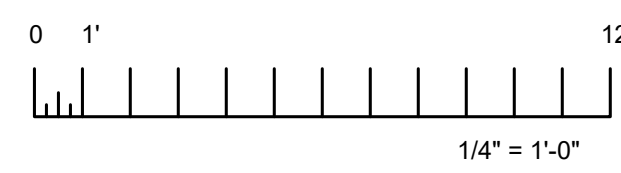
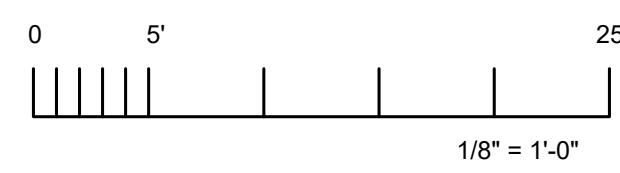
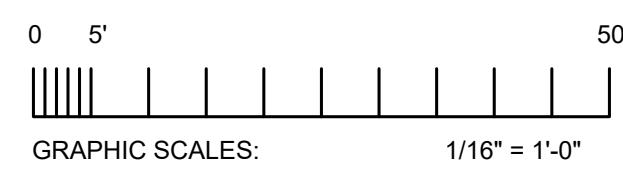
**SESP OR PO&M FLOORING REPLACEMENT OVERALL 3RD FLR PLAN - ELEC**



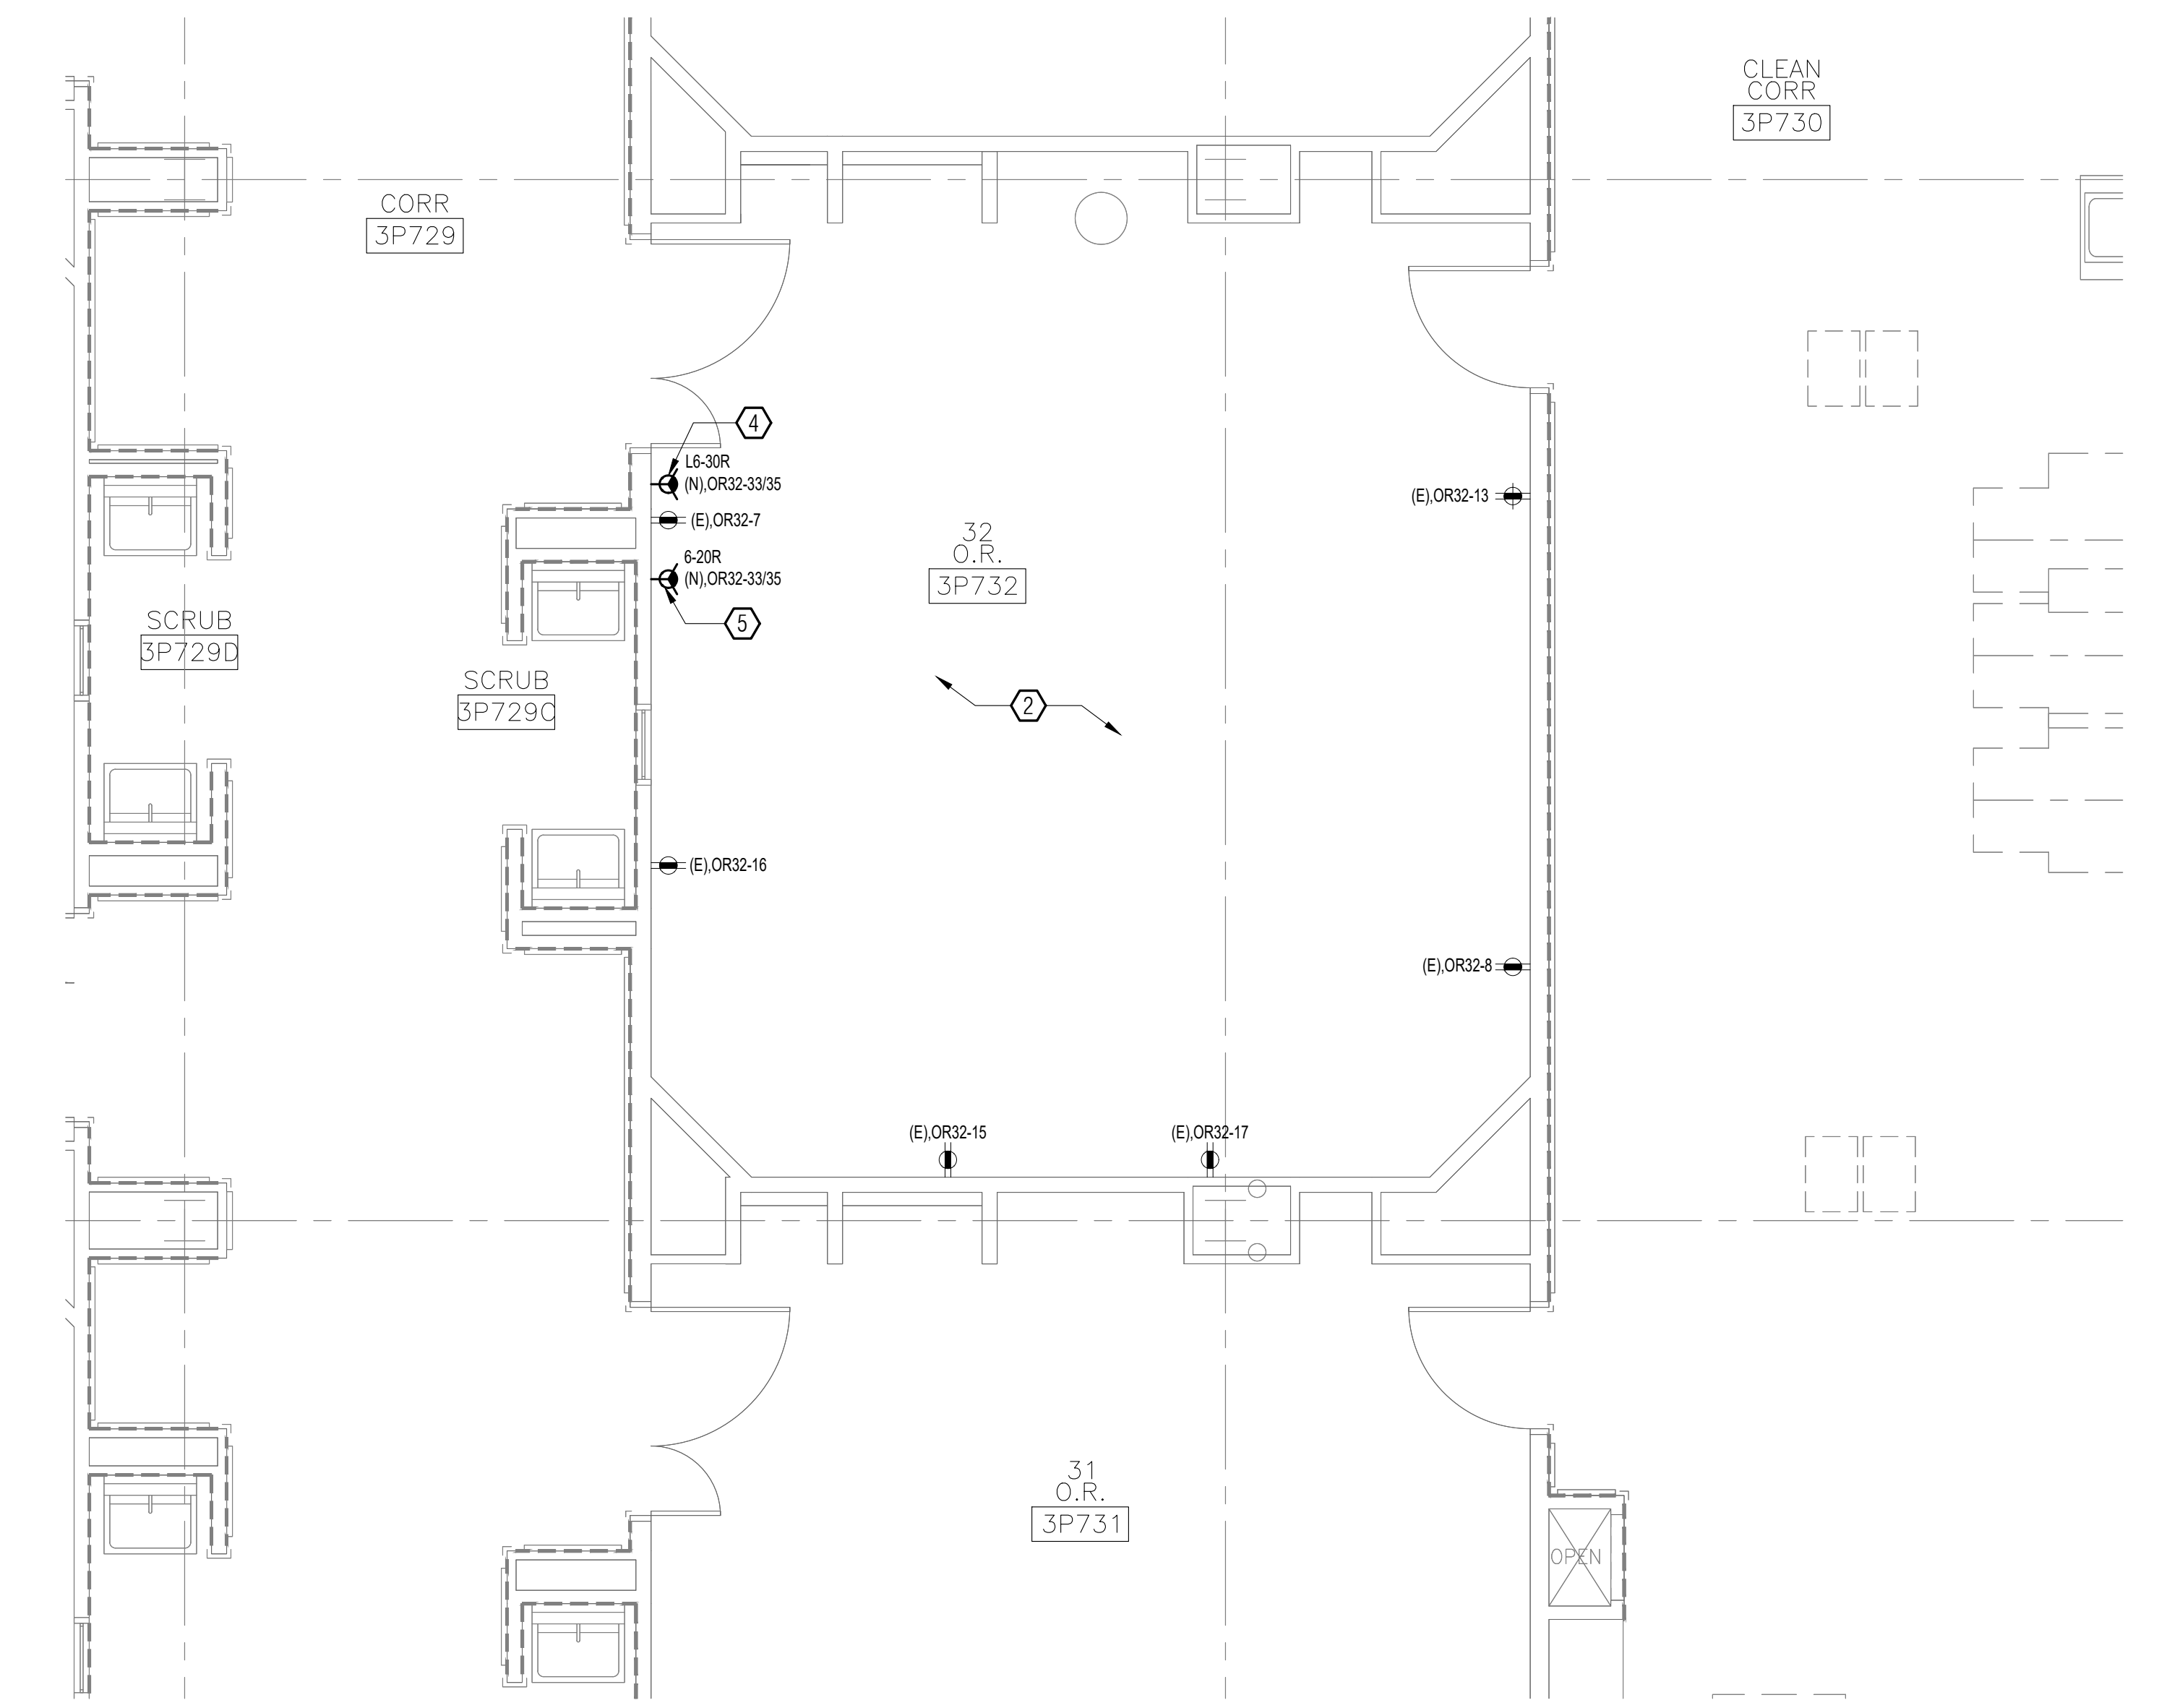
**25 OVERALL THIRD FLOOR PLAN**  
 SCALE: 1/16" = 1'-0"



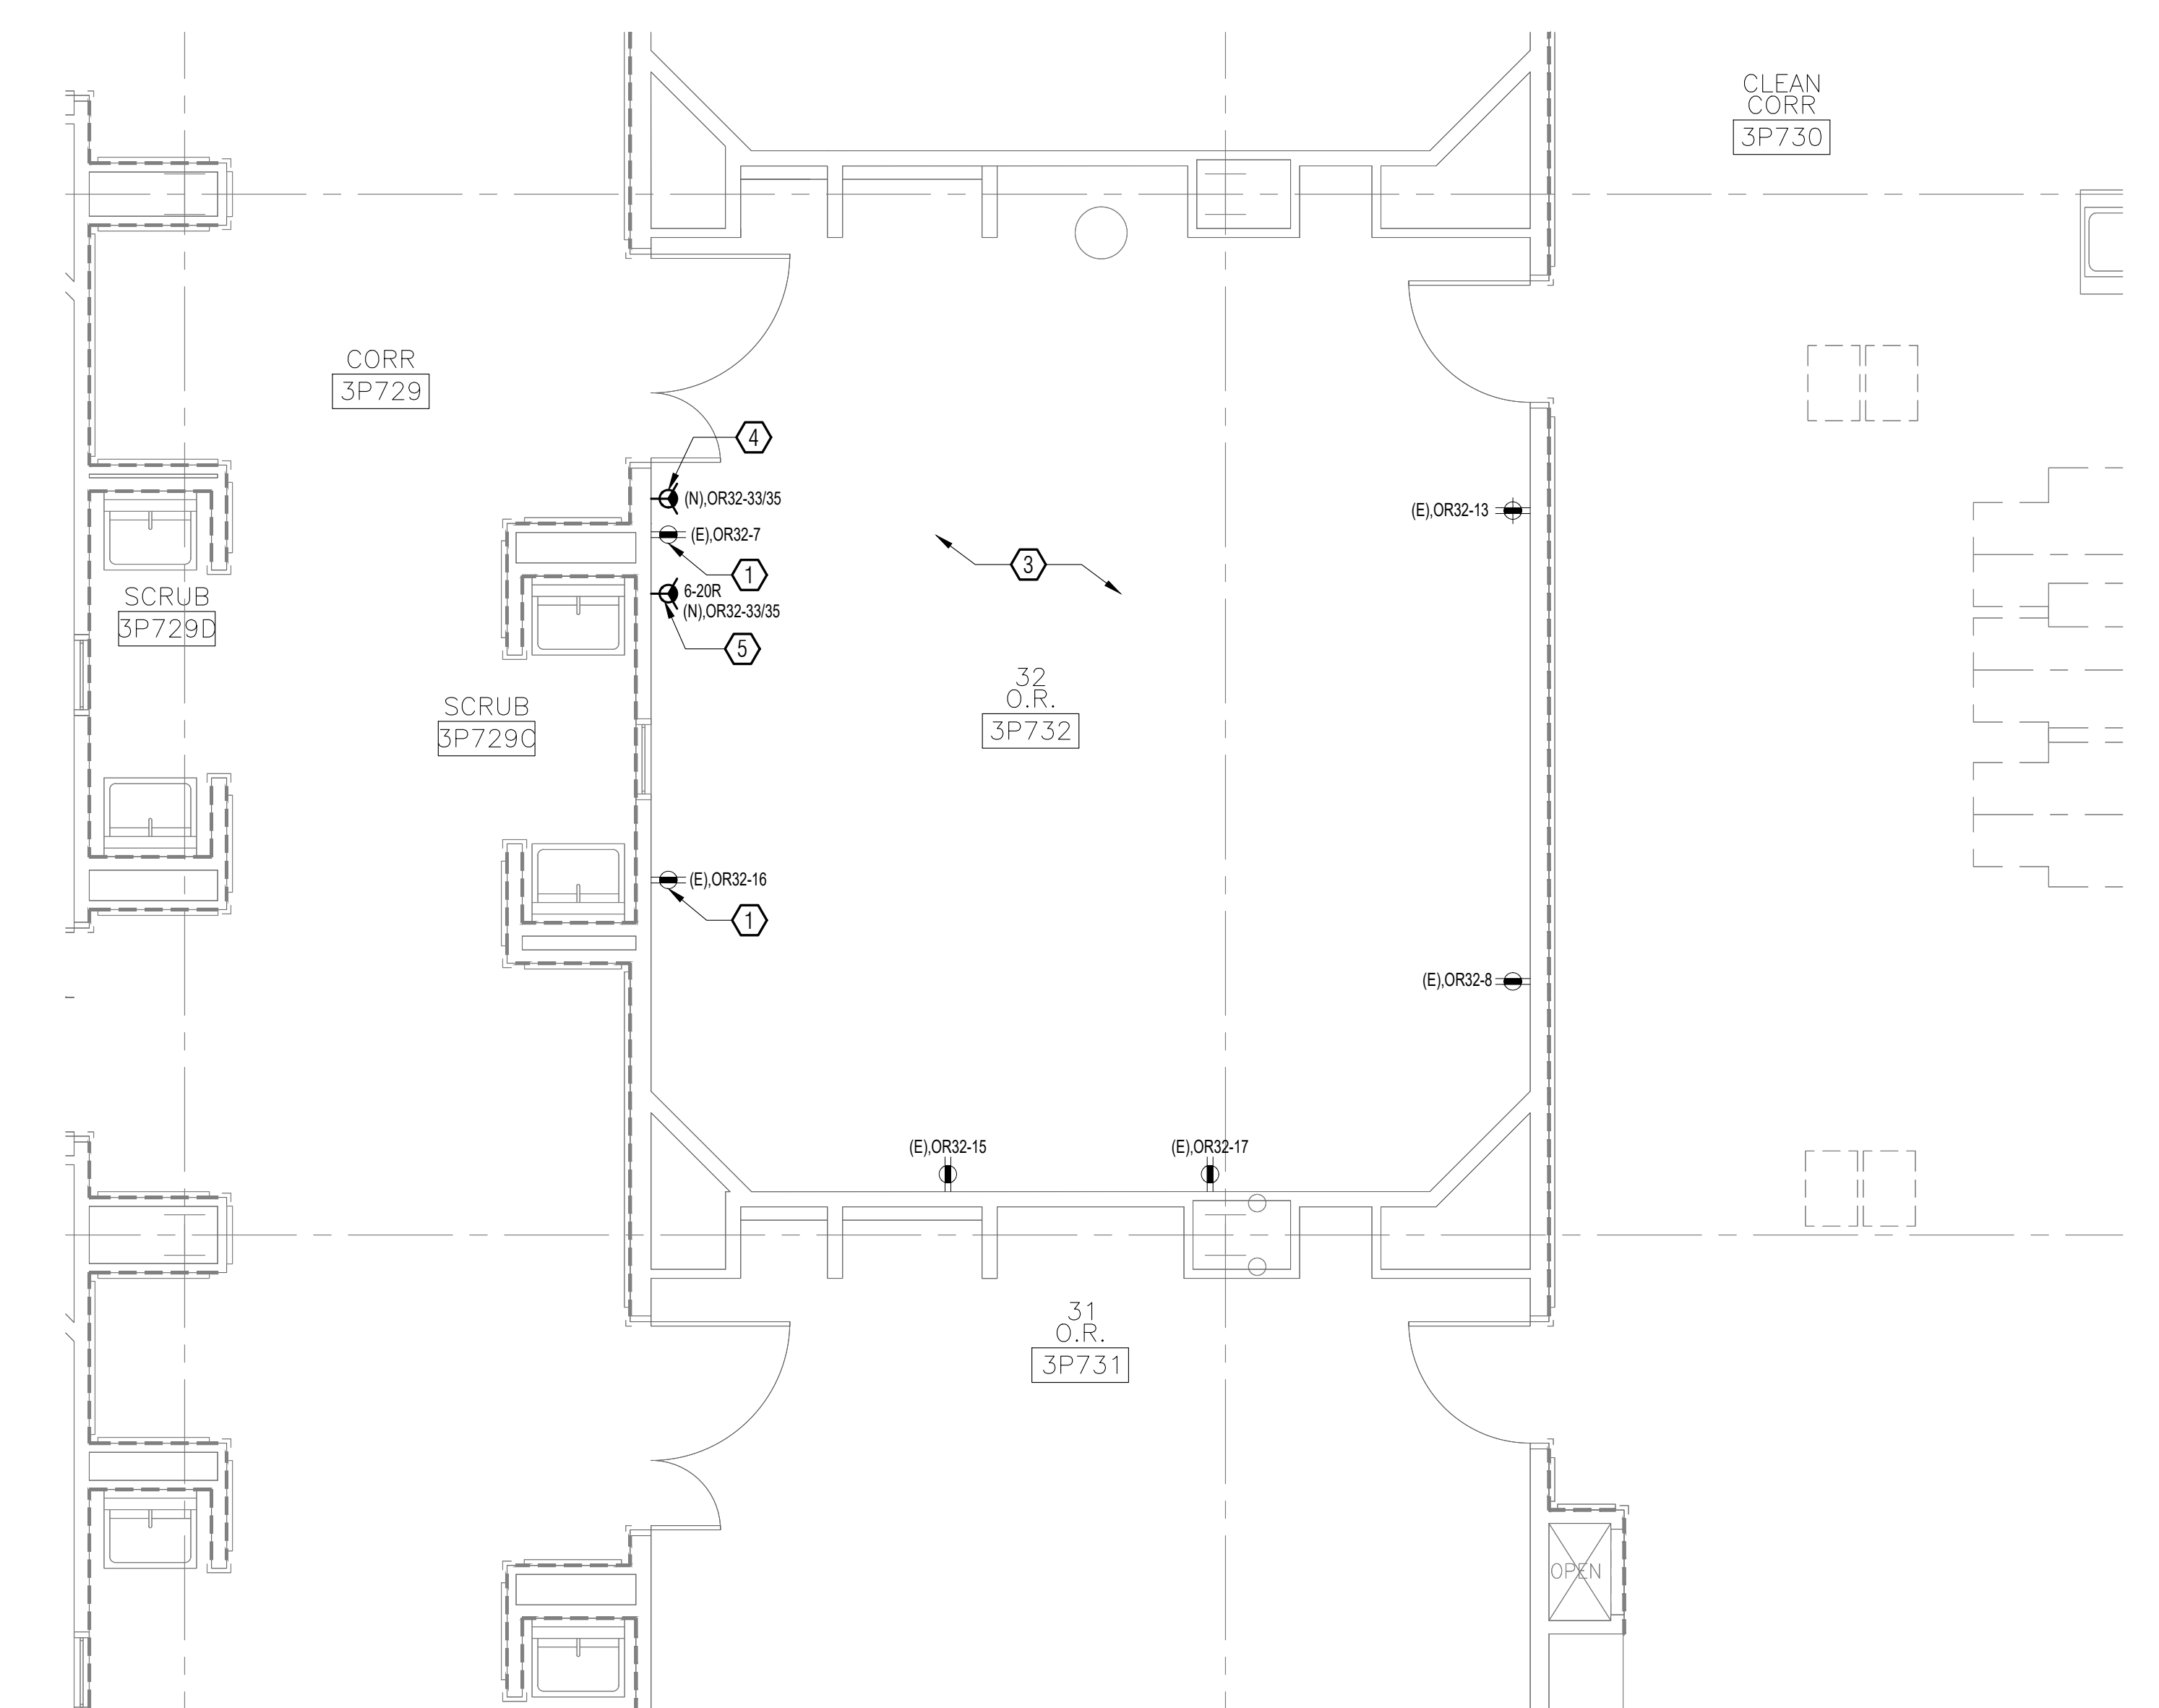
ACCOUNT NO.	HY JOB NO.	SHEET NO.
ARCH ENGR.	5839	<b>E1.00</b>
UCDMG PROJECT MGR.	SCALE	
DESIGNED BY	ISSUE DATE	OF SHEETS
GORDON	7/25/2022	
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**18 ENLARGED THIRD FLOOR PLAN - OPTION 1**  
SCALE: 1/4" = 1'-0"



**20 ENLARGED THIRD FLOOR PLAN - OPTION 2**  
SCALE: 1/4" = 1'-0"

**SHEET NOTES**

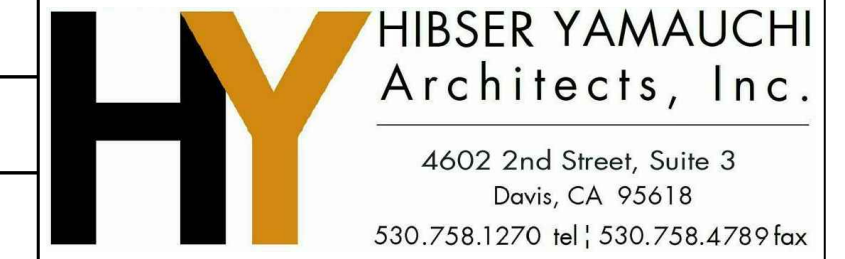
- OPERATING ROOM 32 SHOWN ON THIS SHEET IS A TYPICAL EXAMPLE OF THE TEMPORARY CONSTRUCTION POWER THAT WILL BE UTILIZED FOR THE WORK IN EACH OPERATING ROOM. ALL BREAKERS FOR (E) LOADS IN THE OPERATING ROOM PANEL SHALL BE TURNED OFF WITH THE EXCEPTION OF THE ROOM LIGHTING AND THE BREAKERS USED FOR THE TEMPORARY CONSTRUCTION EQUIPMENT.
- REFER TO OVERALL FLOOR PLAN FOR PANEL LOCATION.

**NUMBERED NOTES**

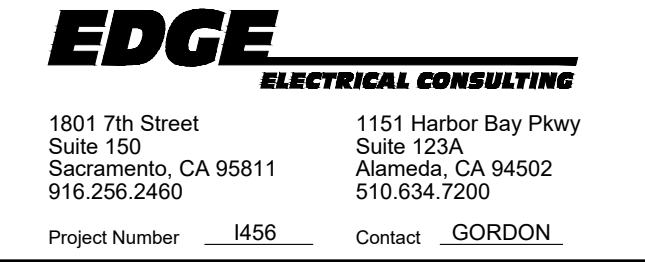
- CONNECT AIR HOG (120V, 9.4A) TO (E) RECEPTACLE.
- FOR OPTION 1, THE TEMPORARY CONSTRUCTION EQUIPMENT UTILIZED SHALL BE AS SHOWN BELOW. THERE ARE FOUR DIFFERENT SCENARIOS THAT COULD BE UTILIZED IN THE OPERATING ROOM. REFER TO THE PANEL SCHEDULES ON SHEET E5.01 FOR THE LOAD DRAW FOR EACH SCENARIO.
  - SCENARIO A:
    - A. ONE GRINDER (208V, 1 PHASE, 4KVA)
    - B. ONE GRINDER (115V, 19.8 A)
    - C. TWO DUST COLLECTORS (110V, 12A EACH)
  - SCENARIO B:
    - A. ONE GRINDER (208V, 1 PHASE, 4KVA)
    - B. ONE GRINDER (115V, 15 A)
    - C. TWO DUST COLLECTORS (110V, 12A EACH)
  - SCENARIO C:
    - A. ONE GRINDER (120V, 15A)
    - B. ONE BLASTAC (208V, 1 PHASE, 7.2A)
    - C. TWO DUST COLLECTORS (110V, 12A EACH)
  - SCENARIO D:
    - A. ONE GRINDER (120V, 15A)
    - B. ONE BLASTAC (110V, 12A)
    - C. TWO DUST COLLECTORS (110V, 12A EACH)
- FOR OPTION 2, THE TEMPORARY CONSTRUCTION TOOLS UTILIZED WILL BE THE SAME AS OPTION 1 WITH THE ADDITION OF CONNECTING TWO AIR HOGS TO (E) RECEPTACLES. REFER TO THE PANEL SCHEDULES ON SHEET E5.02 FOR THE LOAD DRAW FOR EACH SCENARIO.
- PROVIDE TEMPORARY NEMA L6-30 RECEPTACLE FOR GRINDER (208V, 1 PHASE, 4KVA) FOR SCENARIO A AND B. FIELD VERIFY EXACT LOCATION. REMOVE RECEPTACLE AFTER WORK IN ROOM IS COMPLETED.
- PROVIDE TEMPORARY NEMA 6-20 RECEPTACLE FOR BLASTAC (208V, 1PHASE, 7.2A) FOR SCENARIO C. FIELD VERIFY EXACT LOCATION. REMOVE RECEPTACLE AFTER WORK IN ROOM IS COMPLETED.



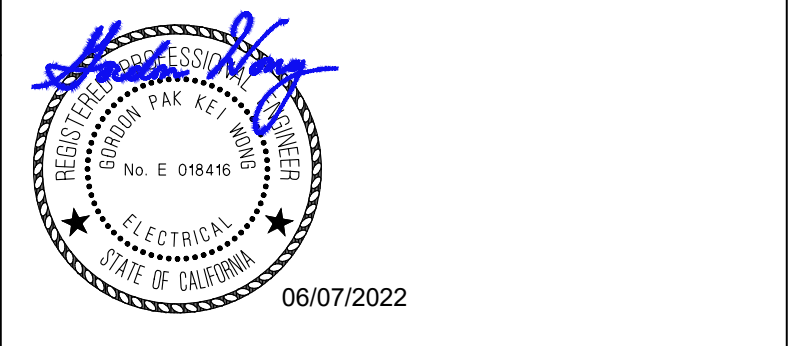
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ARCH ENGR.	SCALE	<b>E3.01</b>
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UCDMG PROJECT MGR.		
ATOSA A.		
DESIGNED BY	ISSUE DATE	
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CORY	2019	



