UCDH MEDICAL CENTER, EAST WING TOWER & EAST WING RADIOLOGY

FACILITY #10619

MATERIALS TESTING AND CONDITION ASSESSMENT PROGRAM

BUILDINGS NO. BLD-01436 & 01437 HCAI PERMIT NO. S251130-34-00 UCDH PROJECT #9558960

PROJECT DIRECTORY

CLIENT: UC DAVIS HEALTH 4800 2ND AVENUE, SUITE 2010 SACRAMENTO, CA 95817

DEGENKOLB ENGINEERS 428 J STREET, SUITE 500 SACRAMENTO, CA 95814 PHONE: (916) 418-9100

- REQUIRED MEANS OF EGRESS SHALL BE MAINTAINED DURING CONSTRUCTION AND DEMOLITION REMODELING OR ALTERATIONS AND ADDITIONS TO ANY BUILDING
- BRIS SHALL NOT BE ACCUMULATED WITHIN BUILDINGS. COMBUSTIBLE DEBRIS, RUBBISH

FIRE SAFETY DURING

CONSTRUCTION AND DEMOLITION

- AND WASTE MATERIAL SHALL BE REMOVED FROM BUILDINGS AT THE END OF EACH SHIFT OF WORK.
- 5. MATERIALS SUSCEPTIBLE TO SPONTANEOUS IGNITION, SUCH AS OILY RAGS, SHALL BE STORED IN A LISTED DISPOSAL CONTAINER.
- 6. WHEN REQUIRED BY THE FIRE CODE OFFICIAL FOR BUILDING DEMOLITION, OR BUILDING CONSTRUCTION DURING WORKING HOURS THAT IS HAZARDOUS IN NATURE. QUALIFIED PERSONNEL SHALL BE PROVIDED TO SERVE AS AN ON-SITE FIRE WATCH. FIRE WATCH PERSONNEL SHALL BE PROVIDED WITH AT LEAST ONE APPROVED MEANS FOR NOTIFICATION OF THE FIRE DEPARTMENT AND THEIR SOLE DUTY SHALL BE TO PERFORM CONSTANT PATROLS AND WATCH FOR THE OCCURRENCE OF FIRE. HCAI POLICY INTENT NOTICE
- OPERATIONS INVOLVING THE USE OF CUTTING AND WELDING SHALL BE DONE IN ACCORDANCE WITH 2022 CFC CHAPTER 35.
- B. TEMPORARY WIRING FOR ELECTRICAL POWER AND LIGHTING INSTALLATIONS USED IN CONNECTION WITH THE CONSTRUCTION, ALTERATION OR DEMOLITION OF BUILDINGS, STRUCTURES, EQUIPMENT OR SIMILAR ACTIVITIES SHALL COMPLY WITH 2022 CALIFORNIA ELECTRICAL CODE.
- 9. IMPAIRMENTS TO ANY FIRE PROTECTION SYSTEM SHALL BE IN ACCORDANCE WITH 2022 CFC SECTION 901. 10. COVERINGS PLACED ON OR OVER FIRE PROTECTION DEVICES TO PROTECT THEM FROM DAMAGE DURING CONSTRUCTION PROCESSES SHALL BE IMMEDIATELY REMOVED UPON THE COMPLETION OF THE CONSTRUCTION PROCESSES IN THE ROOM OR AREA IN WHICH THE DEVICES ARE INSTALLED.
- 1. STRUCTURES UNDER CONSTRUCTION, ALTERATION OR DEMOLITION SHALL BE PROVIDED WITH NOT LESS THAN ONE APPROVED PORTABLE FIRE EXTINGUISHER IN ACCORDANCE WITH 2022 CFC SECTION 906 AND SIZED FOR NOT LESS THAN ORDINARY HAZARD AS FOLLOWS: A. AT EACH STAIRWAY ON ALL FLOOR LEVELS WHERE COMBUSTIBLE MATERIALS HAVE ACCUMULATED. B. IN EVERY STORAGE AND CONSTRUCTION SHED.

C. ADDITIONAL PORTABLE FIRE EXTINGUISHERS SHALL BE PROVIDED WHERE SPECIAL HAZARDS EXIST

- INCLUDING, BUT NOT LIMITED TO, THE STORAGE AND USE OF FLAMMABLE AND COMBUSTIBLE LIQUID 2. IN OCCUPIED BUILDINGS, WHERE TEMPORARY CONSTRUCTION BARRIERS ARE REQUIRED TO BE INSTALLED DURING THE CONSTRUCTION OR RECONSTRUCTION OF FIRE-RESISTIVE ASSEMBLIES. TEMPORARY CONSTRUCTION SHALL MEET THE SAME FIRE RATING AS WOULD THE PERMANENT PARTITION. USE OF PLASTIC OR VINYL DUST BARRIERS IN LIEU OF FIRE RATED SEPARATIONS IS PROHIBITED. TEMPORARY CONSTRUCTION BARRIERS ARE NOT REQUIRED WHERE ADEQUATE FIRE-RESISTIVE SEPARATION CAN BE DEMONSTRATED TO EXIST BETWEEN OCCUPIED AREAS AND CONSTRUCTION AREAS. SMOKE COMPARTMENTS AND REFUGE AREAS IN COMPLIANCE WITH 2022 CBC SECTION 407 SHALL BE
- MAINTAINED THROUGHOUT THE PERIOD OF CONSTRUCTION. A. DOORS WILL ACT AS CONSTRUCTION BARRIERS WHERE WORK IS LOCATED IN ROOMS B. WHERE TEMPORARY CONSTRUCTION BARRIERS AFFECT ANY EXIT COMPONENT, PRE-APPROVAL SHALL BE OBTAINED FROM THE LOCAL FIRE JURISDICTION AND HCAI PRIOR TO START OF ANY DEMOLITION OR
- 13. EXISTING MEANS OF EGRESS NEED NOT BE MAINTAINED WHERE APPROVED TEMPORARY MEANS OF EGRESS SYSTEMS AND FACILITIES ARE PROVIDED. REQUIRED MEANS OF EGRESS SHALL BE MAINTAINED AT ALL TIMES DURING CONSTRUCTION, DEMOLITION, REMODELING OR ALTERATIONS AND ADDITIONS TO ANY BUILDING. A HORIZONTAL EXIT SHALL NOT BE DESTROYED UNLESS AND UNTIL A SUBSTITUTE MEANS OF EGRESS HAS BEEN PROVIDED AND APPROVED.
- 14. IF WORK CANNOT BE COMPLETED AND REPAIRED IN THE SAME DAY AND TEMPORARY CONSTRUCTION BARRIERS ARE REQUIRED IN THE FIELD, CONTRACTOR TO NOTIFY SEOR AND AOR. DESIGN, ANCHORAGE AND BRACING OF TEMPORARY CONSTRUCTION BARRIERS AROUD THE AFFECTED AREA WILL BE PROVIDED TO PROVIDE FIRE RATING TO MATCH EXISTING CONDITIONS PER CAN 9-3301. APPROVAL SHALL BE OBTAINED FROM TEH LOCAL FIRE JURISDICTION AND HCAI PRIOR TO THE START OF DEMOLITION IN THE AREA OF WORK REQUIRING A TEMPORARY BARRIER.
- 15. IF ANY SPRAY APPLIED FIRE PROTECTION IS REMOVED OR DAMAGED, A COPY OF A LISTED SYSTEM THAT WILL BE USED TO RESTORE THE SPRAYED-ON FIREPROOFING SHALL BE PROVIDED TO THE HCAI FIELD FIRE MARSHALL DEMONSTRATING THAT THE REQUIRED HOURLY RATING IS BEING MAINTAINED AND THAT THE SYSTEM IS COMPATIBLE WITH THE EXISTING FIRE PROOFING MATERIAL. PER 2022 CBC SECTIONS 1705A.13
- 16. FIRE RESISTANCE RATED WALLS/ CEILINGS SHALL BE REPAIRED / PATCHED TO MATCH THE EXISTING RATED CONDITION TO MAINTAIN THE CONTINUITY OF THE RATED WALL OR CEILING SYSTEM. A COPY OF A LISTED SYSTEM SHALL BE PROVIDED TO THE HCAI FIELD FIRE MARSHALL PER 2022 CFC SECTION 703.1 AND CBC SECTIONS 602.1, 703.3 AND 711.2.
- **OWNER'S RESPONSIBILITY FOR FIRE PROTECTION** 1. THE FIRE PREVENTION PROGRAM SUPERINTENDENT SHALL BE RESPONSIBLE FOR SUPERVISING THE PERMIT SYSTEM FOR HOT WORK OPERATIONS IN ACCORDANCE WITH 2022 CFC CHAPTER 35.

DISCLAIMER

THESE COMPOSITION PLANS WERE DEVELOPED USING THE RECORD CONSTRUCTION PLANS PROVIDED BY

PROJECT DESCRIPTION & INTENT

- B. GROUT PATCHING ALL AREAS WHERE THE CONCRETE AND REINFORCING BAR SAMPLES/OBSERVATIOI
-). REMOVAL OF REINFORCING STEEL SAMPLES FOR OFF-SITE TESTING E. REMOVAL OF METAL DECK SAMPLES FOR OFF-SITE TESTING.

APPLICABLE CODES / REGULATIONS

AUTHORITY HAVING JURISDICTION GOVERNING CODES:

- OFFICE OF STATEWIDE HEALTH PLANNING AND DEVELOPMENT
- THE FOLLOWING ARE THE ENFORCEABLE CODES FOR FACILITIES UNDER THE AUTHORITY OF THE ALFRED E. ALQUIST HOSPITAL FACILITIES SAFETY ACT OF 1983:
- 2022 CALIFORNIA ADMINISTRATIVE CODE (CAC) PART 1, TITLE 24, CALIFORNIA CODE OF REGULATIONS (CCR)

2022 CALIFORNIA BUILDING CODE (CBC) PART 2, TITLE 24, CCR

- BASED ON THE 2021 INTERNATIONAL BUILDING CODE (IBC)
- PART 3, TITLE 24, CCR BASED ON THE 2020 NATIONAL ELECTRICAL CODE (NEC)
- 2022 CALIFORNIA MECHANICAL CODE (CMC)

2022 CALIFORNIA ELECTRICAL CODE (CEC)


PART 4, TITLE 24, CCR BASED ON THE 2021 UNIFORM MECHANICAL CODE (UMC)

BASED ON THE 2021 INTERNATIONAL FIRE CODE (IFC)

- 2022 CALIFORNIA PLUMBING CODE (CPC) PART 5, TITLE 24, CCR BASED ON THE 2021 UNIFORM PLUMBING CODE (UPC)
- 2022 CALIFORNIA FIRE CODE (CFC)

PART 9. TITLE 24. CCR

VICINITY MAP

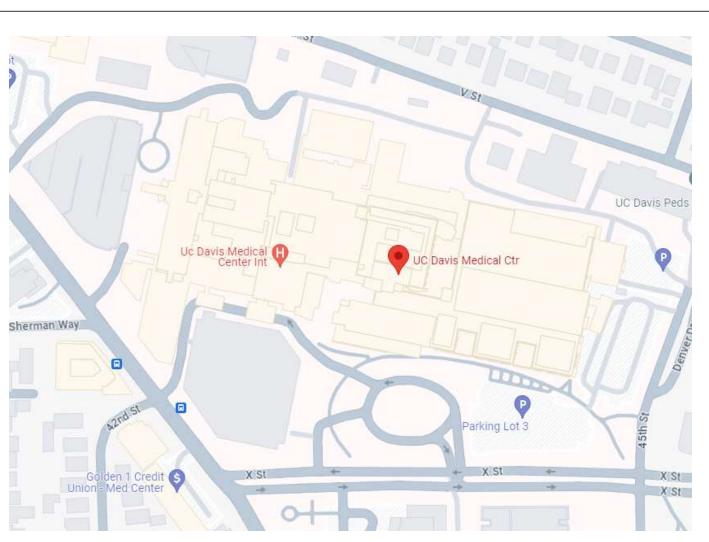

University of California Davis Medical Center Facility No. 10619 D-05815 CT Scan Building - Bldg 15 Laundry) - Bldg 05 3LD-07281 Gas Bottle Storage - Bldg 17 BLD-07265 Mechanical Room - Bldg 10A LD-07262 Loading Dock Canopy - Bldg 12A LD-01443 Emergency Roon LD-01445 Davis Tower - Bldg 12 xpansion - Bldg 10 LD-02841 Surgery and Emergency Services LD-01436 East Wing as - Bldg 100 Radiology, SLD-07263 Entry anopy - Bldg 101E ower Canopy - Bldg 06 BLD-07261 Surgery Canopy - BLD-101C Services Pavilion Nest - Bldg 101A D-06783 California Canopy - Bldg 103

CAMPUS MAP

GENERAL CONSTRUCTION NOTES

- 1. GENERAL NOTES APPLY TO ALL DRAWINGS. 2. LABOR, MATERIALS, CONSTRUCTION METHODS AND WORK TO CONFORM TO THE LATEST GOVERNING CODES, RULES AND REGULATIONS FOR THIS PROJECT AND JURISDICTION. THE MOST STRINGENT :. WHEN REQUIRED BY CODE, RULES OR REGULATIONS, WORK MUST BE INSPECTED AND APPROVED BY AUTHORITY HAVING JURISDICTION.
- 4. CONTRACTOR TO WALK SITE WITH OWNER TO CONFIRM LOCATIONS OF WORK PRIOR TO START OF CONSTRUCTION. CONTRACTOR TO VERIFY ARCHITECTURAL FINISHES IN FIELD PRIOR TO START OF 5. VERIFY EXISTING CONDITIONS AND DIMENSIONS PRIOR TO FABRICATION AND/OR CONSTRUCTION; NOTIFY ARCHITECT OF ANY DISCREPANCIES BETWEEN EXISTING CONDITIONS AND THESE DRAWINGS WHICH EFFECT THE SCOPE AND INTENT OF THE WORK DESCRIBED IN THE CONSTRUCTION DOCUMENTS. 6. THE WORK INDICATED IN THE NOTES DESCRIBES THE GENERAL SCOPE OF WORK AND IS NOT INTENDED TO BE INCLUSIVE OF ALL WORK REQUIRED TO COMPLETE FULL SCOPE OF WORK. 7. DO NOT MEASURE DRAWINGS. DIMENSIONS TO BE FIELD MEASURED AND VERIFIED. NOTIFY ARCHITECT OF ANY DISCREPANCIES.
- 8. DIMENSIONING ON PLANS IS AS FOLLOWS UNLESS OTHERWISE NOTED: A. TO FACE OF MASONRY

NOTED ITEMS. PROTECT STRUCTURAL COLUMNS, BEAMS AND FRAMING

- B. TO FACE OF CONCRETE C. TO FACE OF STUD IN FRAMED PARTITIONS
- 9. PRIOR TO DEMOLITION, CONTRACTOR TO COORDINATE WITH FACILITY OWNER SEOR TO IDENTIFY ITEMS (QUANTITY AND QUALITY) TO BE SALVAGED. DELIVER SALVAGED ITEMS TO THE OWNER. THIS MAY INCLUDE BUT IT NOT LIMITED TO CASEWORK, FURNITURE, DOORS, DOOR HARDWARE, DISPENSERS, MARKERBOARDS, MEDICAL EQUIPMENT, MEDICAL GAS ITEMS, PLUMBING FIXTURES, LIGHT FIXTURES. AND MECHANICAL EQUIPMENT. ALL OTHER ITEMS SHALL BE DISPOSED OF BY CONTRACTOR. 10. PROVIDE AND MAINTAIN TEMPORARY FACILITIES AND UTILITY SERVICES AS REQUIRED FOR THE PROPER COMPLETION OF THE PROJECT. UPON COMPLETION OF THE WORK, REMOVE ALL TEMPORARY 11. PROTECT ADJACENT AREAS TO PREVENT CONTAMINATION AND NUISANCE BY CONSTRUCTION DUST AND DEBRIS. PROVIDE TEMPORARY PROTECTION FOR ADJACENT FINISHES. PROMPTLY REPAIR ANY DAMAGE AT NO ADDITIONAL COST TO THE OWNER. PROTECT ADJACENT ITEMS THAT ARE TO REMAIN INCLUDING BUT NOT LIMITED TO, FINISHES, CASEWORK, FURNITURE, DOORS, PLUMBING FIXTURES,
- CEILING ASSEMBLIES. MECHANICAL AND ELECTRICAL EQUIPMENT 12. COMPLIANT DUST BARRIERS SHALL BE INSTALLED TO CONTAIN DUST AT THE AREAS WHERE CONCRETE CORES ARE TAKEN, BUT THEY ARE NOT INTENDED TO SERVE AS CONSTRUCTION BARRIERS. 13. PROVIDE TEMPORARY BARRICADES AS NECESSARY TO ENSURE PROTECTION OF THE PUBLIC. MAINTAIN ALL REQUIRED PATHS OF BUILDING EGRESS. MAINTAIN EGRESS WITHIN AND AROUND 14. PROTECT THE STRUCTURE DURING CONSTRUCTION. SUCH MEASURES INCLUDE, BUT MAY NOT BE LIMITED TO, BRACING AND SHORING FOR LOADS DURING CONSTRUCTION. RETAIN A REGISTERED

STRUCTURAL ENGINEER WHOM IS PROPERLY QUALIFIED TO DESIGN BRACING, SHORING, ETC. VISITS TO THE SITE BY THE OWNER'S REPRESENTATIVE WILL NOT INCLUDE OBSERVATION OF THE ABOVE

- 15. PROVIDE SUITABLE WASTE DISPOSAL UNITS AND EMPTY REGULARLY. DO NOT PERMIT ACCUMULATION OF TRASH AND WASTE MATERIALS. REMOVE AND DISCARD ALL DEBRIS, DUST, WATER, AND OTHER SUBSTANCES RESULTING FROM THE REMOVAL OF THE TESTING SAMPLE 16. ASBESTOS ABATEMENT; REMOVE AND REPLACE FIREPROOFING RATING TO ELEMENT WITH APPROPRIATE PRODUCT 7. THERE ARE ISOLATED LOCATIONS WHERE CONCRETE CORE SAMPLES WILL BE TAKEN FROM WALLS AT EXIT STAIRS AND AT OTHER RATED WALLS. THIS WORK IS TO BE COMPLETED WITHIN AN 8 HOUR PERIOD. IF AFTER 8 HOURS. THE WORK IS NOT COMPLETE. THE WALLS ARE TO BE RETURNED TO A STATE WHERE THEY COMPLY WITH 2016 CBC EXITING AND FIRE/LIFE SAFETY REQUIREMENTS. 18. TEMPORARY CONSTRUCTION BARRIERS ARE NOT REQUIRED. WHERE WORK IN THE FIELD DETERMINES BARRIERS ARE NEEDED DUE TO UNFORSEEN CONDITIONS, SEE FIRE LIFE SAFETY NOTES FOR
- REQUIREMENTS. 19. PROVIDE SCAFFOLDING, RIGGING, HOISTING AND SERVICES NECESSARY FOR COMPLETION OF THE WORK. 20. OWNER WILL LIMIT HOURS OF CERTAIN TYPES OF NOISE PRODUCING CONSTRUCTION OPERATIONS; COORDINATE WITH OWNER'S REPRESENTATIVE. 21. PATCH AND REPAIR FLOOR, PARTITION, AND CEILING PENETRATIONS WHERE ITEMS HAVE BEEN REMOVED TO MATCH EXSITING FINISH. SEAL RATED ASSEMBLIES WITH APPROVED U.L. RATED MATERIALS
- 22. REMOVE EXISTING FLOOR FINISHES AND PREPARE EXISTING SLAB FOR NEW FINISH INSTALLATION, U.O.N. 23. ALL REPLACED FINISHES ARE TO MATCH EXISTING FINISHES - COORDINATE WITH THE FACILITY TO UTILIZE EXISTING "ATTIC STOCK" WHERE POSSIBLE. WHERE NOT POSSIBLE PROVIDE EQUAL FINISHES FOR REVIEW AND APPROVAL PRIOR TO INSTALLATION. 24. ALL NEW FINISHES ARE REQUIRED TO BE CLASS A RATED. REVIEW NEW MATERIALS WITH FLSO PRIOR TO INSTALLATION.
- 25. FIRE RESISTANCE OF RATED WALLS / CEILINGS SHALL BE REPAIRED / PATCHED TO MATCH THE EXISTING RATED CONDITION TO MAINTAIN THE CONTINUITY OF THE RATED WALL OR CEILING SYSTEM. A COPY OF A LISTED SYSTEM SHALL BE PROVIDED TO THE FIRE MARSHALL. PER C.F.C. SECTION 703.1 AND C.B.C. SECTION 602.1, 703.3 AND 711.2.

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AC-003	FLOOR PLAN LEVEL 0 - SW FIRE/LIFE SAFETY	
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BUILDING INFORMATION

8 STORIES OVER BASEMENT

09 - CONCRETE SHEAR WALL

1 STORY OVER BASEMENT

STORIES:

STORIES:

OCCUPANCY GROUP:

FULLY SPRINKLERED:

OCCUPANCY GROUP:

FULLY SPRINKLERED:

03 - STEEL MOMENT RESISTING FRAMES



428 J Street, Suite 500 Sacramento, CA 95814 916.418.9100 PHONE

DE Job Number: **SEALS AND SIGNATURES**

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Devenney Group Ltd., Architects 201 W. Indian School Road Phoenix, Arizona 85013 www.devenneygroup.com

SEALS AND SIGNATURES

Description

AUTHORITY HAVING JURISDICTION:

AUTHORITY HAVING JURISDICTION'S PROJECT NO. S251130-34-00

FACILITY NUMBER

AGENCY APPROVALS:



UCDH MEDICAL CENTER EAST WING TOWER & EAST WING RADIOLOGY

Sheet Title:

Drawing Number:


COVER SHEET

C2953022.05 Job Number: Drawn by: Design by: Checked by: 07/10/2025 Date:

As indicated

THE CLIENT. RECORD DRAWINGS WERE UTILIZED TO GENERATE THE COMPOSITE ARCHITECTURAL FLOOR PLANS. VERIFICATIONS WERE MADE FOR MINOR ALTERATION AND DEVIATIONS FROM THE ORIGINAL CONSTRUCTION PLANS. EXTENSIVE AS-BUILT VERIFICATION WAS NOT PERFORMED FOR THE COMPOSITE ARCHITECTURAL FLOOR PLAN AND CEILING PLAN. THE COMPOSITE ARCHITECTURAL PLANS WERE UTILIZED FOR THE BASE PLANS FOR THE DEVELOPMENT OF THE MECHANICAL AND ELECTRICAL COMPOSITE PLANS.

LIMITED FIELD VERIFICATION OF MECHANICAL AND ELECTRICAL SYSTEMS WERE PERFORMED TO DETERMINE LOCATIONS OF EQUIPMENT, DUCTWORK, MAIN SUPPLY PIPING, VALVES, FIRE SPRINKLER SYSTEM, MAJOR COMPONENTS WITH MAIN PIPING, ELECTRICAL PANELS, ELECTRICAL EQUIPMENT, FEATURES OF FIRE PROTECTION AND LIFE SAFETY SYSTEMS.

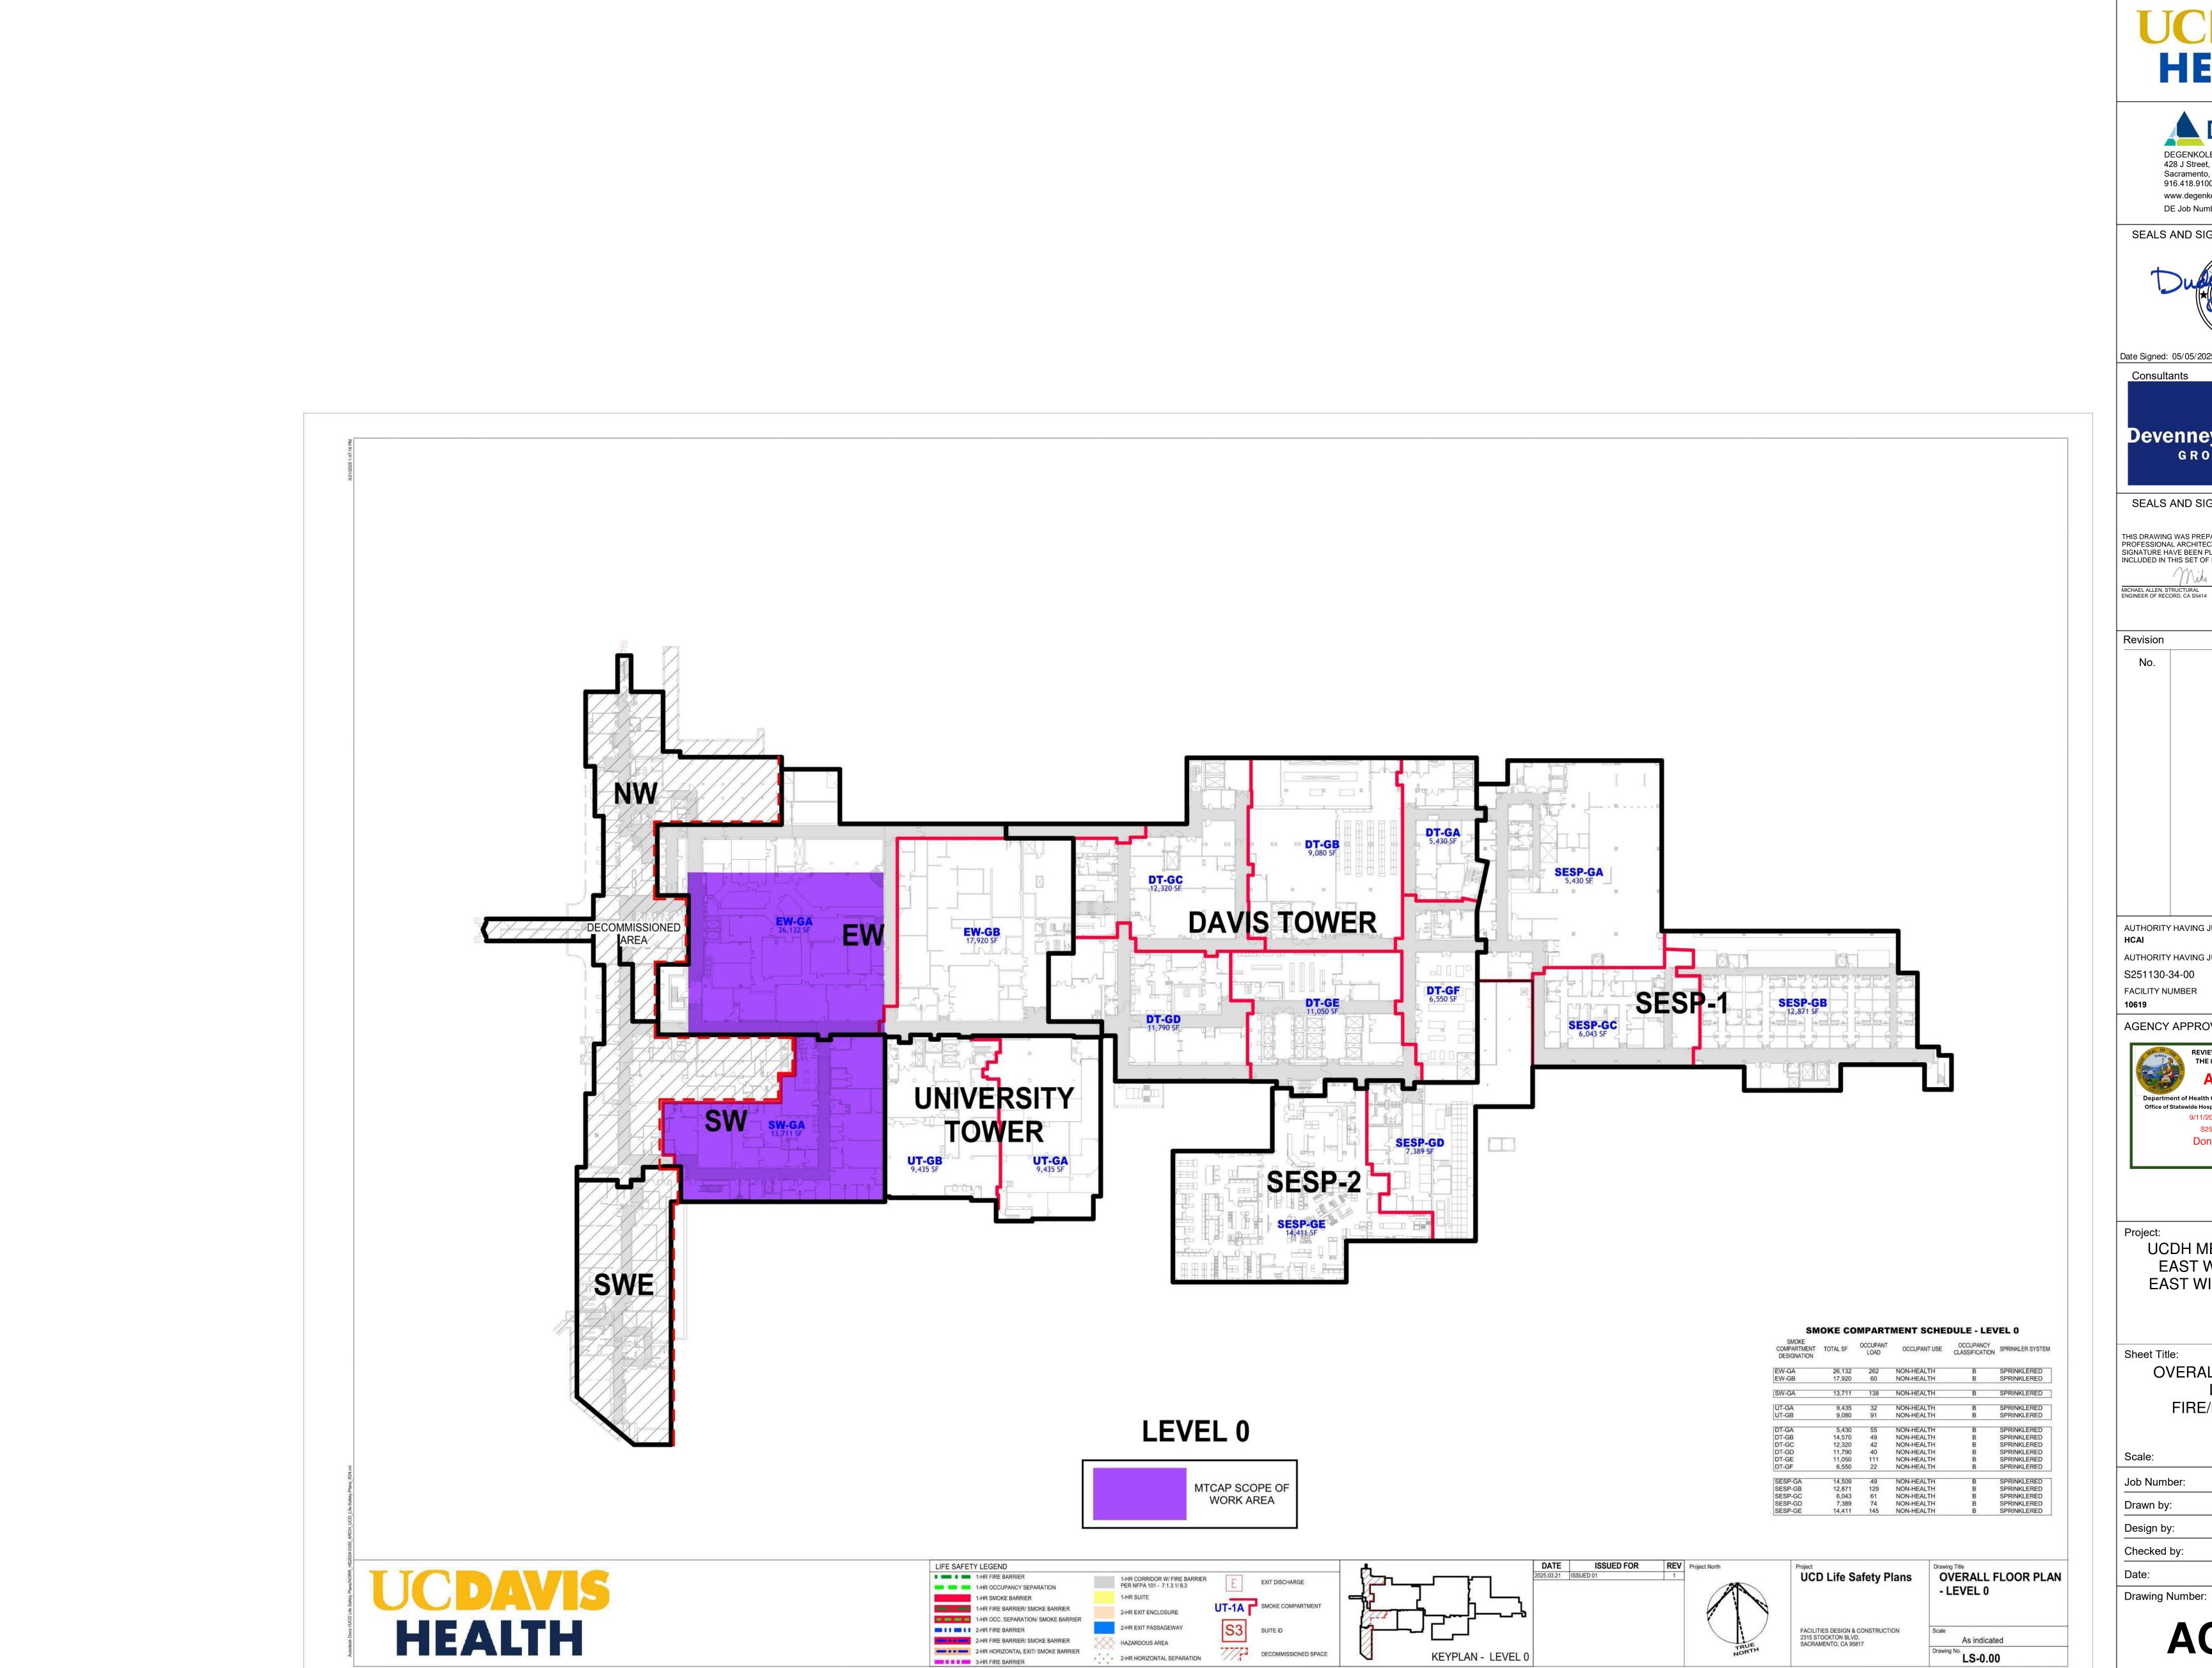

three-quarters inch = one foot

one inch = one foot

one and one-half inches = one foot

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three inches = one foot

HEALTH



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07/10/2025 DATE

Date Description

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AUTHORITY HAVING JURISDICTION'S PROJECT NO. S251130-34-00

AGENCY APPROVALS:



UCDH MEDICAL CENTER EAST WING TOWER & EAST WING RADIOLOGY

MTCAP

OVERALL FLOOR PLAN LEVEL 0 FIRE/LIFE SAFETY

NTS 9167.25.0001 Job Number: May 2, 2025

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AC-001

one-eighth inch = one foot

one-quarter inch = one foot

OWNER: 428 J Street, Suite 500 Consultants SWITCHGEAR ELEC 0406 Revision CORR 0401A EW-GB FACILITY NUMBER Sheet Title: Scale: LEVEL 0 - EW PLAN SCALE: 3/32" = 1'-0"
 DATE
 ISSUED FOR
 REV
 Project North

 2025.03.21
 ISSUED 01
 1

LIFE SAFETY LEGEND

■ ■ 1-HR FIRE BARRIER

2-HR FIRE BARRIER

3-HR FIRE BARRIER

1-HR OCCUPANCY SEPARATION

1-HR FIRE BARRIER/ SMOKE BARRIER

2-HR FIRE BARRIER/ SMOKE BARRIER 2-HR HORIZONTAL EXIT/ SMOKE BARRIER

1-HR OCC. SEPARATION/ SMOKE BARRIER

1-HR SMOKE BARRIER

1-HR CORRIDOR W/ FIRE BARRIER PER NFPA 101 - 7.1.3.1/8.3

2-HR EXIT ENCLOSURE

2-HR HORIZONTAL SEPARATION

2-HR EXIT PASSAGEWAY

UT-1A SMOKE COMPARTMENT

SUITE ID

three-quarters inch = one foot

one inch = one foot

one and one-half inches = one foot

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three inches = one foot



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07/10/2025 MICHAEL ALLEN, STRUCTURAL ENGINEER OF RECORD, CA S5414 DATE

No.	Description	Date

AUTHORITY HAVING JURISDICTION:

AUTHORITY HAVING JURISDICTION'S PROJECT NO. S251130-34-00

AGENCY APPROVALS:



UCDH MEDICAL CENTER EAST WING TOWER & EAST WING RADIOLOGY MTCAP

> FLOOR PLAN LEVEL 0 - EW FIRE/LIFE SAFETY

NTS 9167.25.0001 Job Number: Drawn by: Design by: Checked by: May 2, 2025 Date:

Drawing Number:

UCD Life Safety Plans

Drawing Title

LEVEL 0 - EW

As indicated

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Drawing No. LS-0.01

FACILITIES DESIGN & CONSTRUCTION 2315 STOCKTON BLVD, SACRAMENTO, CA 95817

AC-002

one-eighth inch = one foot

one-quarter inch = one foot

one-half inch = one foot

HEALTH

www.degenkolb.com DE Job Number: C2953022.04 Date Signed: 05/05/2025 Consultants GROUF MICHAEL ALLEN, STRUCTURAL ENGINEER OF RECORD, CA S5414 Revision Description AUTHORITY HAVING JURISDICTION: S251130-34-00 FACILITY NUMBER AGENCY APPROVALS: Sheet Title: Scale: Job Number: Drawn by: Design by: LEVEL 0 - SW PLAN Checked by: SCALE: 3/32" = 1'-0"
 DATE
 ISSUED FOR
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 Project North

 2025.03.21
 ISSUED 01
 1
 UCD Life Safety Plans

Drawing Title

LEVEL 0 - SW LIFE SAFETY LEGEND Date: ■ ■ 1-HR FIRE BARRIER 1-HR CORRIDOR W/ FIRE BARRIER PER NFPA 101 - 7.1.3.1/ 8.3 EXIT DISCHARGE 1-HR OCCUPANCY SEPARATION Drawing Number: 1-HR SMOKE BARRIER UT-1A SMOKE COMPARTMENT 1-HR FIRE BARRIER/ SMOKE BARRIER 2-HR EXIT ENCLOSURE HEALTH 1-HR OCC. SEPARATION/ SMOKE BARRIER 2-HR EXIT PASSAGEWAY 2-HR FIRE BARRIER FACILITIES DESIGN & CONSTRUCTION 2315 STOCKTON BLVD, SACRAMENTO, CA 95817 SUITE ID As indicated 2-HR FIRE BARRIER/ SMOKE BARRIER Drawing No. LS-0.02 2-HR HORIZONTAL EXIT/ SMOKE BARRIER 2-HR HORIZONTAL SEPARATION 3-HR FIRE BARRIER ARCH E1 Title Block - v.2023 - Rev (July/23) - Copyright © 2023

one inch = one foot

three-quarters inch = one foot

one and one-half inches = one foot

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three inches = one foot

REFER TO GRAPHIC SCALE OWNER:






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AUTHORITY HAVING JURISDICTION'S PROJECT NO.



UCDH MEDICAL CENTER EAST WING TOWER & EAST WING RADIOLOGY MTCAP
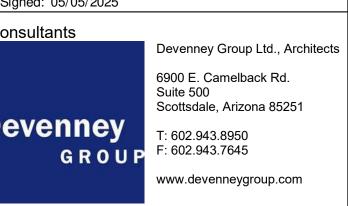
> FLOOR PLAN LEVEL 0 - SW FIRE/LIFE SAFETY


NTS 9167.25.0001 May 2, 2025

AC-003

of Sheets

one-eighth inch = one foot

one-quarter inch = one foot

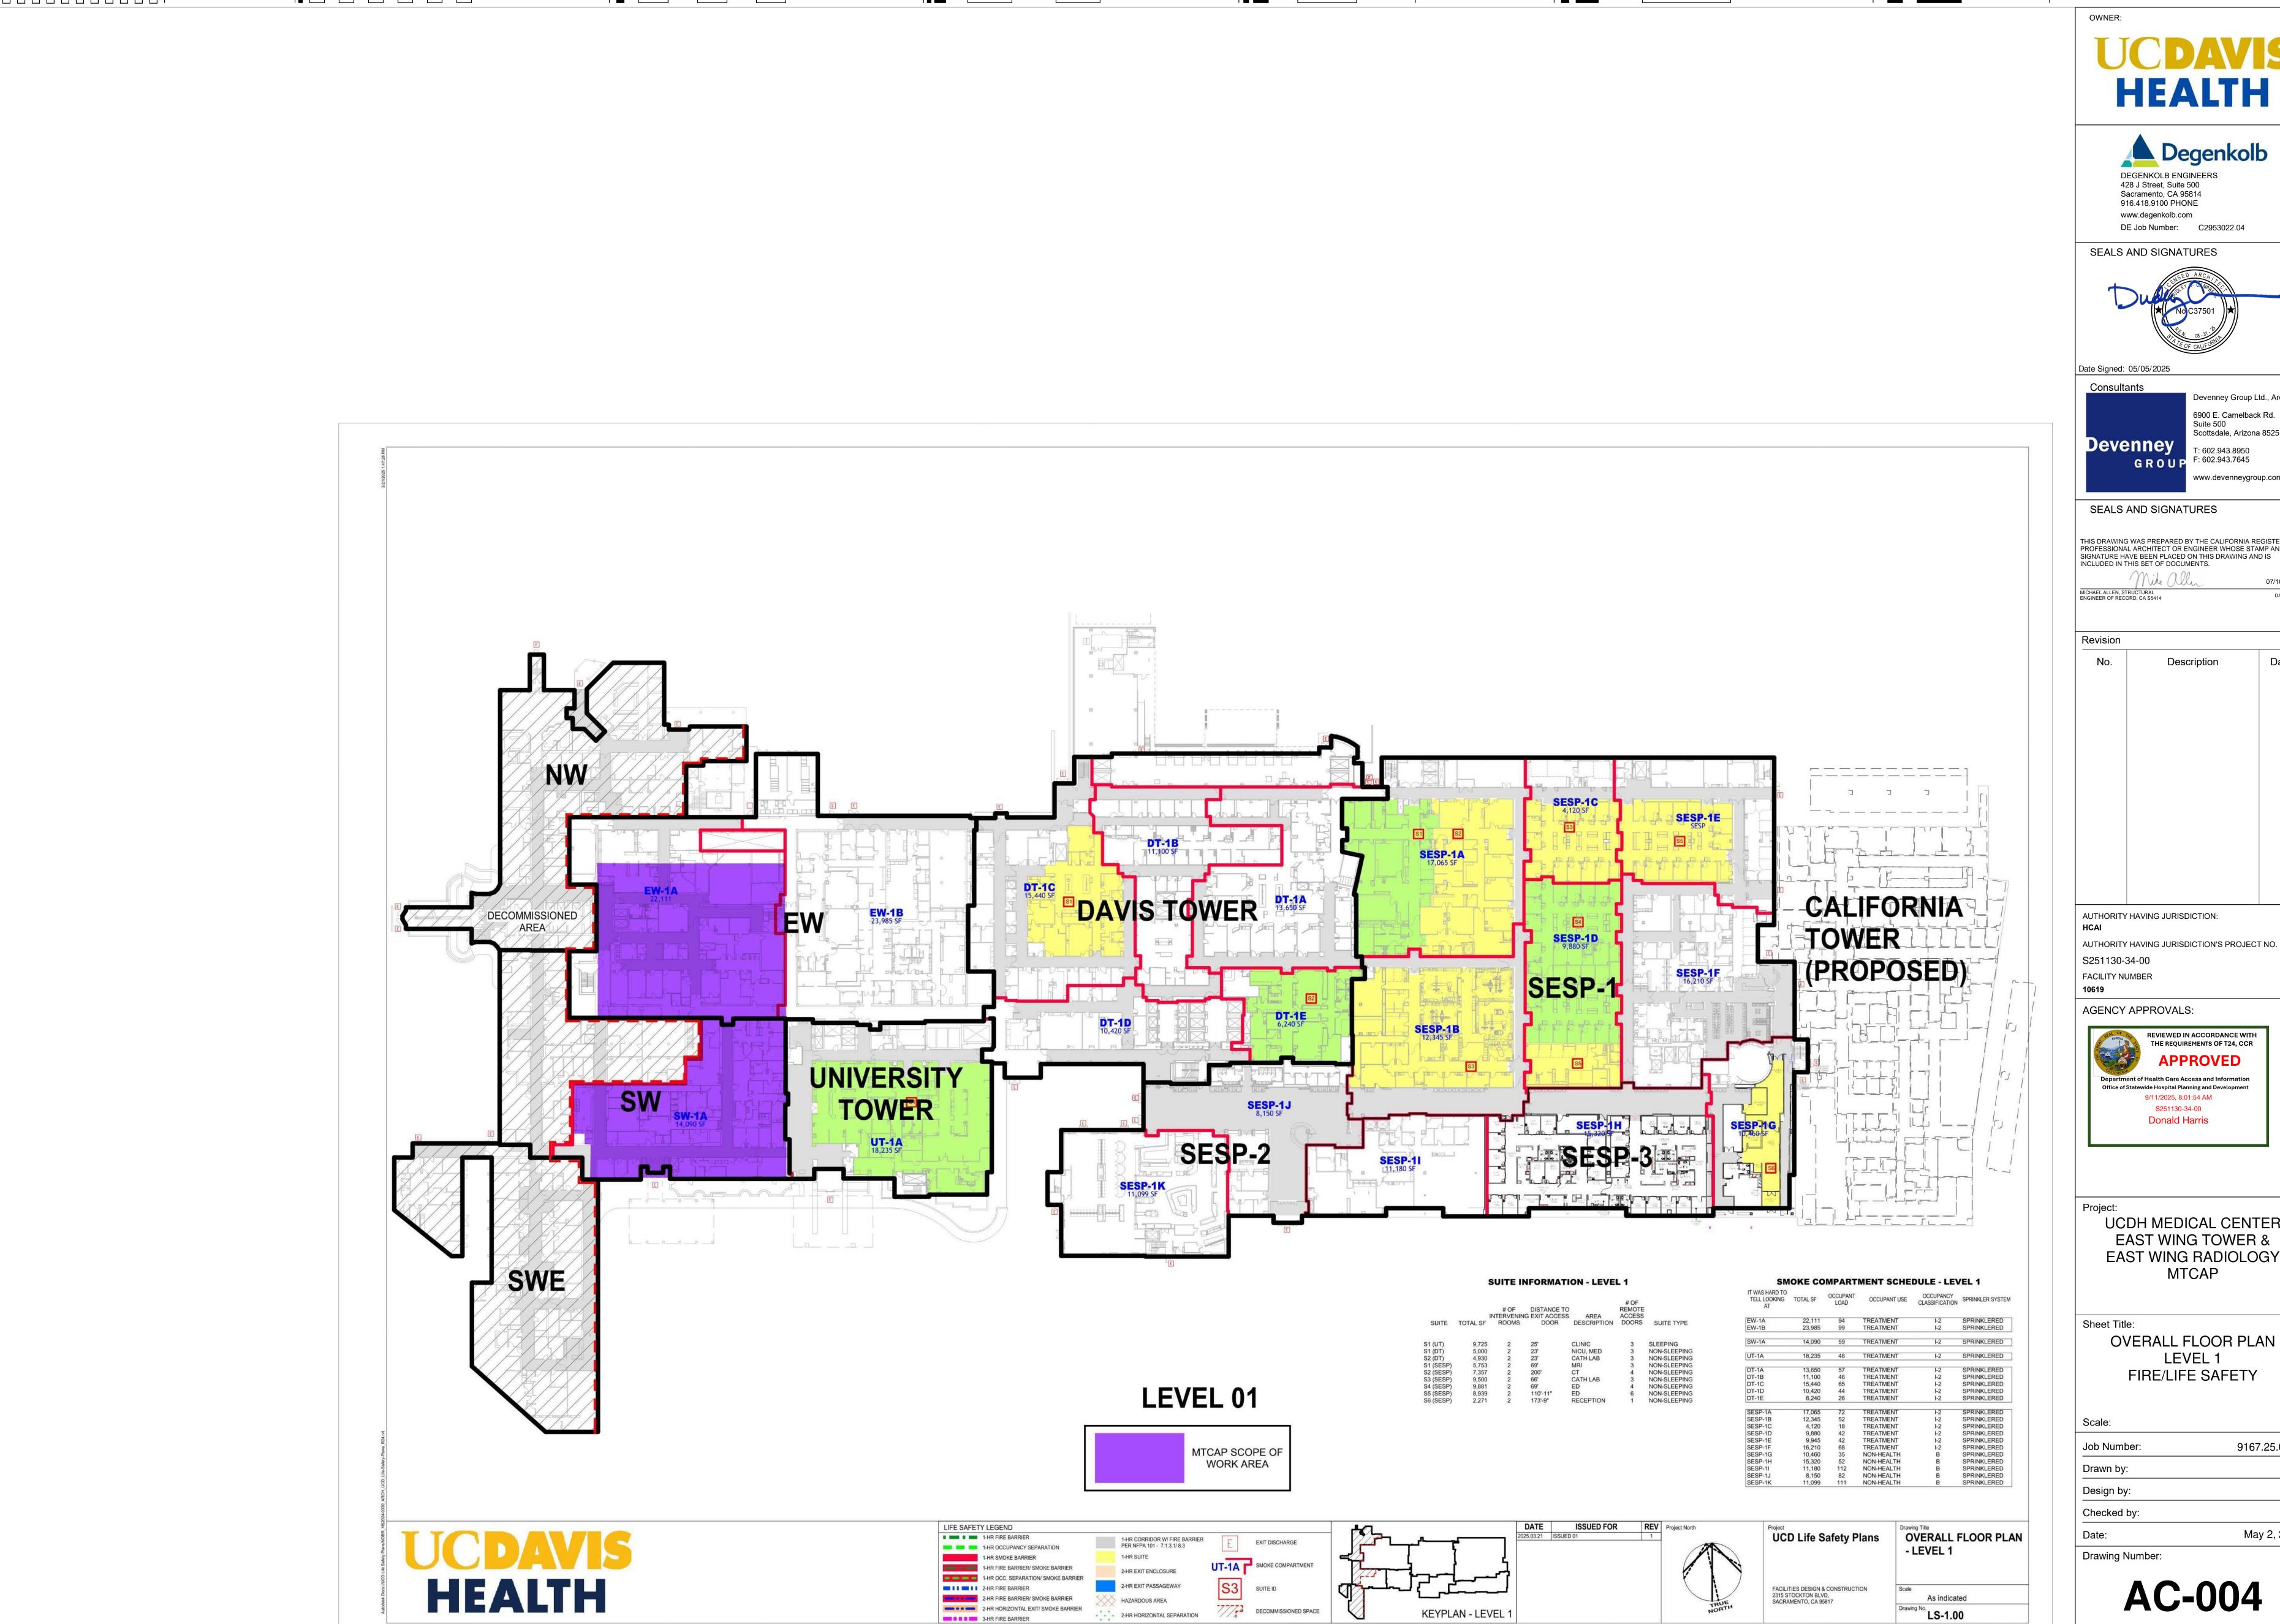

3-HR FIRE BARRIER

one inch = one foot

one and one-half inches = one foot

three-quarters inch = one foot

one-quarter inch = one foot

one-eighth inch = one foot

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HEALTH







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07/10/2025 DATE

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AUTHORITY HAVING JURISDICTION'S PROJECT NO.



UCDH MEDICAL CENTER EAST WING TOWER &

OVERALL FLOOR PLAN LEVEL 1

9167.25.0001 May 2, 2025

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three-quarters inch = one foot one inch = one foot one-quarter inch = one foot one and one-half inches = one foot one-half inch = one foot three inches = one foot one-eighth inch = one foot OWNER: DE Job Number: C2953022.04 Consultants Revision EW-1A FACILITY NUMBER ILHII Sheet Title: Scale: Drawn by: Design by: LEVEL 1 - EW PLAN SCALE: 3/32" = 1'-0"
 DATE
 ISSUED FOR
 REV
 Project North

 2025.03.21
 ISSUED 01
 1
 LIFE SAFETY LEGEND UCD Life Safety Plans

Drawing Title

LEVEL 1 - EW Date: ■ ■ 1-HR FIRE BARRIER 1-HR CORRIDOR W/ FIRE BARRIER PER NFPA 101 - 7.1.3.1/8.3 1-HR OCCUPANCY SEPARATION 1-HR SMOKE BARRIER UT-1A SMOKE COMPARTMENT

1-HR FIRE BARRIER/ SMOKE BARRIER

2-HR FIRE BARRIER/ SMOKE BARRIER

2-HR HORIZONTAL EXIT/ SMOKE BARRIER

2-HR FIRE BARRIER

3-HR FIRE BARRIER

HEALTH

1-HR OCC, SEPARATION/ SMOKE BARRIER

2-HR EXIT ENCLOSURE

2-HR HORIZONTAL SEPARATION

SUITE ID

DECOMMISSIONED SPACE

KEYPLAN - LEVEL 1

2-HR EXIT PASSAGEWAY

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HEALTH



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AUTHORITY HAVING JURISDICTION'S PROJECT NO. S251130-34-00

AGENCY APPROVALS:



UCDH MEDICAL CENTER EAST WING TOWER & EAST WING RADIOLOGY MTCAP

> FLOOR PLAN LEVEL 1 - EW FIRE/LIFE SAFETY

NTS 9167.25.0001 Job Number: Checked by: May 2, 2025

Drawing Number:

FACILITIES DESIGN & CONSTRUCTION 2315 STOCKTON BLVD, SACRAMENTO, CA 95817

As indicated

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Consultants Revision FACILITY NUMBER Sheet Title: Scale: Drawn by: LEVEL 1 - SW PLAN SCALE: 3/32" = 1'-0"
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 1
 UCD Life Safety Plans

Drawing Title

LEVEL 1 - SW LIFE SAFETY LEGEND Date: ■ ■ 1-HR FIRE BARRIER 1-HR CORRIDOR W/ FIRE BARRIER PER NFPA 101 - 7.1.3.1/ 8.3 EXIT DISCHARGE 1-HR OCCUPANCY SEPARATION 1-HR SMOKE BARRIER UT-1A SMOKE COMPARTMENT 1-HR FIRE BARRIER/ SMOKE BARRIER 2-HR EXIT ENCLOSURE 1-HR OCC. SEPARATION/ SMOKE BARRIER HEALTH 2-HR EXIT PASSAGEWAY 2-HR FIRE BARRIER FACILITIES DESIGN & CONSTRUCTION 2315 STOCKTON BLVD, SACRAMENTO, CA 95817 SUITE ID As indicated 2-HR FIRE BARRIER/ SMOKE BARRIER Drawing No. LS-1.02 2-HR HORIZONTAL EXIT/ SMOKE BARRIER **KEYPLAN - LEVEL 1** 2-HR HORIZONTAL SEPARATION 3-HR FIRE BARRIER

one inch = one foot

three-quarters inch = one foot

one and one-half inches = one foot

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OWNER:

HEALTH




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SEALS AND SIGNATURES



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three inches = one foot



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AUTHORITY HAVING JURISDICTION'S PROJECT NO. S251130-34-00

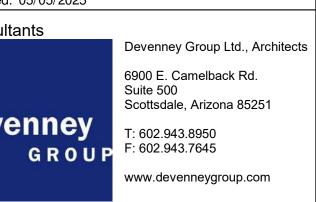AGENCY APPROVALS:



UCDH MEDICAL CENTER EAST WING TOWER & EAST WING RADIOLOGY MTCAP

> FLOOR PLAN LEVEL 1 - SW FIRE/LIFE SAFETY

NTS 9167.25.0001 Job Number: Design by: Checked by: May 2, 2025


Drawing Number:

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one-eighth inch = one foot

one-quarter inch = one foot



one inch = one foot

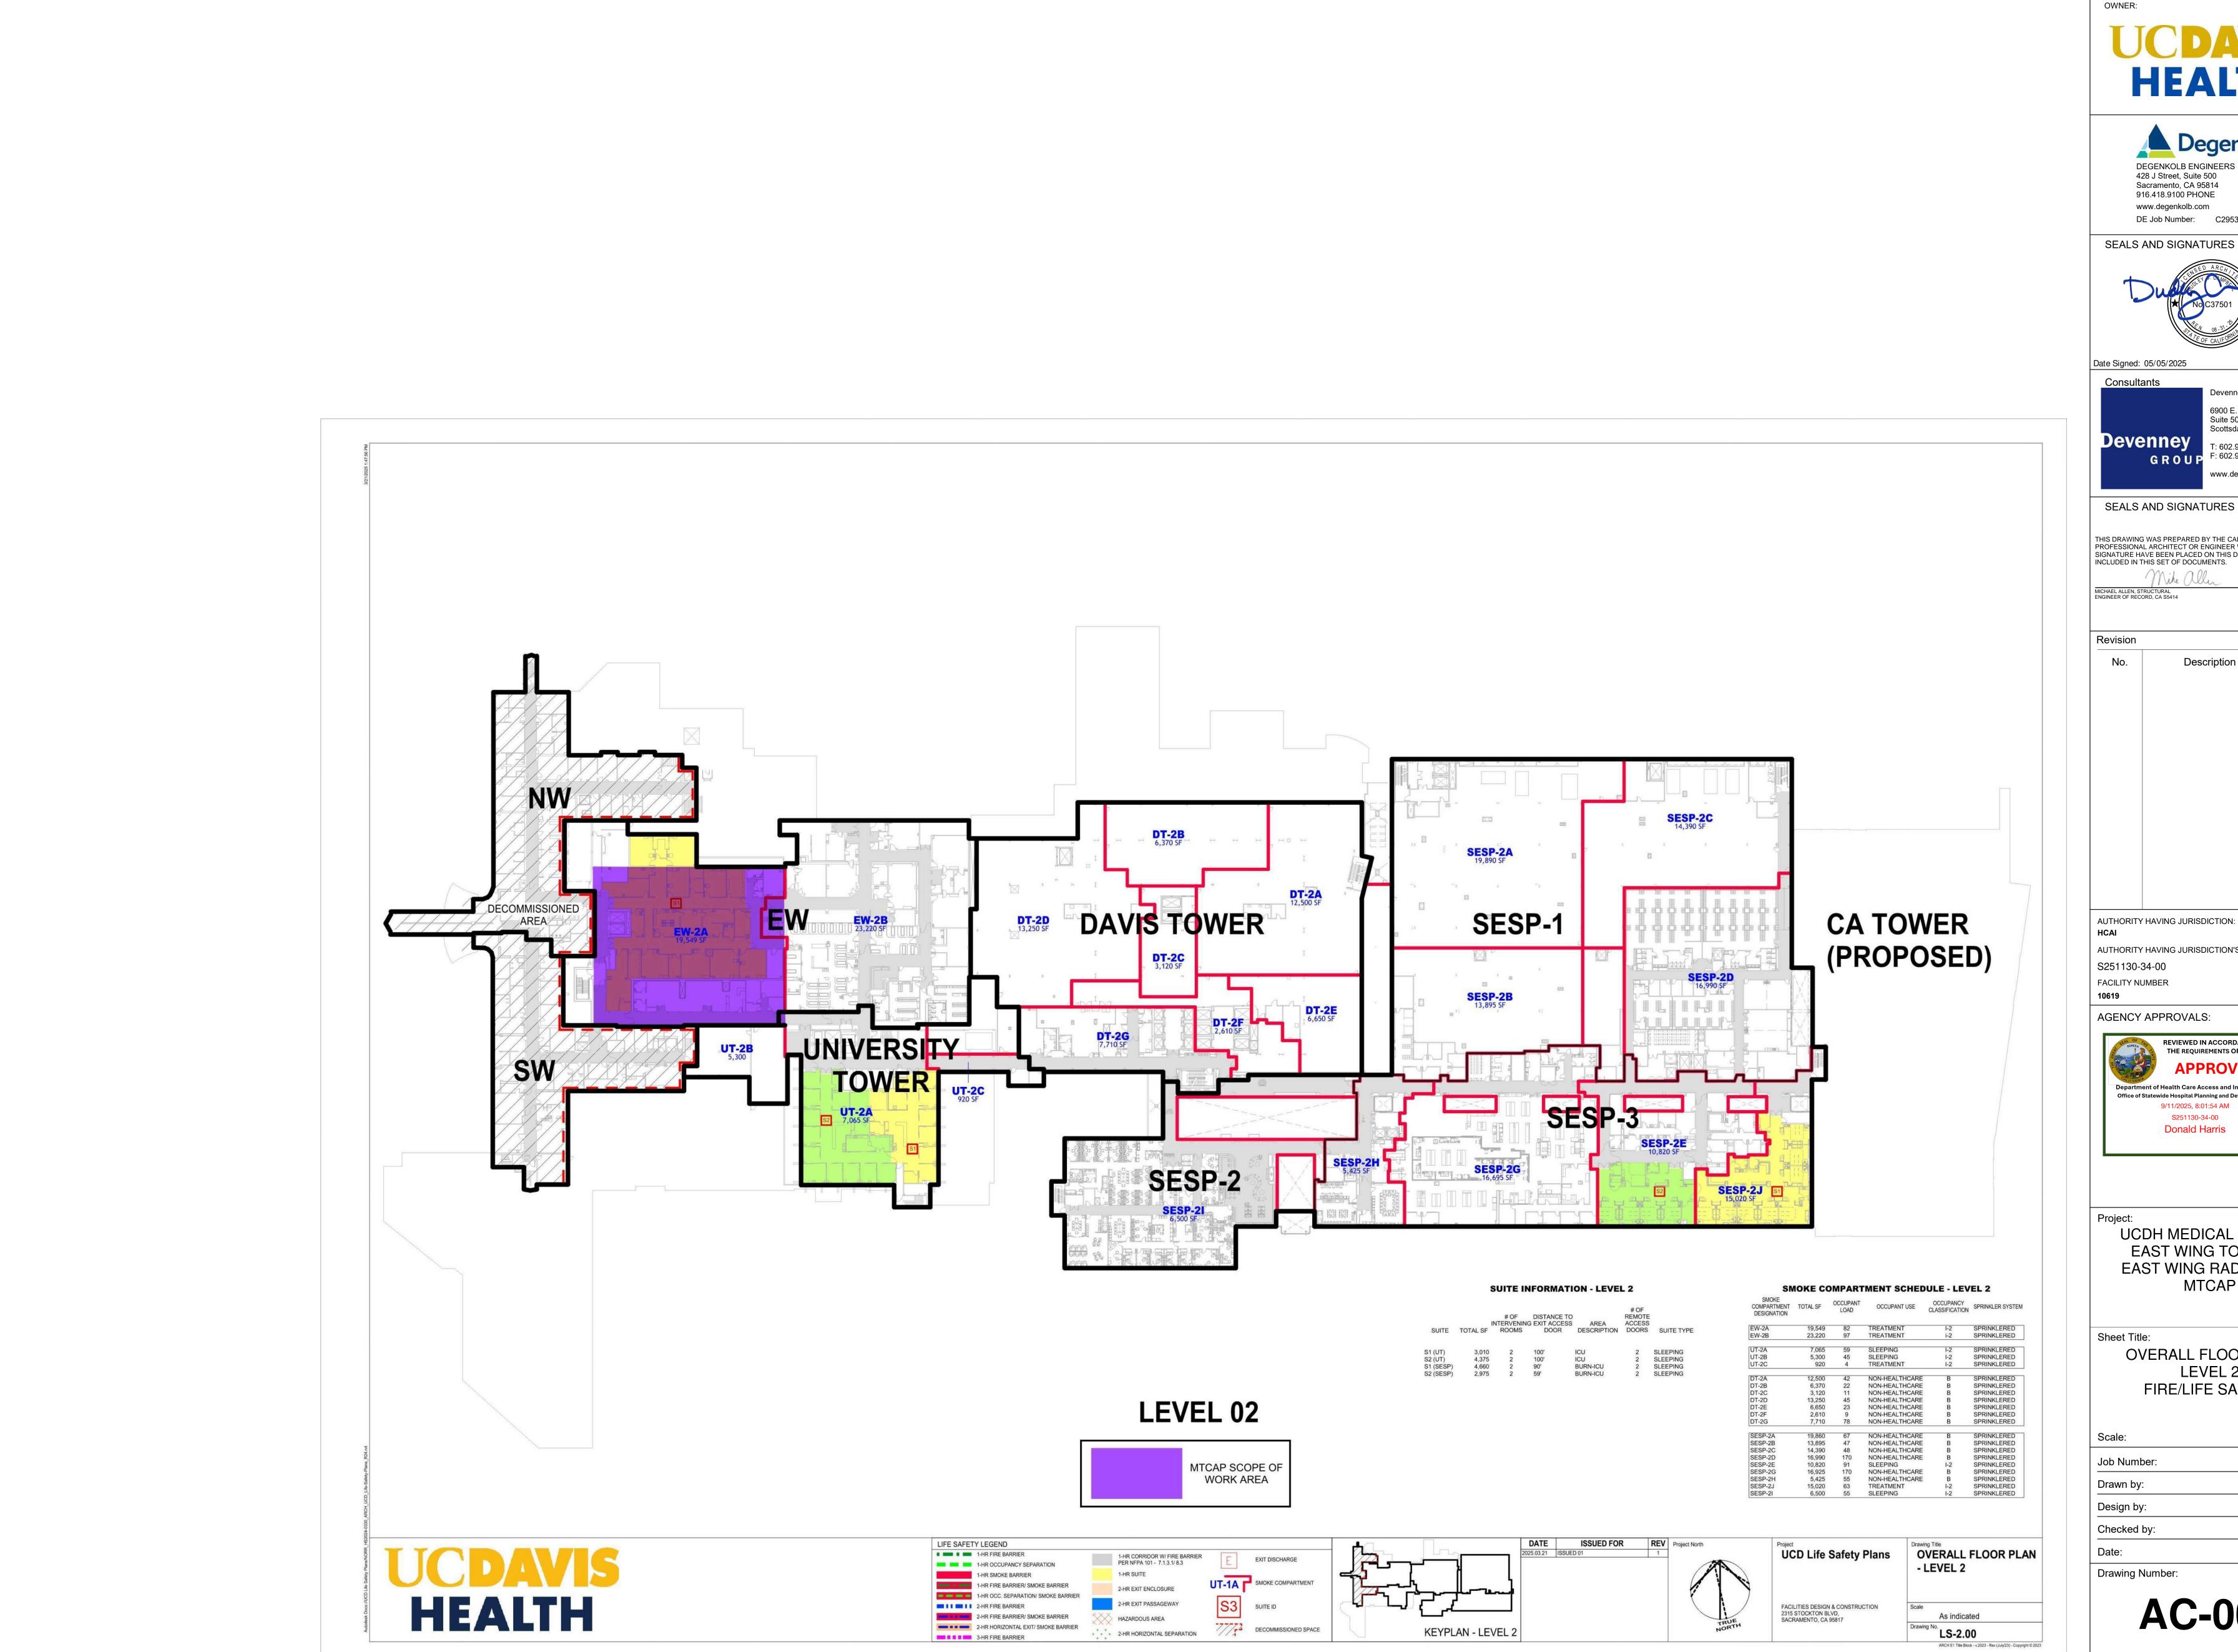one and one-half inches = one foot

three-quarters inch = one foot

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three inches = one foot





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UCDH MEDICAL CENTER EAST WING TOWER & EAST WING RADIOLOGY MTCAP

OVERALL FLOOR PLAN LEVEL 2 FIRE/LIFE SAFETY

9167.25.0001 May 2, 2025

of Sheets

one-quarter inch = one foot

one-eighth inch = one foot

REFER TO GRAPHIC SCALE OWNER: Sacramento, CA 95814 Consultants Revision ______ ^{COR}W-2B FACILITY NUMBER EW-2A Sheet Title: Scale: Drawn by: Design by: LEVEL 2 - EW PLAN SCALE: 3/32" = 1'-0"
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 ISSUED 01
 1
 UCD Life Safety Plans

Drawing Title

LEVEL 2 - EW LIFE SAFETY LEGEND Date: ■ ■ 1-HR FIRE BARRIER 1-HR CORRIDOR W/ FIRE BARRIER PER NFPA 101 - 7.1.3.1/8.3 EXIT DISCHARGE 1-HR OCCUPANCY SEPARATION 1-HR SMOKE BARRIER UT-1A SMOKE COMPARTMENT 1-HR FIRE BARRIER/ SMOKE BARRIER 2-HR EXIT ENCLOSURE 1-HR OCC. SEPARATION/ SMOKE BARRIER HEALTH 2-HR EXIT PASSAGEWAY

2-HR FIRE BARRIER

3-HR FIRE BARRIER

2-HR FIRE BARRIER/ SMOKE BARRIER

2-HR HORIZONTAL EXIT/ SMOKE BARRIER

SUITE ID

2-HR HORIZONTAL SEPARATION

KEYPLAN - LEVEL 2

three-quarters inch = one foot

one inch = one foot


one and one-half inches = one foot

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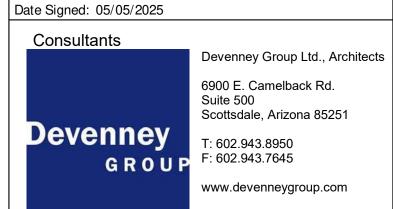




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three inches = one foot

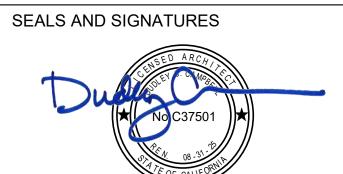

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AGENCY APPROVALS:



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> FLOOR PLAN LEVEL 2 - EW FIRE/LIFE SAFETY

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Drawing Number:

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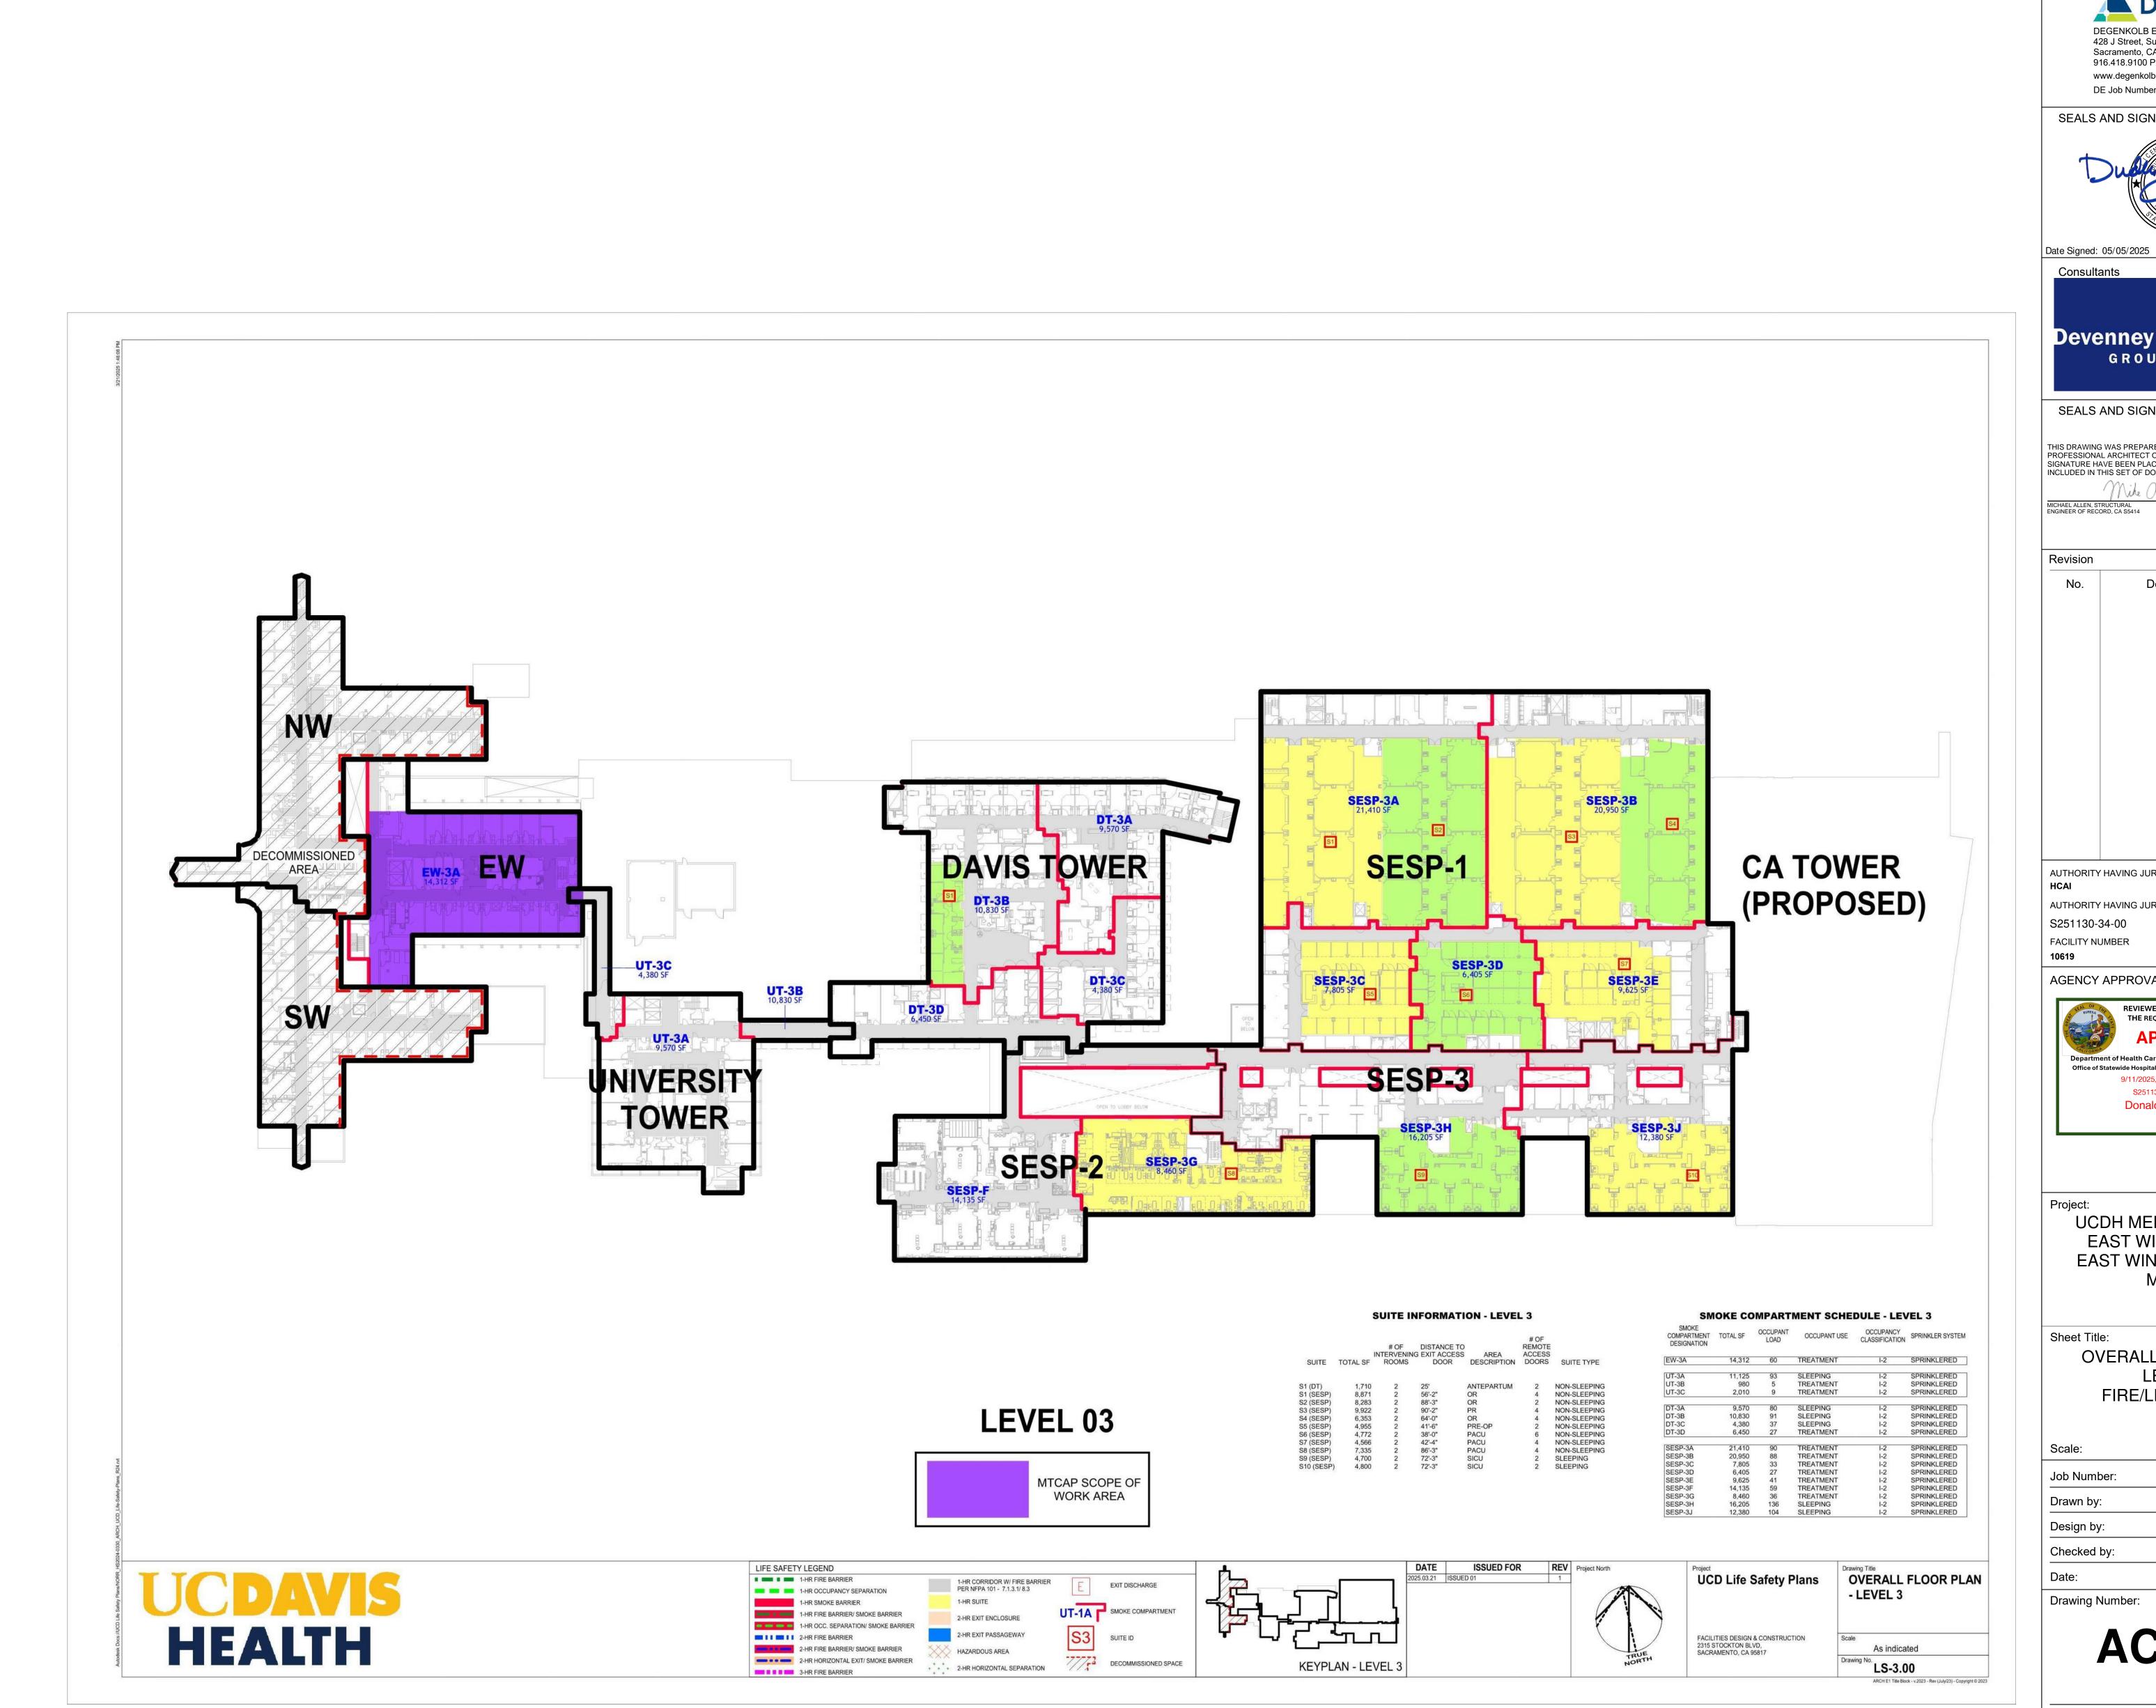
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Drawing No. **LS-2.01**

of Sheets

one-quarter inch = one foot

one-eighth inch = one foot



one inch = one foot

one and one-half inches = one foot

three-quarters inch = one foot

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three inches = one foot



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AGENCY APPROVALS:



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MTCAP

OVERALL FLOOR PLAN LEVEL 3 FIRE/LIFE SAFETY

NTS 9167.25.0001 Job Number: May 2, 2025

Drawing Number:

AC-009

of Sheets

one-quarter inch = one foot

one-eighth inch = one foot

LEVEL 3 - EW PLAN SCALE: 3/32" = 1'-0"
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Drawing Title

LEVEL 3 - EW LIFE SAFETY LEGEND ■ ■ 1-HR FIRE BARRIER 1-HR CORRIDOR W/ FIRE BARRIER PER NFPA 101 - 7.1.3.1/8.3 1-HR OCCUPANCY SEPARATION 1-HR SMOKE BARRIER UT-1A SMOKE COMPARTMENT 1-HR FIRE BARRIER/ SMOKE BARRIER 2-HR EXIT ENCLOSURE 1-HR OCC, SEPARATION/ SMOKE BARRIER HEALTH 2-HR EXIT PASSAGEWAY 2-HR FIRE BARRIER SUITE ID FACILITIES DESIGN & CONSTRUCTION 2315 STOCKTON BLVD, SACRAMENTO, CA 95817 As indicated 2-HR FIRE BARRIER/ SMOKE BARRIER 2-HR HORIZONTAL EXIT/ SMOKE BARRIER

2-HR HORIZONTAL SEPARATION

3-HR FIRE BARRIER

one inch = one foot

three-quarters inch = one foot

one and one-half inches = one foot

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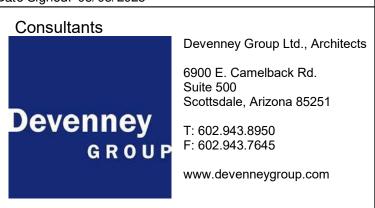
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three inches = one foot



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07/10/2025 MICHAEL ALLEN, STRUCTURAL ENGINEER OF RECORD, CA S5414 DATE

Revision

No.	Description	Date

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AGENCY APPROVALS:



UCDH MEDICAL CENTER EAST WING TOWER & EAST WING RADIOLOGY MTCAP

Sheet Title:

FLOOR PLAN LEVEL 3 - EW FIRE/LIFE SAFETY

NTS Scale: 9167.25.0001 Job Number: Drawn by: Design by: Checked by: May 2, 2025 Date:

Drawing Number:

Drawing No. LS-3.01

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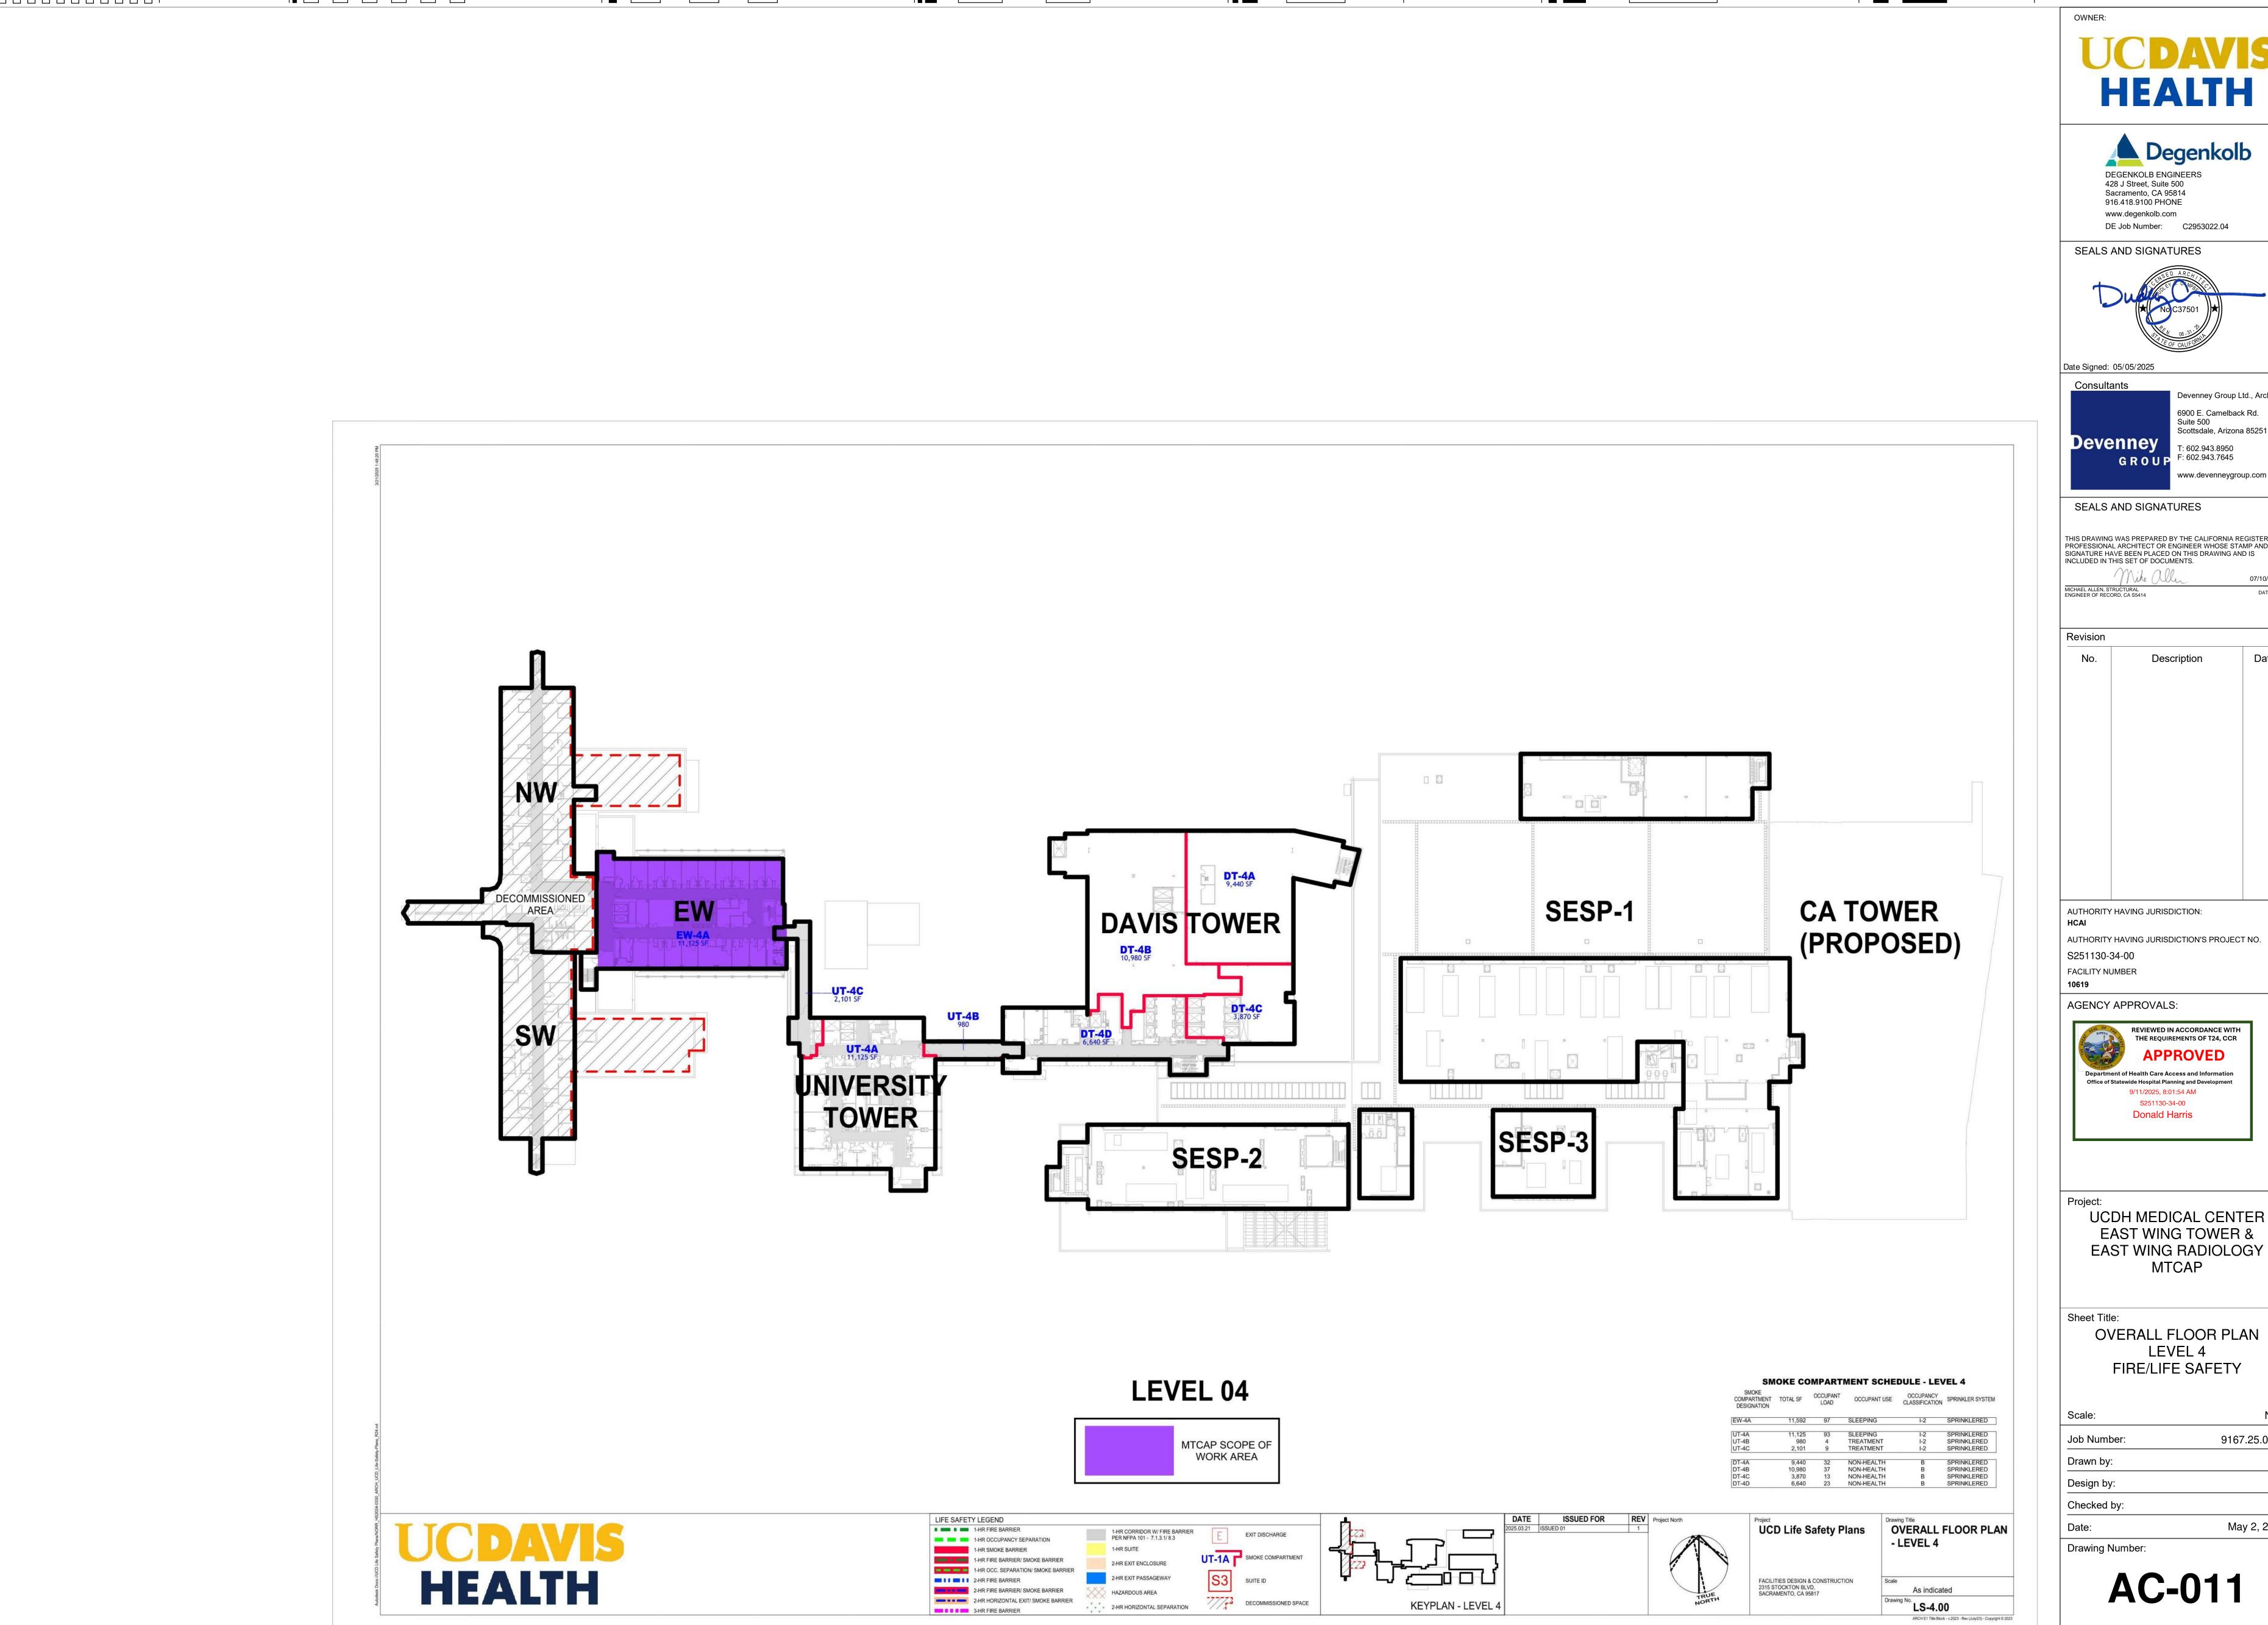
KEYPLAN - LEVEL 3

AC-010

of Sheets

one-quarter inch = one foot

one-eighth inch = one foot



one inch = one foot

one and one-half inches = one foot

three-quarters inch = one foot

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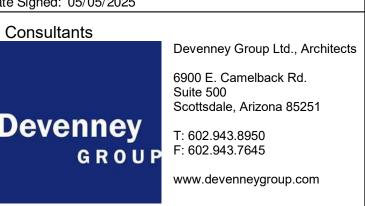
three inches = one foot



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UCDH MEDICAL CENTER

OVERALL FLOOR PLAN

9167.25.0001

AC-011

May 2, 2025

of Sheets

one-quarter inch = one foot

one-eighth inch = one foot

one-quarter inch = one foot one-half inch = one foot one-eighth inch = one foot

three-quarters inch = one foot

one inch = one foot

one and one-half inches = one foot

three inches = one foot

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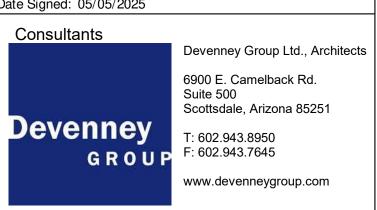


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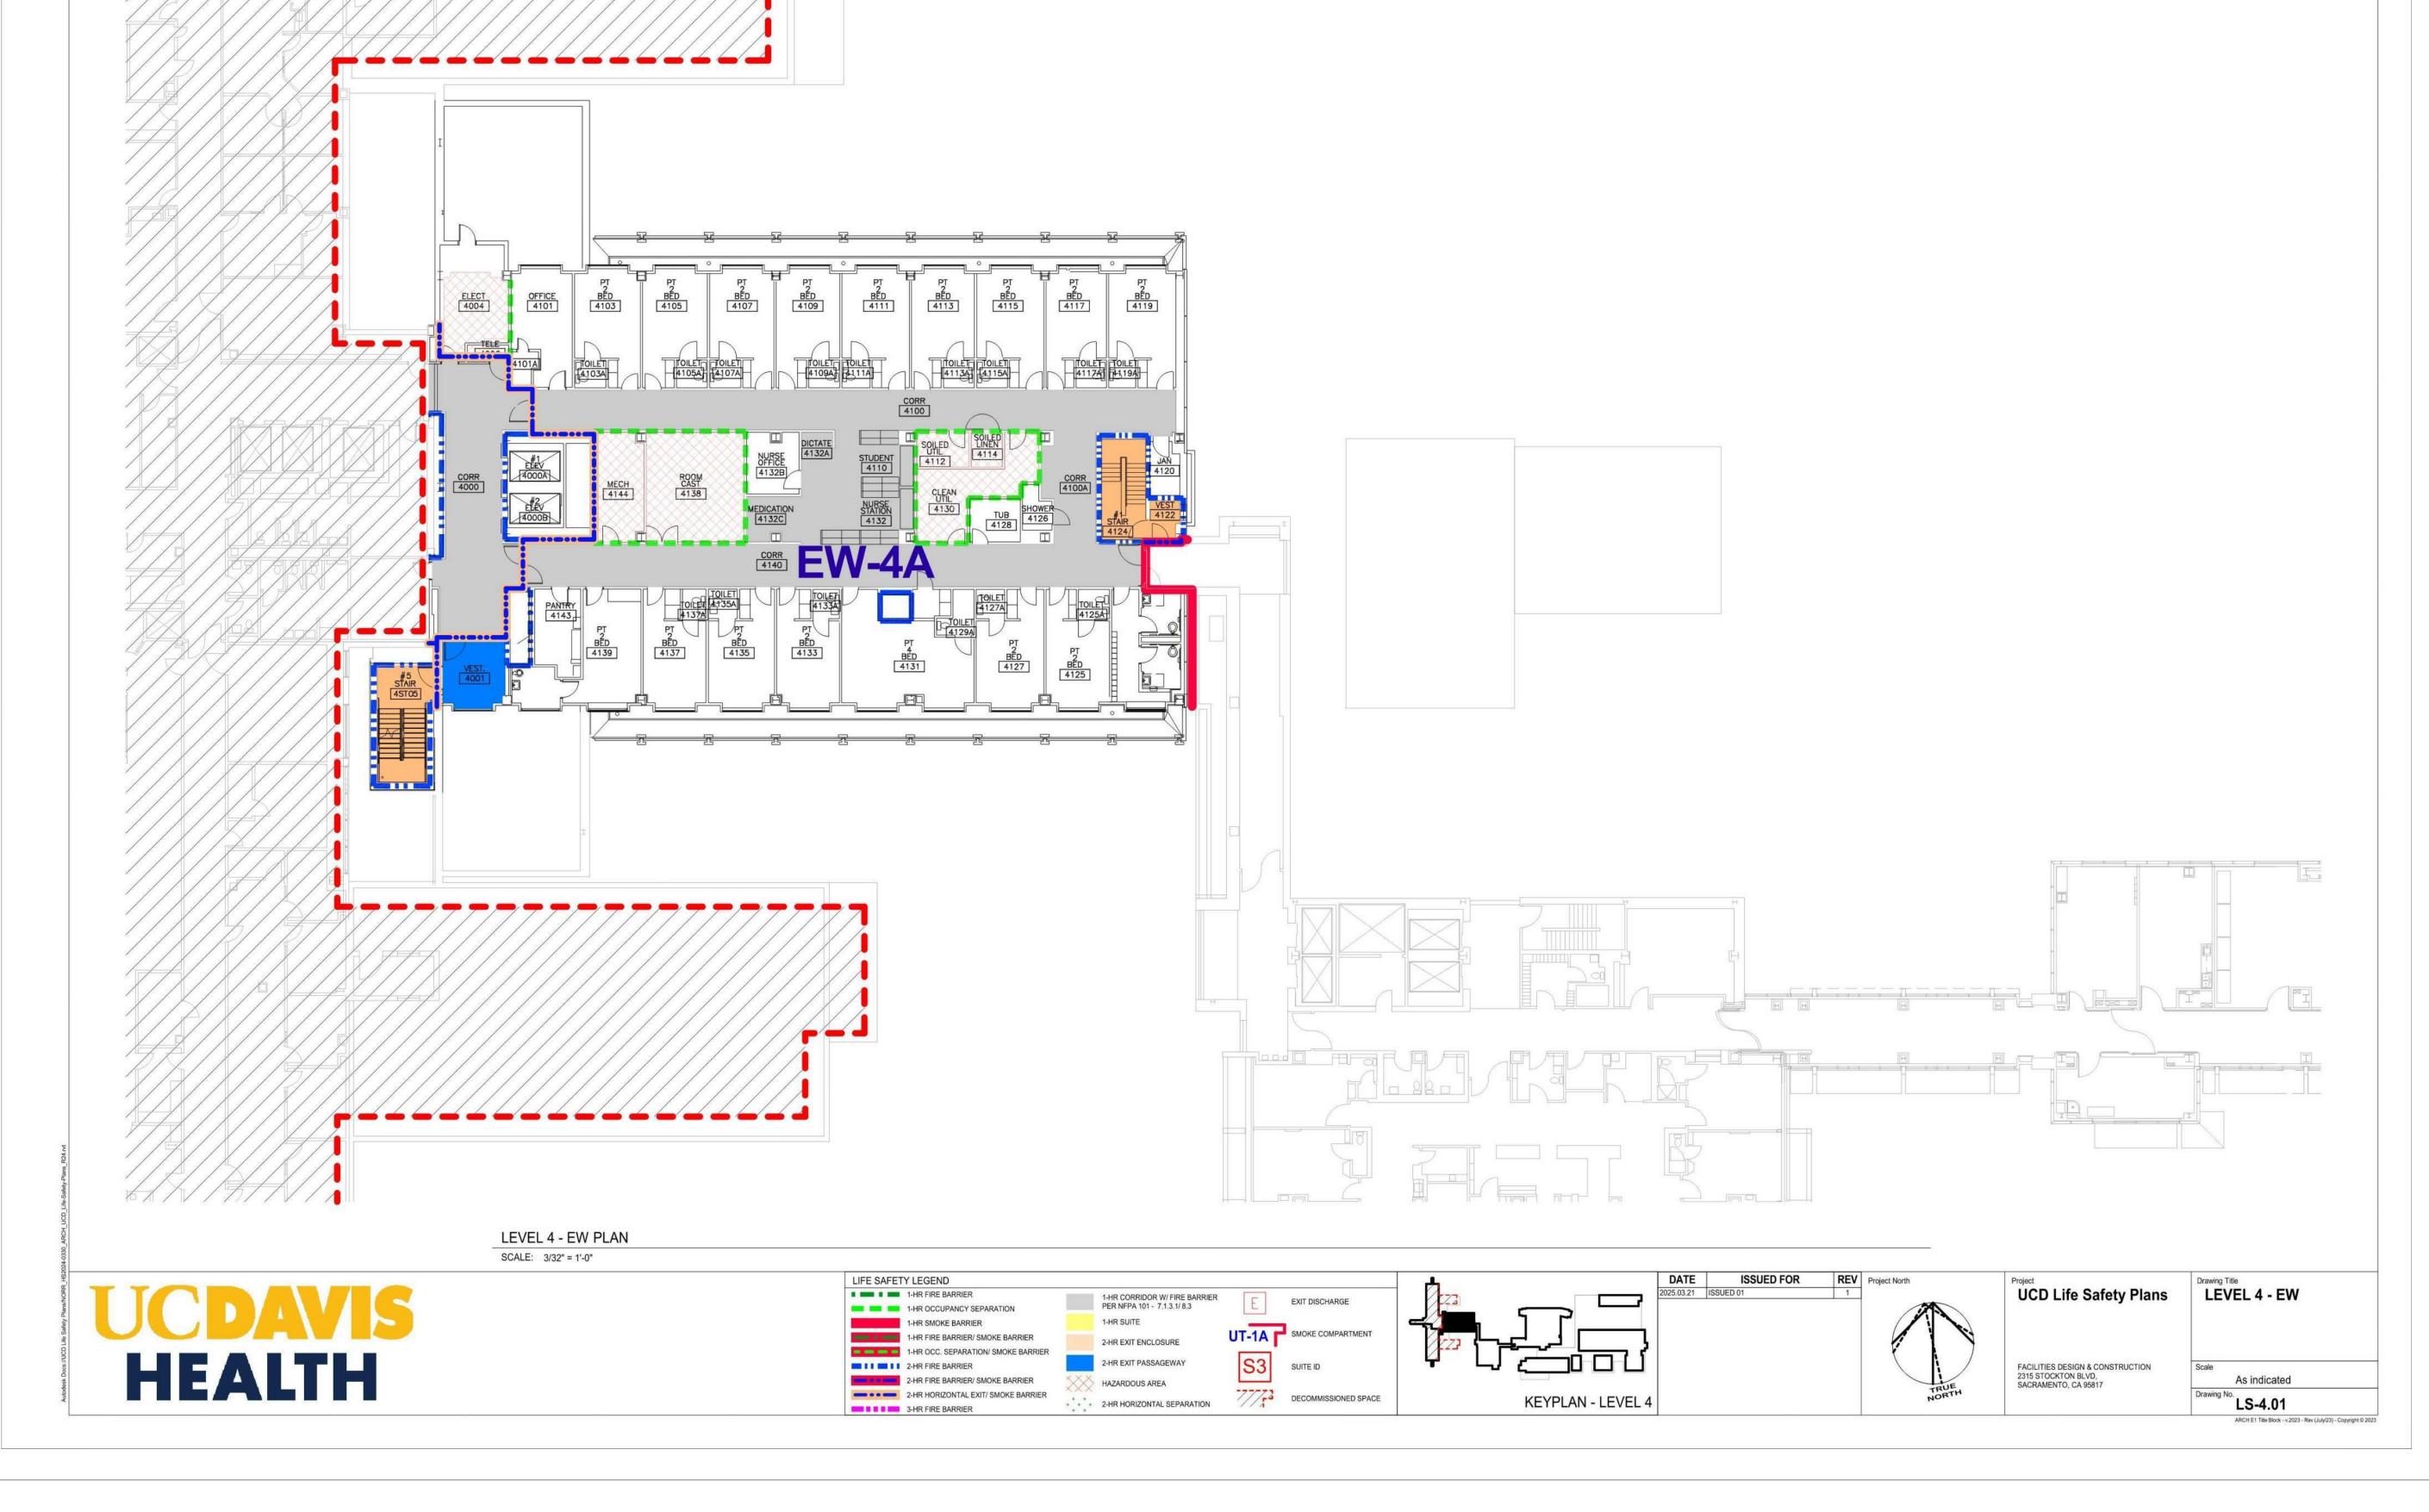
UCDH MEDICAL CENTER EAST WING TOWER & EAST WING RADIOLOGY MTCAP


Sheet Title:

FLOOR PLAN LEVEL 4 - EW FIRE/LIFE SAFETY

NTS Scale: 9167.25.0001 Job Number: Drawn by: Design by: Checked by: May 2, 2025 Date: Drawing Number:

AC-012



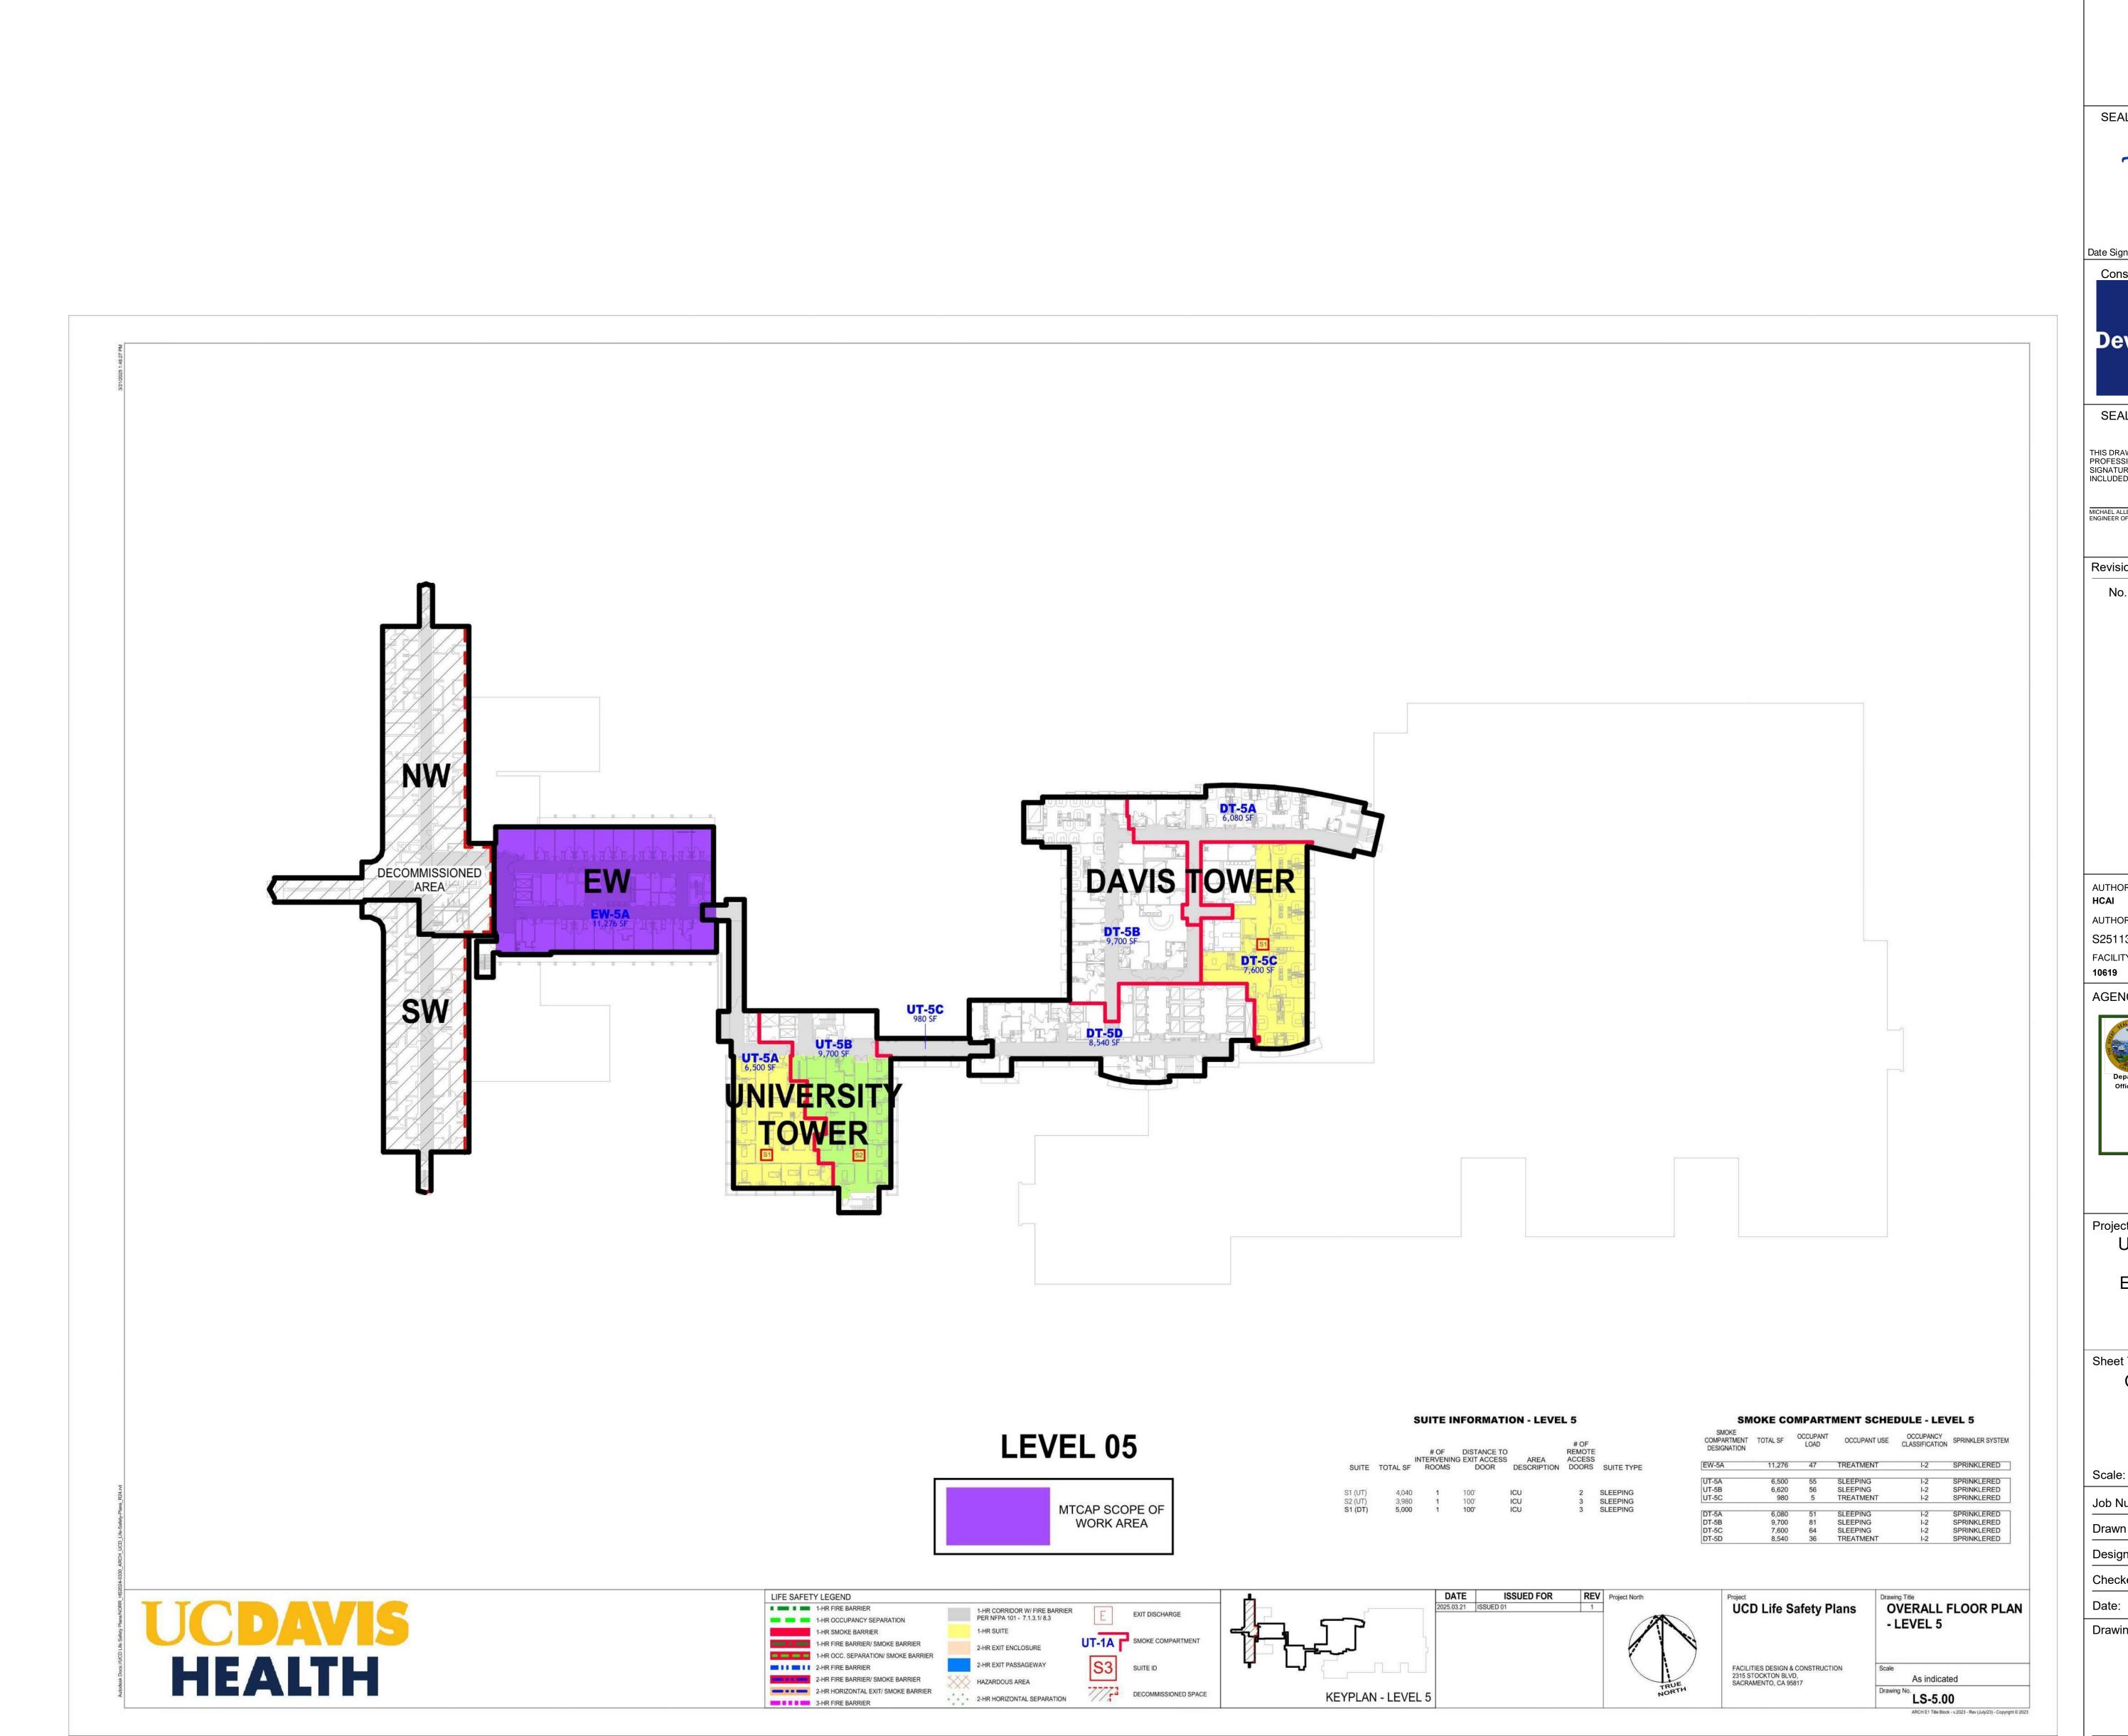

one inch = one foot

one and one-half inches = one foot

three-quarters inch = one foot

one-quarter inch = one foot

one-eighth inch = one foot

one-half inch = one foot

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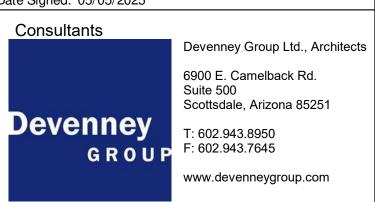
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three inches = one foot



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AUTHORITY HAVING JURISDICTION'S PROJECT NO. S251130-34-00 FACILITY NUMBER

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UCDH MEDICAL CENTER EAST WING TOWER & EAST WING RADIOLOGY MTCAP

Sheet Title: OVERALL FLOOR PLAN LEVEL 5

NTS Scale: 9167.25.0001 Job Number: Drawn by: Design by: Checked by:

FIRE/LIFE SAFETY

Drawing Number:

AC-013

May 2, 2025

of Sheets

one inch = one foot one-quarter inch = one foot one-eighth inch = one foot one-half inch = one foot three-quarters inch = one foot

> LEVEL 5 - EW PLAN SCALE: 3/32" = 1'-0"
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> 2025.03.21
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> UCD Life Safety Plans Drawing Title
> LEVEL 5 - EW LIFE SAFETY LEGEND ■ ■ 1-HR FIRE BARRIER 1-HR CORRIDOR W/ FIRE BARRIER PER NFPA 101 - 7.1.3.1/8.3 1-HR OCCUPANCY SEPARATION 1-HR SMOKE BARRIER UT-1A SMOKE COMPARTMENT 1-HR FIRE BARRIER/ SMOKE BARRIER 2-HR EXIT ENCLOSURE 1-HR OCC. SEPARATION/ SMOKE BARRIER HEALTH 2-HR EXIT PASSAGEWAY 2-HR FIRE BARRIER FACILITIES DESIGN & CONSTRUCTION 2315 STOCKTON BLVD, SACRAMENTO, CA 95817 SUITE ID As indicated 2-HR FIRE BARRIER/ SMOKE BARRIER 2-HR HORIZONTAL EXIT/ SMOKE BARRIER Drawing No. LS-5.01 KEYPLAN - LEVEL 5 2-HR HORIZONTAL SEPARATION 3-HR FIRE BARRIER ARCH E1 Title Block - v.2023 - Rev (July/23) - Copyright © 2023

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three inches = one foot

one and one-half inches = one foot



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07/10/2025 MICHAEL ALLEN, STRUCTURAL ENGINEER OF RECORD, CA S5414 DATE

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AUTHORITY HAVING JURISDICTION'S PROJECT NO. S251130-34-00 FACILITY NUMBER

AGENCY APPROVALS:



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Sheet Title:

FLOOR PLAN LEVEL 5 - EW FIRE/LIFE SAFETY

NTS Scale: 9167.25.0001 Job Number: Drawn by: Design by: Checked by: May 2, 2025 Date:

Drawing Number:

AC-014

OWNER: www.degenkolb.com Revision DAVIS TOWER EW FACILITY NUMBER SW Sheet Title: **SUITE INFORMATION - LEVEL 6** LEVEL 06 # OF DISTANCE TO REMOTE
INTERVENING EXIT ACCESS AREA ACCESS
SUITE TOTAL SF ROOMS DOOR DESCRIPTION DOORS SUITE TYPE Scale: UT-6A UT-6B UT-6C UT-6D 6,650 56 4,490 38 1,960 9 1,020 5 SLEEPING SLEEPING TREATMENT TREATMENT SPRINKLERED SPRINKLERED SPRINKLERED SPRINKLERED MTCAP SCOPE OF WORK AREA 5,700 48 12,200 102 7,250 61 7,000 30 DT-6A DT-6B DT-6C DT-6D SLEEPING SLEEPING SLEEPING TREATMENT SPRINKLERED SPRINKLERED SPRINKLERED SPRINKLERED
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2-HR FIRE BARRIER

3-HR FIRE BARRIER

2-HR FIRE BARRIER/ SMOKE BARRIER

2-HR HORIZONTAL EXIT/ SMOKE BARRIER

SUITE ID

DECOMMISSIONED SPACE

2-HR HORIZONTAL SEPARATION

KEYPLAN - LEVEL 6

three-quarters inch = one foot

one inch = one foot

one and one-half inches = one foot

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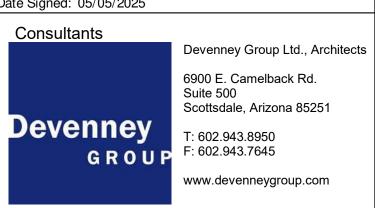
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three inches = one foot



SEALS AND SIGNATURES

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AUTHORITY HAVING JURISDICTION'S PROJECT NO. S251130-34-00

AGENCY APPROVALS:



UCDH MEDICAL CENTER EAST WING TOWER & EAST WING RADIOLOGY MTCAP

OVERALL FLOOR PLAN LEVEL 6 FIRE/LIFE SAFETY

NTS 9167.25.0001 Job Number: Drawn by: Design by: Checked by: May 2, 2025

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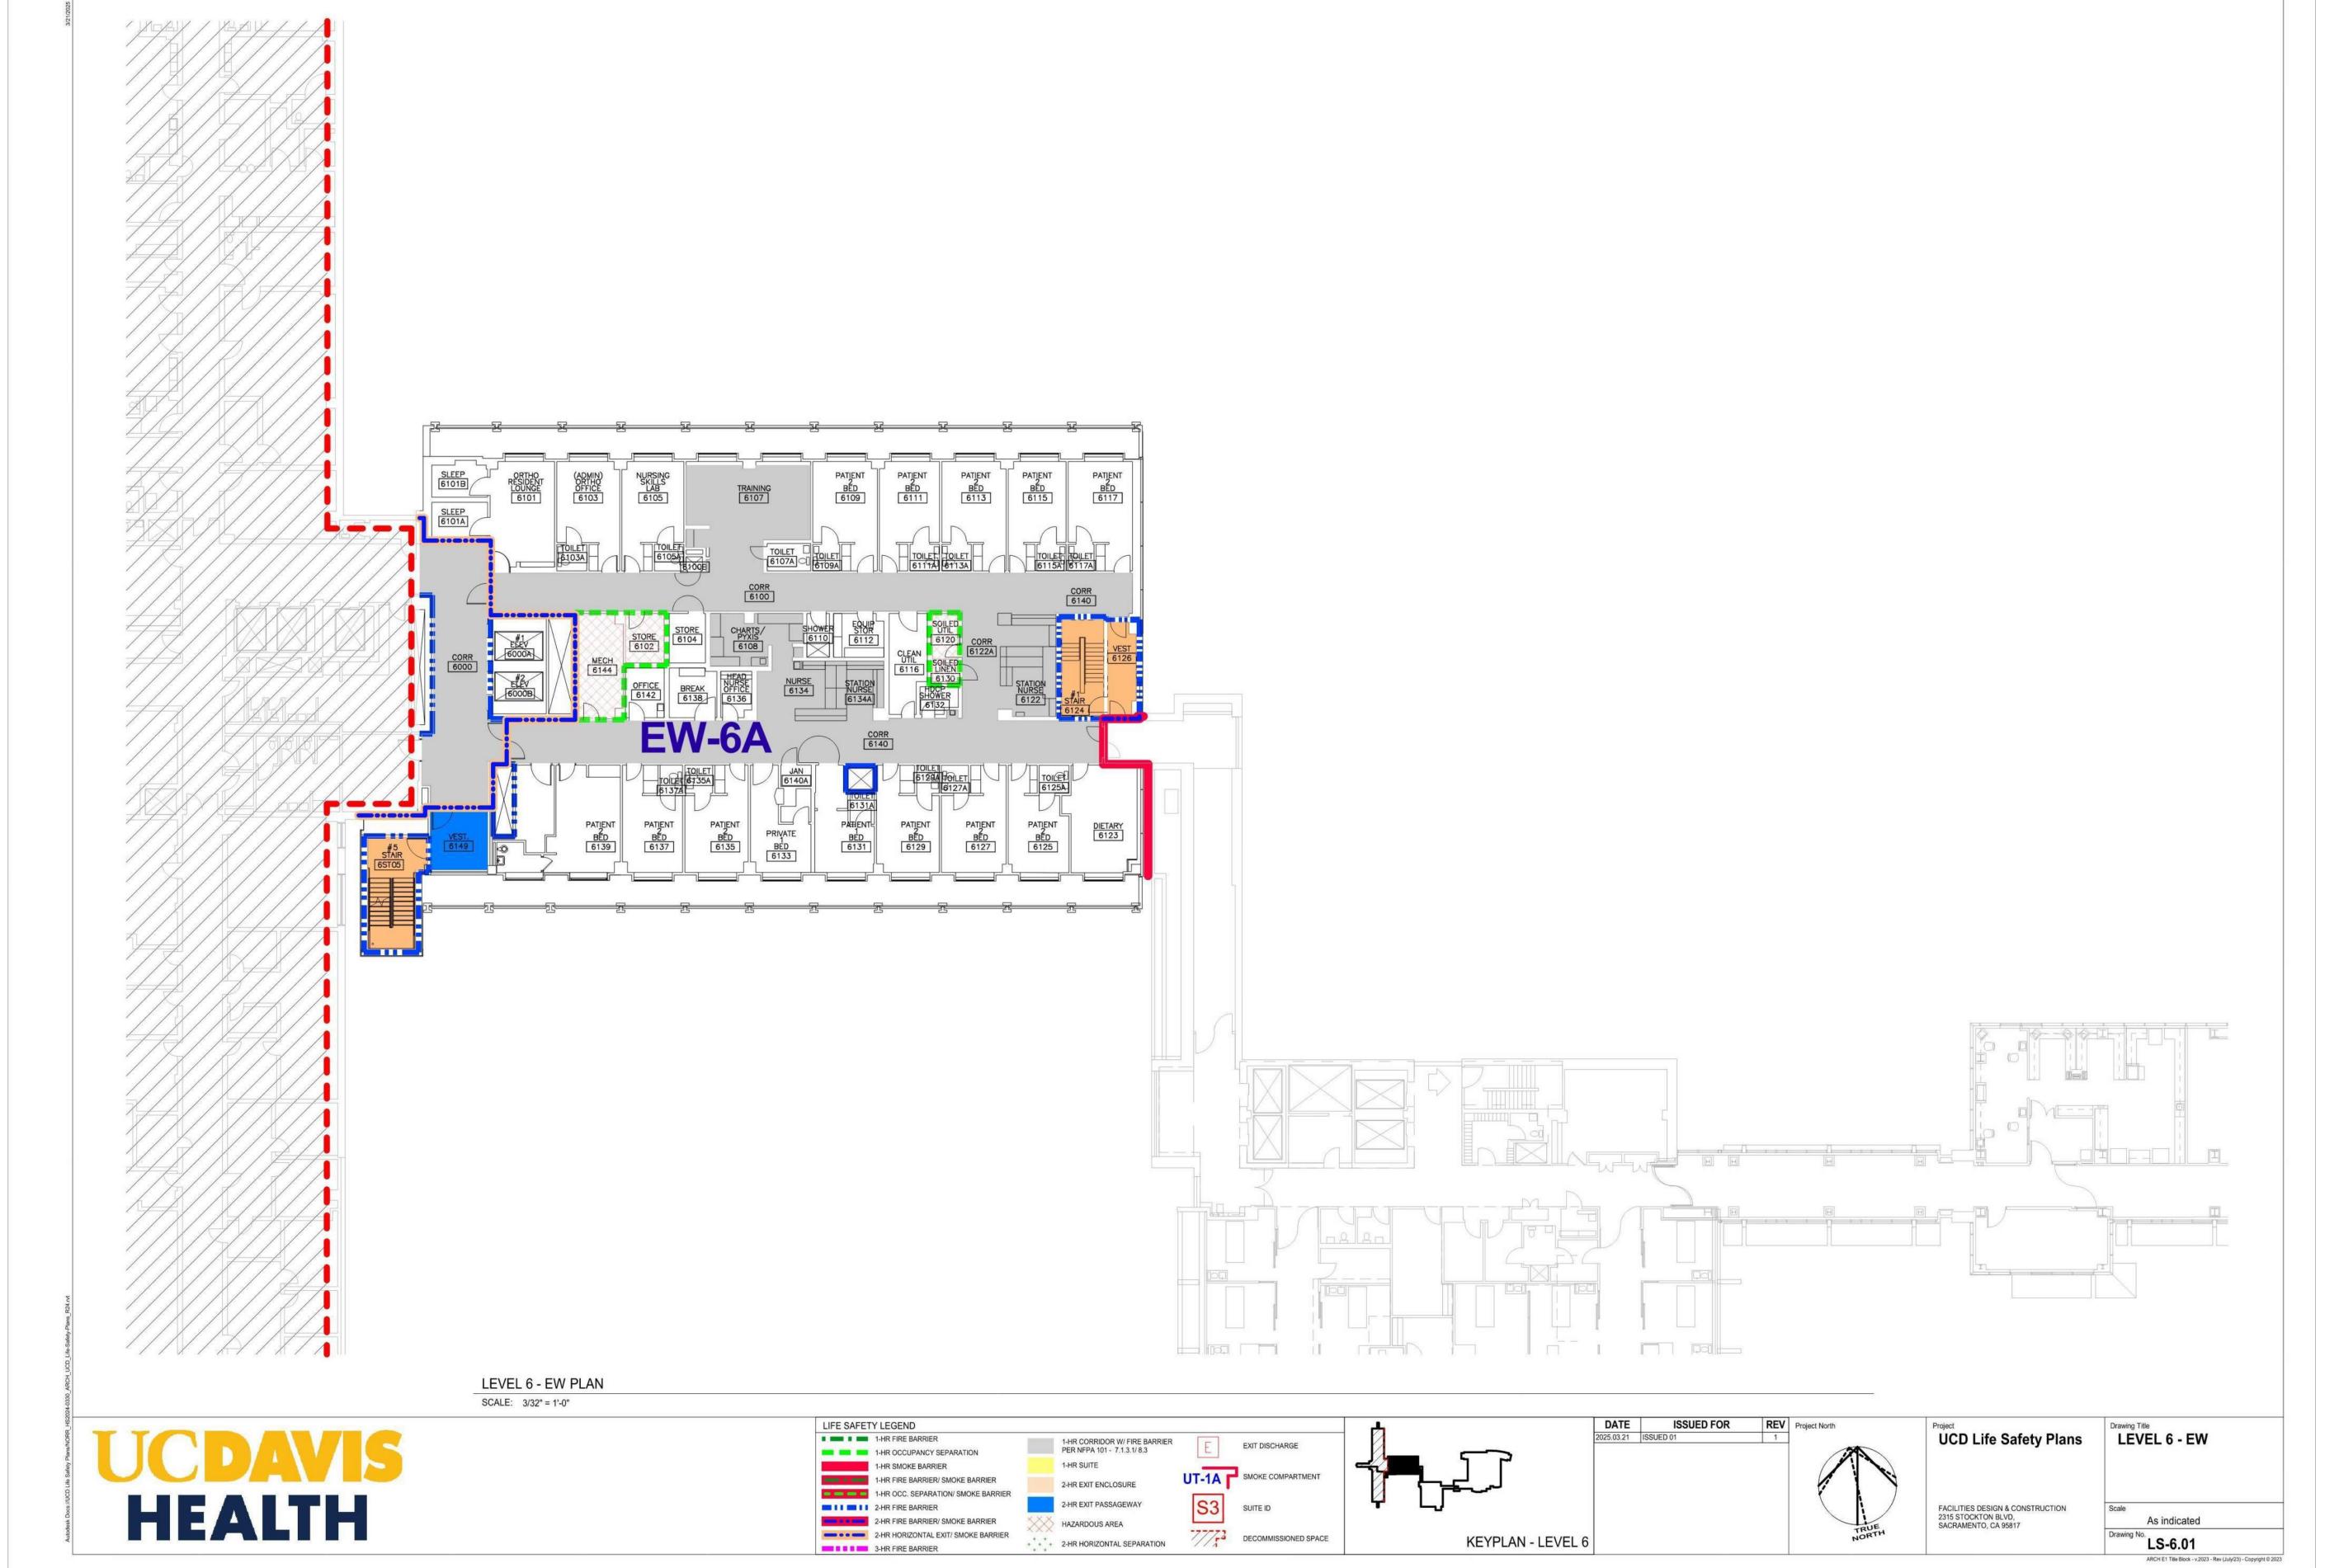
Drawing No. **LS-6.00**

AC-015

one-quarter inch = one foot

one-eighth inch = one foot

one inch = one foot one-quarter inch = one foot one and one-half inches = one foot one-half inch = one foot three-quarters inch = one foot three inches = one foot one-eighth inch = one foot OWNER:




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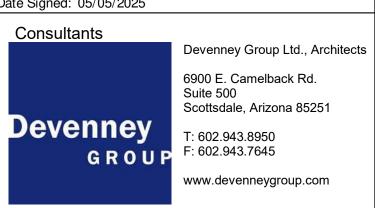


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Revision

AUTHORITY HAVING JURISDICTION:

AUTHORITY HAVING JURISDICTION'S PROJECT NO. S251130-34-00 FACILITY NUMBER

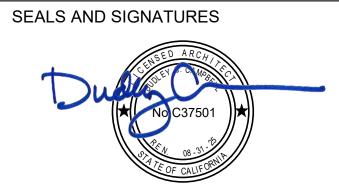AGENCY APPROVALS:



UCDH MEDICAL CENTER EAST WING TOWER & EAST WING RADIOLOGY MTCAP

Sheet Title:

FLOOR PLAN LEVEL 6 - EW FIRE/LIFE SAFETY

NTS Scale: 9167.25.0001 Job Number: Drawn by: Design by: Checked by: May 2, 2025 Date:

Drawing Number:

AC-016

of Sheets

Revision DAVIS TOWER EW EAST WING RADIOLOGY **SUITE INFORMATION - LEVEL 7** FIRE/LIFE SAFETY LEVEL 07 SPRINKLERED SPRINKLERED SPRINKLERED SPRINKLERED 7,545 63 3,740 32 1,960 9 1,650 7 SLEEPING SLEEPING TREATMENT TREATMENT Scale: 4,240 2 100' 5,835 2 100' 3,585 2 100' 3,740 2 100' HEALTHCARE HEALTHCARE HEALTHCARE HEALTHCARE SLEEPING SLEEPING SLEEPING SLEEPING MTCAP SCOPE OF DT-7A DT-7B DT-7C DT-7D 5,700 48 12,200 102 7,250 61 7,040 30 SPRINKLERED WORK AREA SLEEPING SLEEPING TREATMENT SPRINKLERED SPRINKLERED SPRINKLERED
 DATE
 ISSUED FOR
 REV
 Project North

 2025.03.21
 ISSUED 01
 1
 OVERALL FLOOR PLAN
- LEVEL 7 LIFE SAFETY LEGEND UCD Life Safety Plans Date: ■ ■ ■ 1-HR FIRE BARRIER 1-HR CORRIDOR W/ FIRE BARRIER PER NFPA 101 - 7.1.3.1/ 8.3 EXIT DISCHARGE 1-HR OCCUPANCY SEPARATION Drawing Number: 1-HR SMOKE BARRIER UT-1A SMOKE COMPARTMENT 1-HR FIRE BARRIER/ SMOKE BARRIER 2-HR EXIT ENCLOSURE HEALTH 1-HR OCC. SEPARATION/ SMOKE BARRIER 2-HR EXIT PASSAGEWAY 2-HR FIRE BARRIER FACILITIES DESIGN & CONSTRUCTION 2315 STOCKTON BLVD, SACRAMENTO, CA 95817 SUITE ID As indicated 2-HR FIRE BARRIER/ SMOKE BARRIER DECOMMISSIONED SPACE Drawing No. LS-7.00 2-HR HORIZONTAL EXIT/ SMOKE BARRIER **KEYPLAN - LEVEL 7**

2-HR HORIZONTAL SEPARATION

3-HR FIRE BARRIER

three-quarters inch = one foot

one inch = one foot

one and one-half inches = one foot

IF THIS DRAWING IS NOT 30inx42in IT IS A REDUCED REFER TO GRAPHIC SCALE

OWNER:






916.418.9100 PHONE www.degenkolb.com DE Job Number: C2953022.04



Date Signed: 05/05/2025

three inches = one foot

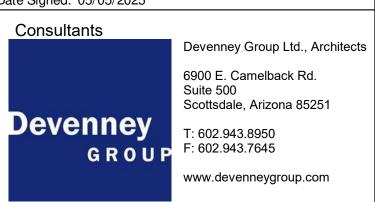

SEALS AND SIGNATURES

THIS DRAWING WAS PREPARED BY THE CALIFORNIA REGISTERED PROFESSIONAL ARCHITECT OR ENGINEER WHOSE STAMP AND SIGNATURE HAVE BEEN PLACED ON THIS DRAWING AND IS INCLUDED IN THIS SET OF DOCUMENTS.

07/10/2025 MICHAEL ALLEN, STRUCTURAL ENGINEER OF RECORD, CA S5414 DATE

Date Description

AUTHORITY HAVING JURISDICTION:

AUTHORITY HAVING JURISDICTION'S PROJECT NO. S251130-34-00 FACILITY NUMBER

AGENCY APPROVALS:



UCDH MEDICAL CENTER EAST WING TOWER &

MTCAP

Sheet Title: OVERALL FLOOR PLAN LEVEL 7

NTS 9167.25.0001 Job Number: Drawn by: Design by: Checked by: May 2, 2025

AC-017

ARCH E1 Title Block - v.2023 - Rev (July/23) - Copyright © 2023

of Sheets

one-quarter inch = one foot

one-eighth inch = one foot

LEVEL 7 - EW PLAN SCALE: 3/32" = 1'-0"
 DATE
 ISSUED FOR
 REV
 Project North

 2025.03.21
 ISSUED 01
 1
 UCD Life Safety Plans

Drawing Title

LEVEL 7 - EW LIFE SAFETY LEGEND ■ ■ 1-HR FIRE BARRIER 1-HR CORRIDOR W/ FIRE BARRIER PER NFPA 101 - 7.1.3.1/ 8.3 1-HR OCCUPANCY SEPARATION 1-HR SMOKE BARRIER UT-1A SMOKE COMPARTMENT 1-HR FIRE BARRIER/ SMOKE BARRIER 2-HR EXIT ENCLOSURE HEALTH 1-HR OCC. SEPARATION/ SMOKE BARRIER 2-HR EXIT PASSAGEWAY 2-HR FIRE BARRIER FACILITIES DESIGN & CONSTRUCTION 2315 STOCKTON BLVD, SACRAMENTO, CA 95817 As indicated 2-HR FIRE BARRIER/ SMOKE BARRIER Drawing No. LS-7.01 2-HR HORIZONTAL EXIT/ SMOKE BARRIER **KEYPLAN - LEVEL 7** 2-HR HORIZONTAL SEPARATION 3-HR FIRE BARRIER ARCH E1 Title Block - v.2023 - Rev (July/23) - Copyright © 2023

one inch = one foot

three-quarters inch = one foot

one and one-half inches = one foot

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UCDAVIS





Sacramento, CA 95814
916.418.9100 PHONE
www.degenkolb.com
DE Job Number: C2953022.04

EALS AND SIGNATURES



Date Signed: 05/05/2025

three inches = one foot



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MICHAEL ALLEN, STRUCTURAL ENGINEER OF RECORD, CA S5414

DATE

No. Description Date

AUTHORITY HAVING JURISDICTION:

AUTHORITY HAVING JURISDICTION'S PROJECT NO. S251130-34-00 FACILITY NUMBER

AGENCY APPROVALS:



Project:

UCDH MEDICAL CENTER EAST WING TOWER & EAST WING RADIOLOGY MTCAP

Sheet Title:

FLOOR PLAN LEVEL 7 - EW FIRE/LIFE SAFETY

Scale: NTS

Job Number: 9167.25.0001

Drawn by:

Design by:

Checked by:

Date: May 2, 2025


Drawing Number:

AC-018

of Sheets

one-eighth inch = one foot

one-quarter inch = one foot

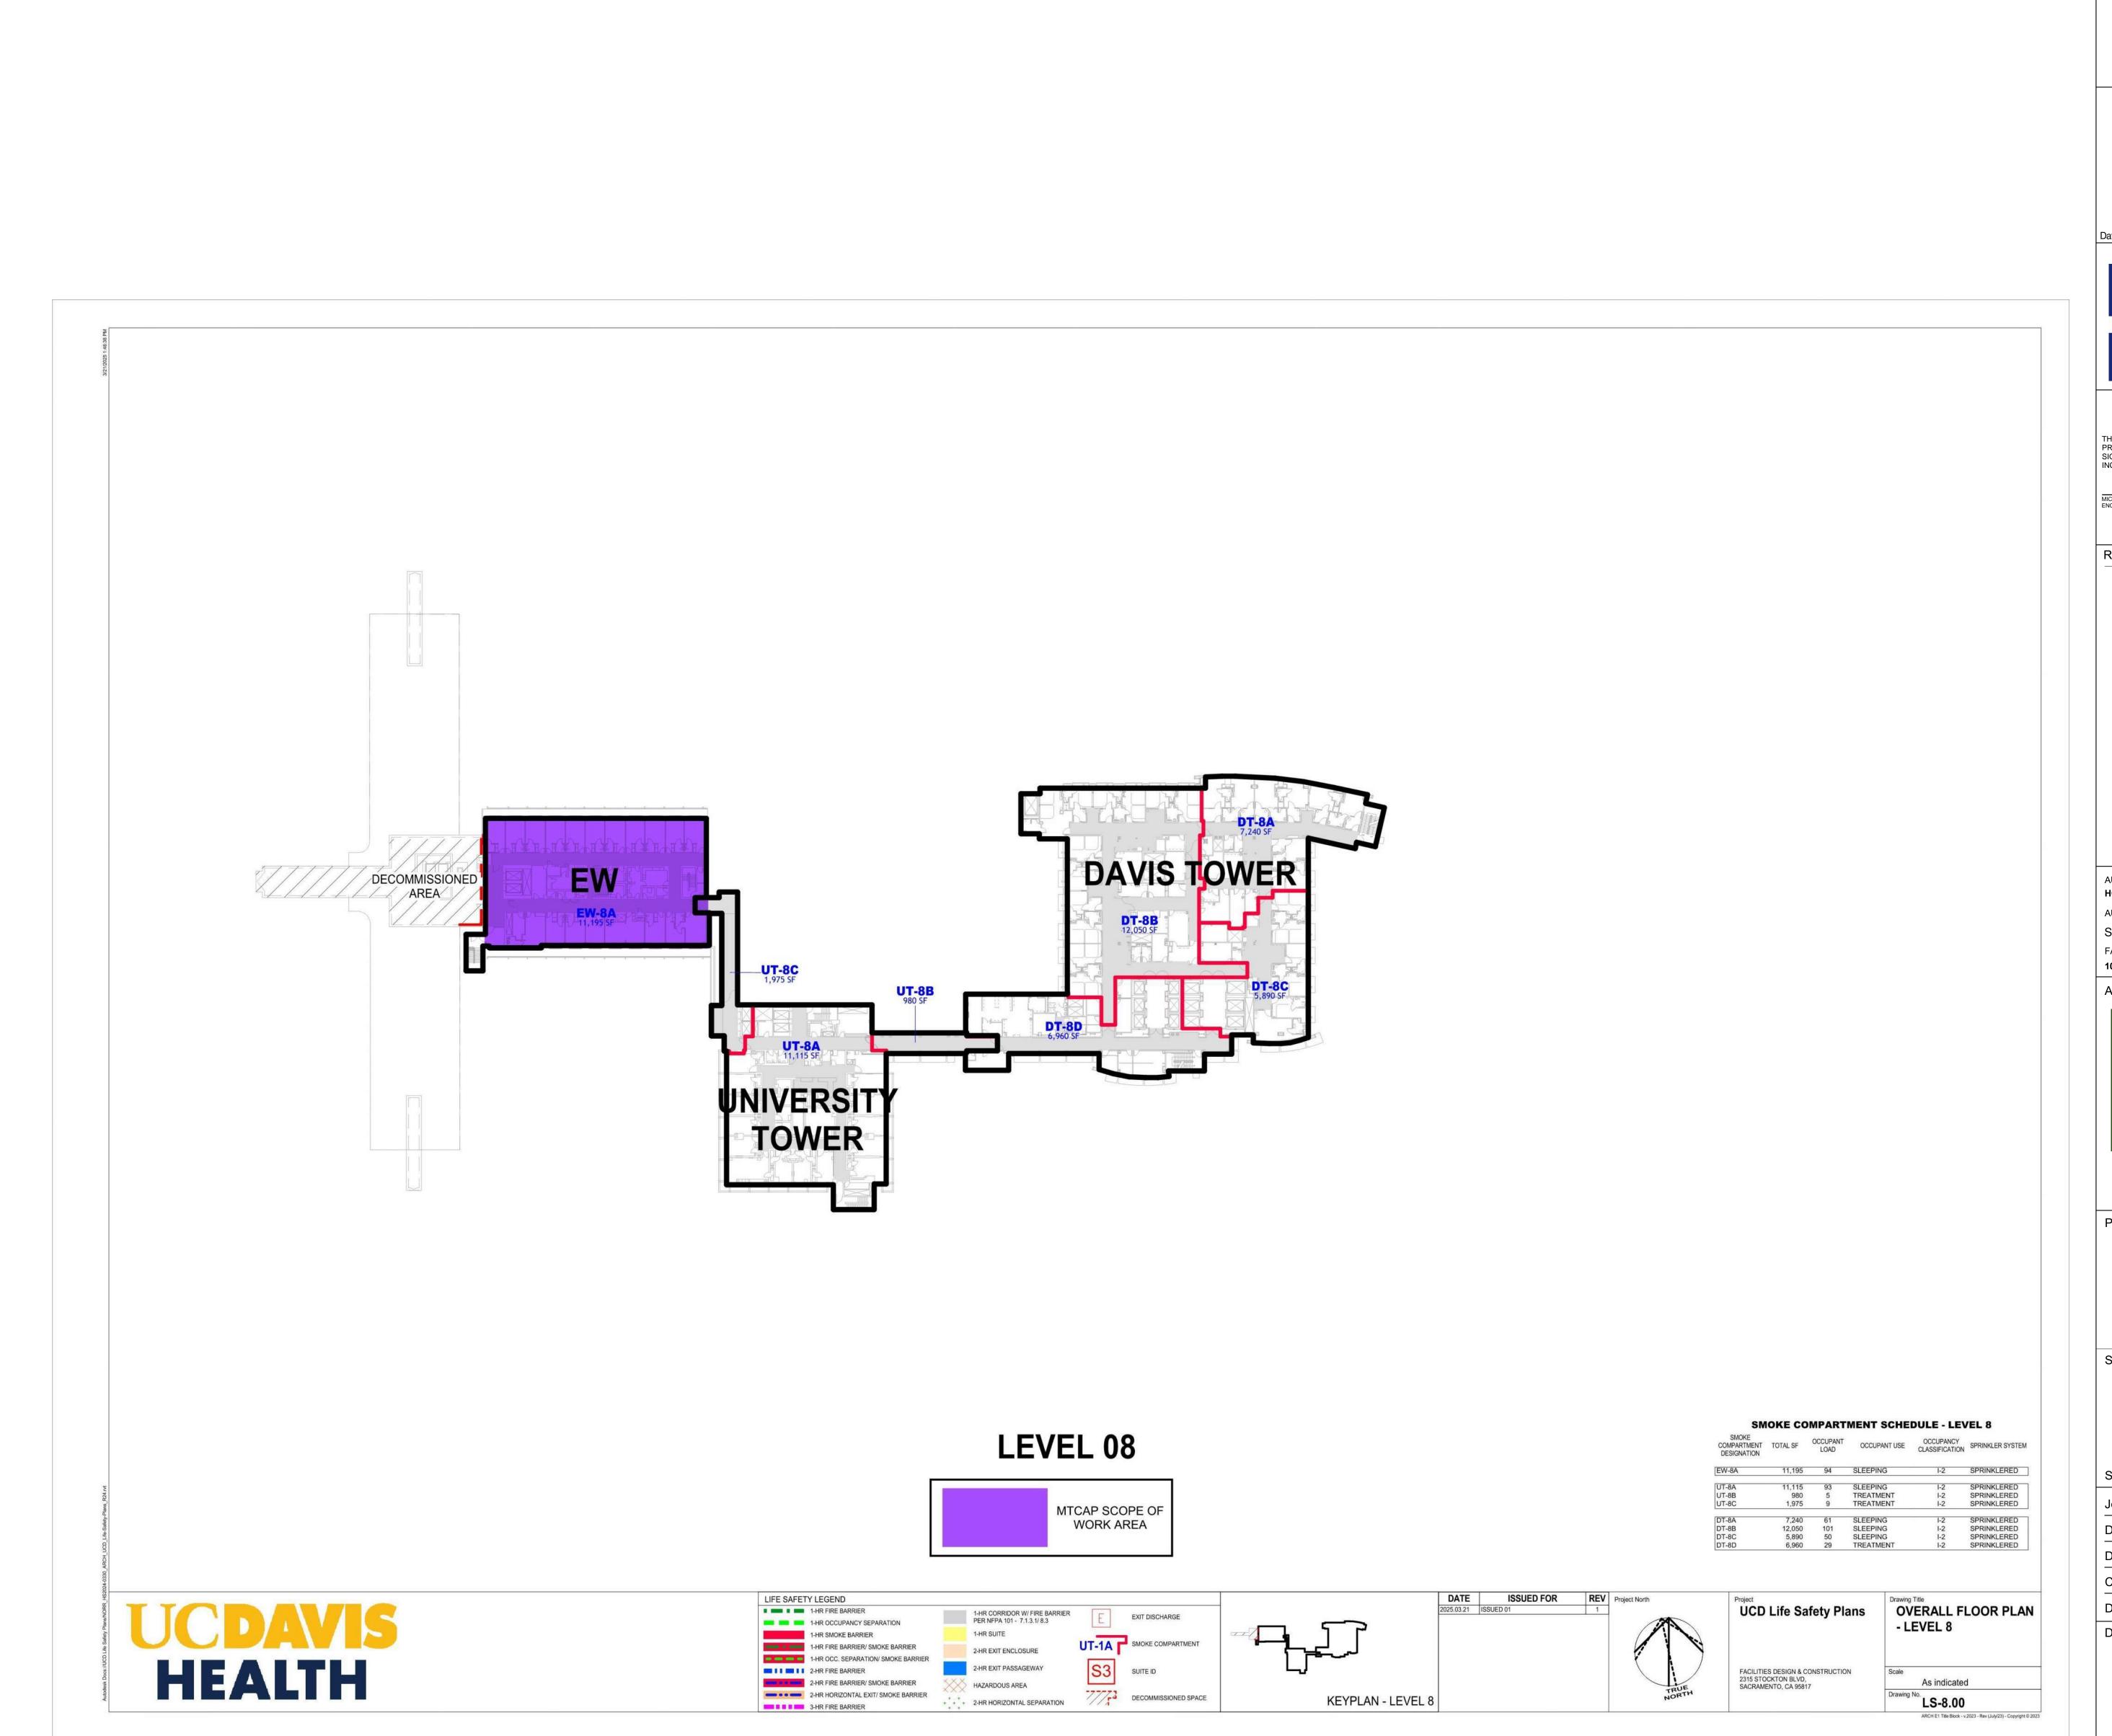

one inch = one foot

three-quarters inch = one foot

one and one-half inches = one foot

one-quarter inch = one foot

one-eighth inch = one foot

one-half inch = one foot

IF THIS DRAWING IS NOT 30inx42in IT IS A REDUCED REFER TO GRAPHIC SCALE

OWNER:






Sacramento, CA 95814 916.418.9100 PHONE www.degenkolb.com DE Job Number: C2953022.04





Date Signed: 05/05/2025

three inches = one foot

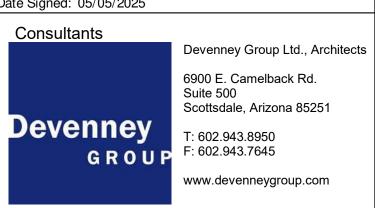

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07/10/2025 MICHAEL ALLEN, STRUCTURAL ENGINEER OF RECORD, CA S5414 DATE

	Revision		
Description	Date		
	Description		

AUTHORITY HAVING JURISDICTION:

AUTHORITY HAVING JURISDICTION'S PROJECT NO. S251130-34-00 FACILITY NUMBER

AGENCY APPROVALS:



UCDH MEDICAL CENTER EAST WING TOWER & EAST WING RADIOLOGY MTCAP

Sheet Title:

OVERALL FLOOR PLAN LEVEL 8 FIRE/LIFE SAFETY

NTS Scale: 9167.25.0001 Job Number: Drawn by: Design by: Checked by: May 2, 2025 Date:

Drawing Number: AC-019

of Sheets

LEVEL 8 - EW PLAN SCALE: 3/32" = 1'-0"
 DATE
 ISSUED FOR
 REV
 Project North

 2025.03.21
 ISSUED 01
 1
 LIFE SAFETY LEGEND UCD Life Safety Plans Drawing Title LEVEL 8 - EW ■ ■ 1-HR FIRE BARRIER 1-HR CORRIDOR W/ FIRE BARRIER PER NFPA 101 - 7.1.3.1/ 8.3 1-HR OCCUPANCY SEPARATION 1-HR SMOKE BARRIER UT-1A SMOKE COMPARTMENT 1-HR FIRE BARRIER/ SMOKE BARRIER 2-HR EXIT ENCLOSURE HEALTH 1-HR OCC. SEPARATION/ SMOKE BARRIER 2-HR EXIT PASSAGEWAY 2-HR FIRE BARRIER FACILITIES DESIGN & CONSTRUCTION 2315 STOCKTON BLVD, SACRAMENTO, CA 95817 SUITE ID As indicated 2-HR FIRE BARRIER/ SMOKE BARRIER Drawing No. LS-8.01 2-HR HORIZONTAL EXIT/ SMOKE BARRIER KEYPLAN - LEVEL 8 2-HR HORIZONTAL SEPARATION 3-HR FIRE BARRIER ARCH E1 Title Block - v.2023 - Rev (July/23) - Copyright © 2023

one inch = one foot

three-quarters inch = one foot

one and one-half inches = one foot

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DEGENKOLB ENGINEERS 428 J Street, Suite 500 Sacramento, CA 95814 916.418.9100 PHONE www.degenkolb.com

DE Job Number: C2953022.04

SEALS AND SIGNATURES



Date Signed: 05/05/2025

three inches = one foot



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DATE

07/10/2025 MICHAEL ALLEN, STRUCTURAL ENGINEER OF RECORD, CA S5414

Revision Date Description

AUTHORITY HAVING JURISDICTION:

AUTHORITY HAVING JURISDICTION'S PROJECT NO. S251130-34-00 FACILITY NUMBER

AGENCY APPROVALS:



UCDH MEDICAL CENTER EAST WING TOWER & **EAST WING RADIOLOGY** MTCAP

Sheet Title:

FLOOR PLAN LEVEL 8 - EW FIRE/LIFE SAFETY

NTS Scale: 9167.25.0001 Job Number: Drawn by: Design by: Checked by: May 2, 2025 Date:

Drawing Number:

of Sheets

one-eighth inch = one foot

one-quarter inch = one foot


OWNER:

 STUD SCHEDULE

 MAX STUD HEIGHT
 STUD SIZE
 CRIPPLE WALL STUD


 11'-6"
 362S162-43 @ 16" OC
 362S162-43 @ 16" OC

NOTE: 54 MIL (16-GAGE) STUDS MAY BE USED.

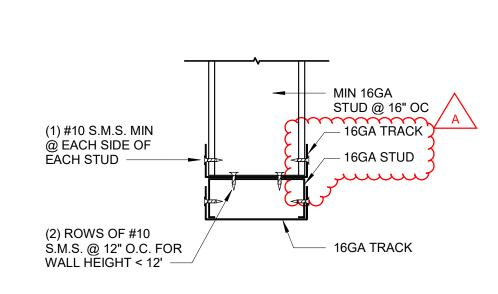


HEADER SECTION (4'-0" MAX
OPENING WIDTH)

3" = 1'-0"

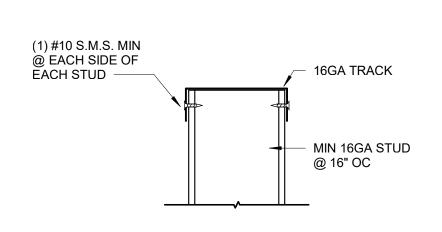



SILL SECTION (4'-0" MAX
OPENING WIDTH)

3" = 1'-0"

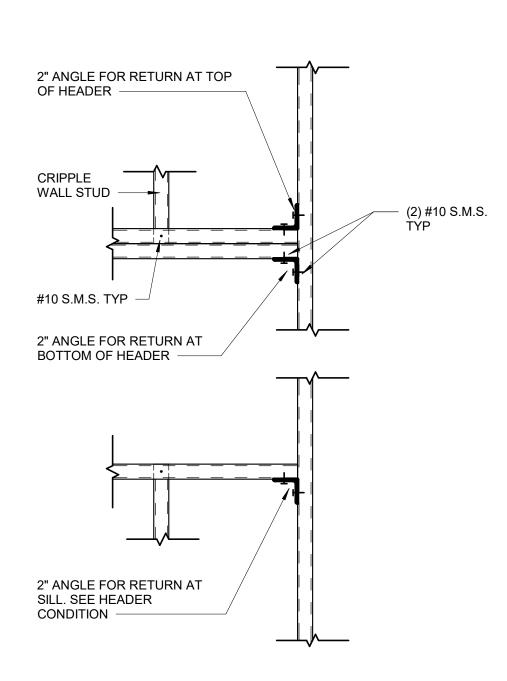


HEADER & SILL CONNECTION TO JAMB STUDS (4'-0" MAX OPENING

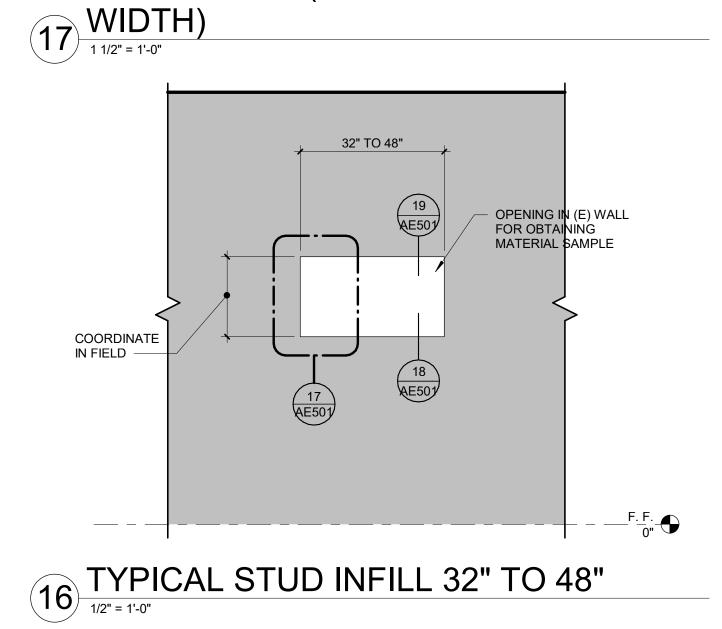

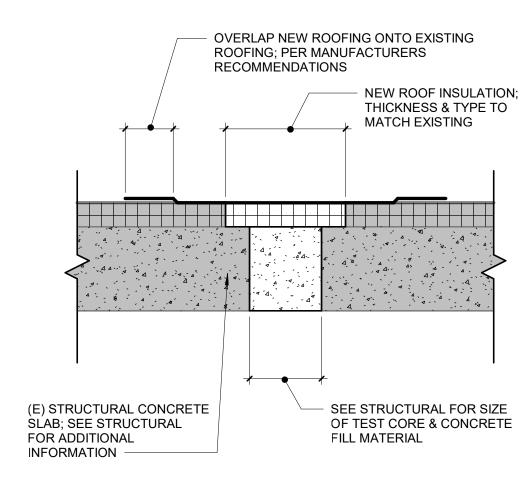


ROOF PATCH DETAIL


1 1/2" = 1'-0"

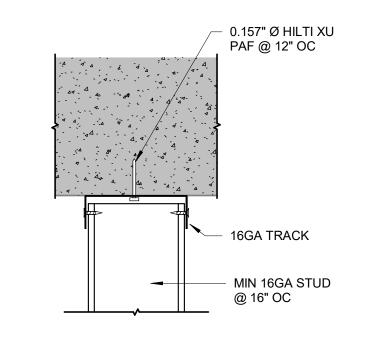

TOP OF PARTITION 3" = 1'-0"

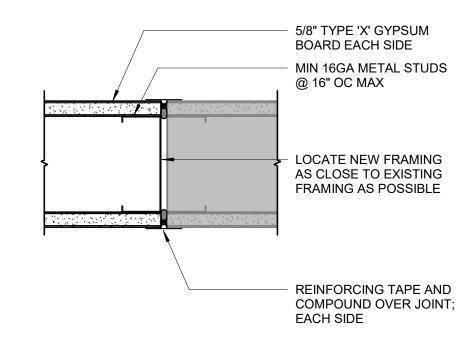


JAMB SECTION 3" = 1'-0"

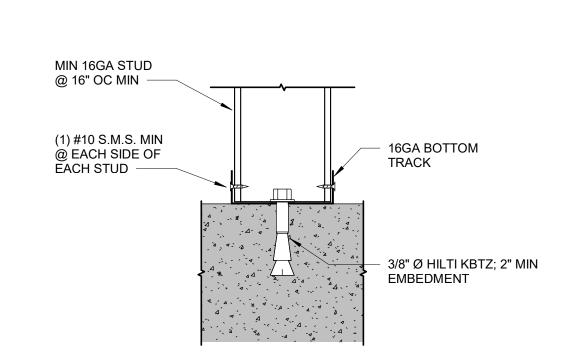


BASE OF PARTITION


3" = 1'-0"

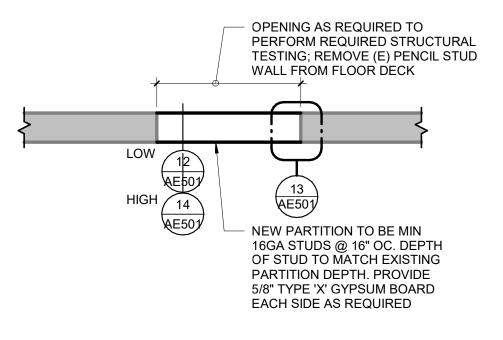

TYPICAL STUD INFILL @
BASE/HEAD OF PARTITION
1/2" = 1'-0"

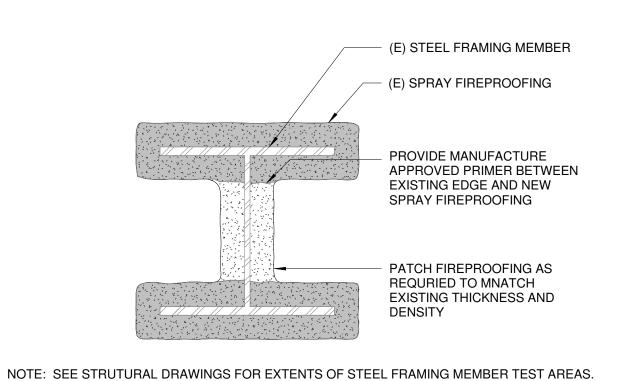



6 DETAIL @ SPRAY FIREPROOFING PATCH

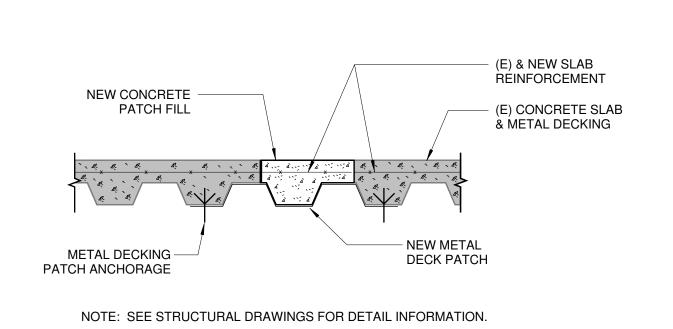


DETAIL - CONCRETE ON METAL DECK

N.T.S.

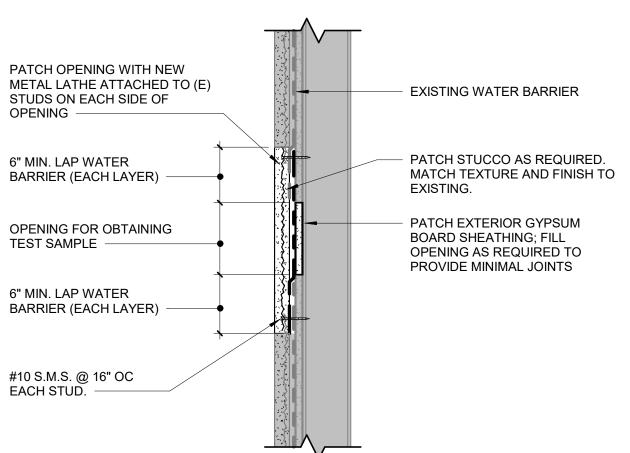

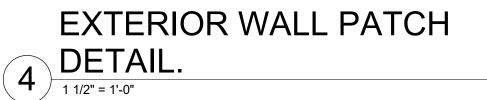

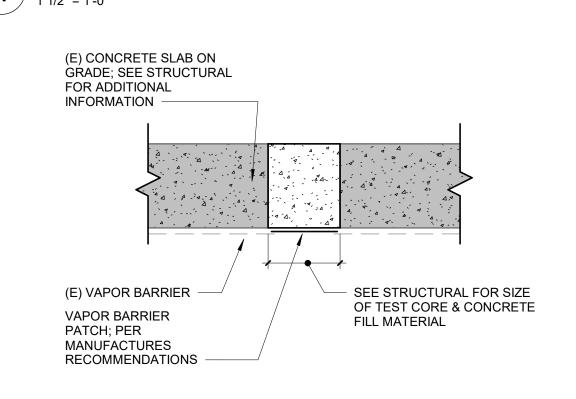


NOTE: VAPOR BARRIER IS NOT REQUIRED AT ELEVATED FLAT SLAB TEST LOCATIONS.

VAPOR BARRIER PATCH


DETAIL

1 1/2" = 1'-0"

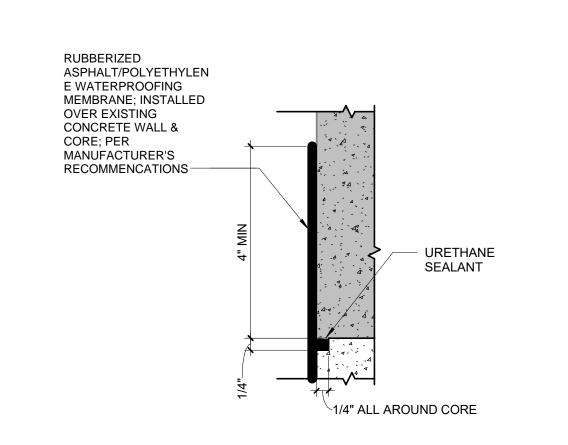

WALL PATCH DETAIL

6" = 1'-0"

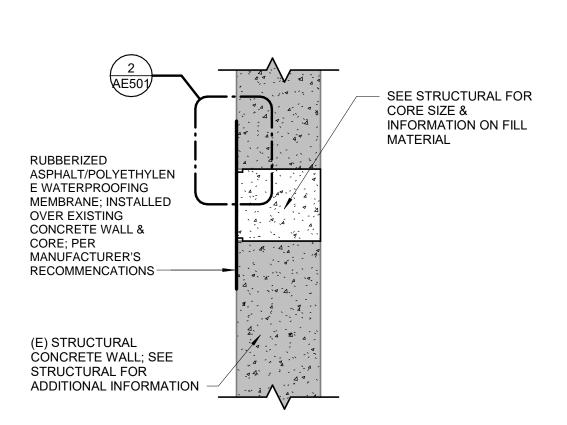

EXTERIOR WALL PATCH
DETAIL

1 1/2" = 1'-0"









Date Signed: September 2, 2025

Consultants

Devenney Group Ltd., Arch



SEALS AND SIGNATURES

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Mile Olla 09/02/2025

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	CHAEL ALLEN, STRUCTURAL				
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Revision					
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No.	Description	Date
Α	BACKCHECK #1	08/20/25

AUTHORITY HAVING JURISDICTION:
HCAI

AUTHORITY HAVING JURISDICTION'S PROJECT NO
S251130-34-00
FACILITY NUMBER

AGENCY APPROVALS:

Sheet Title:

Drawing Number:



Project: UCDH MEDICAL CENTER EAST WING TOWER & EAST WING RADIOLOGY MTCAP

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Scale:	NOTED
Job Number:	9167.25.0001
Drawn by:	

ocaic.	NOTED
Job Number:	9167.25.0001
Drawn by:	
Design by:	
Checked by:	
Date:	May 2, 2025

AE-501

1E-50 i

of Sheets

one-half inch = one foot three-quarters inch = one foot one-eighth inch = one foot one-quarter inch = one foot

one inch = one foot

one and one-half inches = one foot

three inches = one foot

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OWNER:

HEALTH









Date Signed: 05/05/2025



SEALS AND SIGNATURES

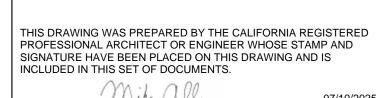

07/10/2025 MICHAEL ALLEN, STRUCTURAL ENGINEER OF RECORD, CA S5414 DATE

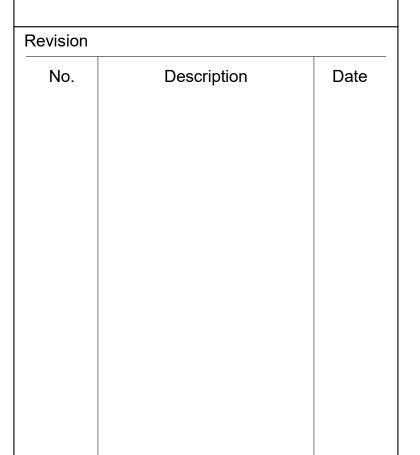

AUTHORITY HAVING JURISDICTION:

AUTHORITY HAVING JURISDICTION'S PROJECT NO. S251130-34-00 FACILITY NUMBER

AGENCY APPROVALS:



UCDH MEDICAL CENTER EAST WING TOWER & EAST WING RADIOLOGY MTCAP

Sheet Title:

ARCHITECTURAL REPAIR DETAILS

Scale:	NOTED
Job Number:	9167.25.0001
Drawn by:	
Design by:	
Checked by:	
Date:	May 2, 2025

Drawing Number:

AE-502


1 GYPSUM BOARD CEILING PLAN

1" = 1'-0"


FOR CEILING ACCESS OLIANTITIES AND LOCATIONS OF SAME FOR CEILING ACCESS QUANTITIES AND LOCATIONS, SEE CABLING SUB-CONTRACTOR

NEW HAT CHANNEL SCREWED INTO EXISTING BLACK IRON STEEL CHANNEL WITH (2) #10 SMS EACH SIDE AND EACH END (E) HANGER WIRE (E) METAL FRAMING (E) GYP BD CEILING (E) METAL FRAMING PATCH, REPAIR AND MAKE CEILING GOOD WITH (N) GYP BD, FIRE-RATED WHERE REQUIRED WHEN WORK ABOVE CEILING IS COMPLETE #10 DRYWALL SCREWS AT 12" O.C. PROVIDE METAL FRAMING AND GYP BD CEILING TO MATCH EXISTING HEIGHT WHEN WORK ABOVE CEILING IS COMPLETED -

TEMPORARY ACCESS HATCH AT GYPSUM 3 BOARD CEILING SECTION PATCH

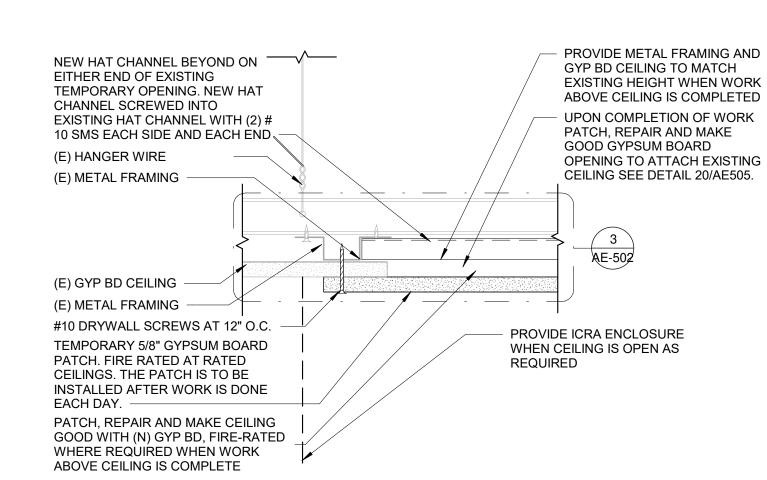

TEMPORARY ACCESS HATCH AT GYPSUM BOARD CEILING SECTION 3" = 1'-0"

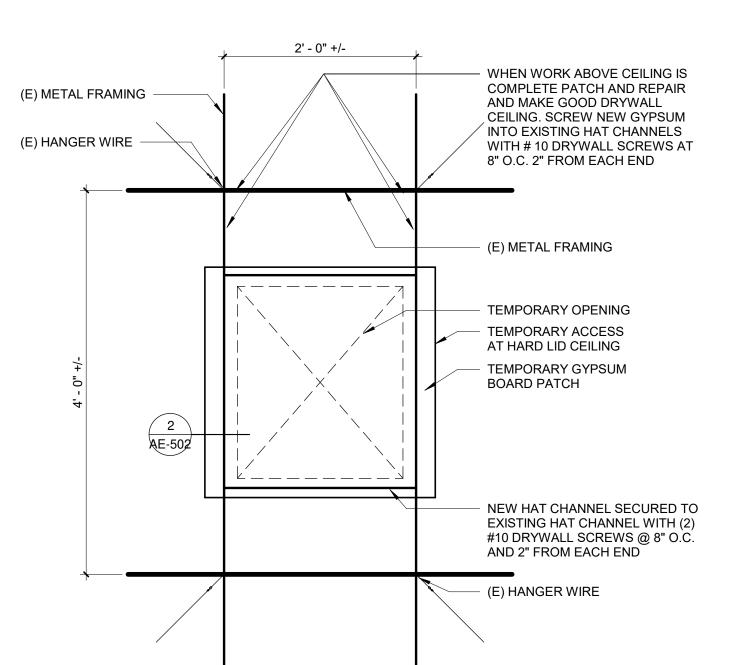

TEMPORARY ACCESS HATCH AT





DEGENKOLB ENGINEERS 428 J Street, Suite 500 Sacramento, CA 95814 916.418.9100 PHONE www.degenkolb.com DE Job Number: C2953022.04

SEALS AND SIGNATURES



Devenney Group Ltd., Architects 201 W. Indian School Road Phoenix, Arizona 85013 Devenney : 602.943.8950 F: 602.943.7645 www.devenneygroup.com

SEALS AND SIGNATURES

Consultants

Revision Description HCAi Backcheck #1

AUTHORITY HAVING JURISDICTION:

AUTHORITY HAVING JURISDICTION'S PROJECT NO. S251130-34-00 FACILITY NUMBER 10619

AGENCY APPROVALS:



UCDH MEDICAL CENTER EAST WING TOWER & EAST WING RADIOLOGY

Sheet Title:

GENERAL NOTES

Scale: C2953022.05 Job Number: Drawn by: Design by: Checked by: 07/10/2025

Date: Drawing Number:

GENERAL SPECIFICATIONS

DEFINITIONS AND LANGUAGE:

THE FOLLOWING WORDS AND TERMS ARE USED IN THESE SPECIFICATIONS AND ARE DEFINED AS FOLLOWS AS APPLICABLE: AS APPROPRIATE FOR THE PARTICULAR CONDITION, CIRCUMSTANCE, OR SITUATION. AS REQUIRED: AS REQUIRED BY REGULATORY REQUIREMENTS, BY REFERENCED STANDARDS, BY EXISTING CONDITIONS, OR BY THE CONTRACT DOCUMENTS.

FURNISH: SUPPLY AND DELIVER TO THE SITE. PROVIDE: FURNISH AND INSTALL SATISFACTORY: TO THE SATISFACTION OF THE OWNER'S REPRESENTATIVE; SUBJECT TO THE OWNER'S REPRESENTATIVE'S ACCEPTANCE.

AS DIRECTED: AS INSTRUCTED BY THE OWNER'S REPRESENTATIVE IN WRITING.

SPECIFIED: AS SPECIFIED IN THESE SPECIFICATIONS. THESE SPECIFICATIONS ARE WRITTEN PRIMARILY IN THE IMPERATIVE MOOD: IMPERATIVE LANGUAGE IS DIRECTED TO THE TESTING AGENCY. THE INDICATIVE MOOD IS EMPLOYED ON OCCASION WHEN SUCH SENTENCE STRUCTURE IS NECESSARY TO CONVEY THE INTENDED MEANING.

APPLY FOR, OBTAIN, AND PAY FOR BUILDING PERMITS AND OTHER PERMITS REQUIRED TO PERFORM WORK. REFERENCE STANDARDS:

THE CONTRACT DOCUMENTS CONTAIN REFERENCES TO VARIOUS STANDARD SPECIFICATIONS, CODES, PRACTICES, AND REQUIREMENTS FOR MATERIALS, WORK QUALITY, INSTALLATION, INSPECTIONS, AND TESTS, WHICH ARE PUBLISHED AND ISSUED BY THE ORGANIZATIONS, SOCIETIES, AND ASSOCIATIONS NOTED HEREIN. SUCH REFERENCES ARE HEREBY MADE A PART OF THE CONTRACT DOCUMENTS TO THE EXTENT SPECIFIED OR REQUIRED. REFERENCE TO CODES, RULES, REGULATIONS, STANDARDS, MANUFACTURER'S INSTRUCTIONS OR REQUIREMENTS OF

UNLESS THE DOCUMENT DATE IS SHOWN. **DRAWINGS AND DETAILS:** DO NOT SCALE THE DRAWINGS INFORMATION SHOWN ON THE DRAWINGS RELATED TO EXISTING CONDITIONS REPRESENTS THE PRESENT KNOWLEDGE, BUT WITHOUT GUARANTEE OF ACCURACY. REPORT CONDITIONS THAT CONFLICT WITH THE CONTRACT DOCUMENTS TO

REGULATORY AGENCIES IS TO THE LATEST PRINTED EDITION OF EACH IN EFFECT AT THE DATE OF SUBMISSION OF BID

THE OWNER'S REPRESENTATIVE. DO NOT DEVIATE FROM THE CONTRACT DOCUMENTS WITHOUT WRITTEN DIRECTION FROM THE OWNER'S REPRESENTATIVE. **CUTTING AND PATCHING:**

CUT MATERIALS WITH APPROPRIATE TOOLS. DO NOT CUT AND PATCH IN A MANNER THAT WOULD RESULT IN THE FOLLOWING DEFICIENCIES:

DECREASED FIRE PERFORMANCE, DECREASED ACOUSTICAL PERFORMANCE, DECREASED ENERGY PERFORMANCE,

DECREASED OPERATIONAL LIFE, OR **DECREASED LIFE SAFETY FACTORS** PATCH WITH ALL NEW MATERIALS USING ESTABLISHED METHODS TO PRODUCE A FINISHED PATCH THAT IS NOT VISIBLE FROM A DISTANCE OF THREE FEET. IN CASE REMOVAL OF GYPSUM BOARD AT NONSTRUCTURAL WALLS IS REQUIRED TO ACCESS THE STRUCTURAL ELEMENTS TO BE SAMPLED, NEW GYPSUM BOARD AND CONNECTIONS TO MATCH EXISTING

NON-SHRINK GROUT, 3,000 PSI MIN: EUCLID CHEMICAL COMPANY'S "EUCO-NS", L & M CRYSTEX, MASTER BUILDERS' "MASTERFLOW 713", OR FIVE STAR GROUT. WHERE HIGH FLUIDITY OR INCREASED PLACING TIME IS REQUIRED, USE EUCLID CHEMICAL COMPANY'S "EUCO HI-FLOW GROUT" OR MASTER BUILDERS' "MASTERFLOW 928". PLACE GROUT AND PREPARE SURFACE PER MANUFACTURER'S RECOMMENDATIONS. GROUT TESTING PER ASTM C109. VERIFY SURFACES MEET 1/4" ROUGHNESS REQUIREMENTS PRIOR TO APPLICATION OF GROUT.

ALL INTERIOR CORES AND PRISMS MUST BE REPAIRED ON THE SAME DAY. IF DUE TO UNEXPECTED CONDITIONS IT IS NOT POSSIBLE TO REPAIR A SAMPLE ON THE SAME DAY, PROVIDE TEMPORARY CONSTRUCTION BARRIERS AROUND THE AFFECTED AREA. SEE SHEET G001 FIRE SAFETY DURING CONSTRUCTION AND DEMOLITION FOR REQUIREMENTS.

PRIOR TO START OF CONSTRUCTION, ARRANGE FOR AND CONDUCT A CONFERENCE TO DISCUSS PROCEDURES TO BE FOLLOWED DURING THE PROGRESS OF THE WORK. CONFERENCE SHALL BE ATTENDED BY OWNER'S REPRESENTATIVE TESTING AGENCY, AND MAJOR SUBCONTRACTORS.

QUALITY ASSURANCE: COMPLY WITH THE FOLLOWING CODES:

CALIFORNIA CODE OF REGULATIONS, CCR, TITLE 24 BUILDING STANDARDS, INCLUDING THE FOLLOWING PARTS:

2021 IBC AND 2022 CALIFORNIA AMENDMENTS 2020 NEC AND 2022 CALIFORNIA AMENDMENTS 2021UMC AND 2022 CALIFORNIA AMENDMENTS

2021 UPC AND 2022 CALIFORNIA AMENDMENTS 2021 IFC AND 2022 CALIFORNIA AMENDMENTS STATE FIRE MARSHAL REGULATIONS - DIVISION 1, PUBLIC SAFETY, TITLE 19, CCR.

CALIFORNIA CODE OF REGULATIONS, TITLE 8 - INDUSTRIAL RELATIONS (CAL/OSHA), DIVISION 1 DEPARTMENT OF INDUSTRIAL RELATIONS, CHAPTER 4 - DIVISION OF INDUSTRIAL SAFETY. CALIFORNIA CODE OF REGULATIONS, TITLE 17, PUBLIC HEALTH.

CALIFORNIA CODE OF REGULATIONS, CCR, TITLE 22, SOCIAL SECURITY, DIVISION 7 HEALTH PLANNING AND FACILITY CONSTRUCTION, AND CHAPTER 7, SEISMIC STRUCTURAL SAFETY STANDARDS. NATIONAL FIRE CODES, NFC LATEST EDITION BY REFERENCE BY FEDERAL STATE AND LOCAL GOVERNMENTS. FEDERAL OCCUPATIONAL SAFETY AND HEALTH ACT OF 1970 (OSHA).

USE SKILLED AND EXPERIENCED MECHANICS AND CRAFT PERSONS. PERFORM ALL WORK IN ACCORDANCE WITH ESTABLISHED ACCEPTED PRACTICES OF THE VARIOUS TRADES INVOLVED AND IN ACCORDANCE WITH APPLICABLE MANUFACTURER'S WRITTEN INSTRUCTIONS. PROVIDE PRODUCTS AND MATERIALS SPECIFIED. REQUEST OWNER REPRESENTATIVE'S SELECTION OF COLORS AND ACCESSORIES IN SUFFICIENT TIME TO AVOID DELAYING PROGRESS OF THE WORK, DELIVER, HANDLE, AND STORE

MATERIALS IN ACCORDANCE WITH MANUFACTURER'S INSTRUCTIONS. INSTALL MATERIALS IN EXACT COMPLIANCE WITH MANUFACTURER'S WRITTEN INSTRUCTIONS AND APPROVED SUBMITTALS. PERFORM WORK IN PROPER RELATIONSHIP TO THE WORK OF OTHER TRADES. COMPLETED WORK SHALL BE FREE FROM

SUBMIT TO SEOR FOR APPROVAL PRODUCT DATA, 1 COPY;

TEST REPORTS, 1 COPY COPIES OF INSPECTION REPORTS, NOTICES AND SIMILAR DOCUMENTS. HIGH RESOLUTION COLOR PHOTOGRAPHS OF ALL TESTING LOCATIONS SHOWING PRE-CONSTRUCTION,

CONSTRUCTION, AND POST-CONSTRUCTION CONDITIONS (I.E. REPAIR WORK AND SAMPLES).

FIREPROOFING

FIREPROOFING

REPLACE REMOVED FIREPROOFING WITH 2 INCHES MINIMUM THICKNESS, BUT NOT LESS THAN EXISTING THICKNESS AT THAT LOCATION. PROVIDE TESTING/INSPECTION FOR CONFIRMATION THAT PATCH/REPAIR MEETS THE UL DESIGN FOR THE

APPLY FIREPROOFING IN ACCORDANCE WITH MANUFACTURER'S U.L. DESIGN NUMBER:

X-772 FOR COLUMNS

HAND PACKING: MINIMUM DENSITY OF PATCH MATERIAL IS 15 POUNDS PER CUBIC FOOT (PCF) AVERAGE AND 14 PCF INDIVIDUAL, AS TESTED USING ASTM E-605 TEST METHOD. AREA OF HAND PACKING SHALL NOT EXCEED 144 SQUARE

INCHES PER MEMBER USE WR GRACE SYSTEM "MK-6". PRIMARY STRUCTURAL FRAMING – 3 HRS

SECONDARY STRUCTURAL FRAMING - 2 HRS COLUMNS – 3 HRS

CONCRETE FIREPROOFING

STEEL COLUMNS ARE ENCASED IN 3000 PSI FIREPROOFING CONCRETE. REMOVAL OF CONCRETE IS NECESSARY TO ACCESS COLUMNS, AND CONNECTIONS FOR MATERIAL SAMPLING AND CONDITION **ASSESSMENTS** REPAIR CONCRETE FIREPROOFING USING SIKACRETE - 211 SCC PLUS FOR COLUMN REPAIR USING FORMWORK WHERE

REPAIR OF WELDED WIRE FABRIC AROUND COLUMNS IS NOT REQUIRED

MTP CONCRETE CORES

CONCRETE CORES TESTING:

TAKE CORES WITH 3" DIAMETER X 6" MINIMUM DEPTH, UNLESS OTHERWISE NOTED OR PHYSICALLY NOT POSSIBLE. IF SLAB DEPTH IS LESS THAN 8", THEN TAKE A 3" DIAMETER THROUGH CORE. WHERE APPROVED BY SEOR, 3" DIAMETER CORES ARE ALSO PERMITTED WHERE REBAR CONGESTION IS OBSERVED. FOLLOW ASTM C42 PROCEDURES FOR REMOVAL OF CORES. TESTING LABORATORY MUST APPLY CORRECTION FACTORS FOR DIFFERENT TEST SAMPLE ASPECT L/D RATIOS PER ASTM C42 AND C39. PROVIDE A MINIMUM OF 3 CORE DIAMETERS OF SOUND CONCRETE FOR THE CORE NEXT TO AN EXISTING CORE. COORDINATE THE TOTAL NUMBER, AND LOCATIONS OF CORES TAKEN, WITH INFORMATION SHOWN ON ATTACHED

SCHEDULES AND DRAWINGS. LOCATE EXISTING REINFORCEMENT USING NON-DESTRUCTIVE TEST AND AVOID ALL EXISTING REINFORCEMENT PRIOR TO THE REMOVAL OF THE CORES. IF REINFORCEMENT IS ENCOUNTERED DURING CORING, ABANDON AND SHIFT THE HOLE LOCATION TO AVOID THE REINFORCEMENT. PROVIDE A MINIMUM OF 3 CORE DIAMETERS OF SOUND CONCRETE BETWEEN THE NEW CORE AND THE ABANDONED CORE.

CORE LOCATIONS FOUNDATIONS: TAKE CONCRETE CORE SAMPLES AS INDICATED ON ATTACHED PLANS AND DETAILS. IN ACCORDANCE WITH PROCEDURES CONTAINED IN ASTM C 42. A SAMPLE MAY BE RELOCATED UPON APPROVAL

FROM THE OSHPD SEISMIC COMPLIANCE UNIT. SUSPENDED SLABS: TAKE CONCRETE CORES AND REINFORCING STEEL SAMPLES AS INDICATED ON ATTACHED PLANS AND DETAILS. IN ACCORDANCE WITH PROCEDURES CONTAINED IN ASTM C 42. TAKE SAMPLES FROM THE TOP OF THE SLAB. DO NOT TAKE SAMPLES WITHIN 18 INCHES FROM ANY CONCRETE SHEAR WALLS OR CONCRETE COLUMNS UNLESS APPROVED BY SEOR. DO NOT CUT EXISTING REINFORCEMENT OTHER THAN THAT INDICATED IN DETAILS. A SAMPLE MAY BE RELOCATED UPON APPROVAL FROM THE OSHPD SEISMIC COMPLIANCE UNIT. CONCRETE WALLS: TAKE CONCRETE CORES AND REINFORCING STEEL SAMPLES AS INDICATED ON ATTACHED

PLANS AND DETAILS. IN ACCORDANCE WITH PROCEDURES CONTAINED IN ASTM C 42, DO NOT TAKE SAMPLES

WITHIN 36 INCHES FROM THE BOTTOM OF THE STRUCTURAL SLAB OR WITHIN 36 INCHES FROM THE TOP OF THE FLOOR SLAB UNLESS APPROVED BY SEOR. DO NOT CUT EXISTING REINFORCEMENT OTHER THAN THAT INDICATED IN DETAILS. A SAMPLE MAY BE RELOCATED UPON APPROVAL FROM THE OSHPD SEISMIC COMPLIANCE UNIT. AFTER COMPLETION OF CORING OPERATION, COMPLETELY FILL CYLINDRICAL VOID WITH NON-SHRINK GROUT. PROVIDE NECESSARY FIRE PROTECTION OVER DISRUPTED AREAS. FINISH SURFACE FLUSH WITH ORIGINAL SURFACE. PATCH AND REPAIR ALL DISTURBED FINISHES TO MATCH EXISTING SURFACE AND ADJACENT FINISHES.

NON-SHRINK GROUT, 5,000 PSI: EUCLID CHEMICAL COMPANY'S "EUCO-NS", L & M CRYSTEX, MASTER BUILDERS' "MASTERFLOW 713", OR FIVE STAR GROUT. WHERE HIGH FLUIDITY OR INCREASED PLACING TIME IS REQUIRED, USE EUCLID CHEMICAL COMPANY'S "EUCO HI-FLOW GROUT" OR MASTER BUILDERS' "MASTERFLOW 928". PLACE GROUT AND PREPARE

SURFACE PER MANUFACTURER'S RECOMMENDATIONS. TEST EACH SAMPLE IN ACCORDANCE WITH PROCEDURES CONTAINED IN ASTM C 42 AND C 39 OR C496. SUBMIT THE FOLLOWING RESULTS IN A COMPLETE TESTING REPORT:

COMPRESSIVE STRENGTH UNIT WEIGHT

MODULUS OF ELASTICITY (MAY BE ESTIMATED PER ASCE 41-13 10 2 2 4 2 2)

PHOTOGRAPH OF SAMPLE LOCATION PRIOR TO EXTRACTION. PHOTOS TO INCLUDE PLAN ID. PHOTOGRAPH OF EACH SAMPLE BEFORE AND AFTER TEST. PHOTOS TO INCLUDE PLAN ID. PHOTOGRAPH OF REPAIR WORK, PHOTOS TO INCLUDE PLAN ID.

MTP REINFORCING

REINFORCING STEEL (DESTRUCTIVE/TENSILE TEST): TAKE REINFORCING BAR SAMPLES WITH A LENGTH OF 20" MINIMUM.

REPAIR ALL REINFORCING STEEL SAMPLES (EITHER HORIZONTAL OR VERTICAL) BY SPLICING A NEW LENGTH OF BAR WITH MECHANICAL COUPLERS. WELDED BAR SPLICE CONFORMING TO AWS D1.4 IS PERMITTED PROVIDED CHEMICAL TESTING IS DONE TO DOCUMENT WELDABILITY OF EXISTING REINFORCING BARS. BASED ON THE CHEMICAL COMPOSITION TESTS, A WELDING PROCEDURE SPECIFICATION INCLUDING WELD MATERIAL GRADE/STRENGTH AND PREHEATING REQUIREMENTS SHALL BE DEVELOPED AND SUBMITTED TO SEOR AND HCAI FOR REVIEW PRIOR TO REPAIR. REINFORCING STEEL.

TYPE REINFORCING STEEL #7 AND SMALLER ASTM A615, 60 KSI REINFORCING STEEL # 8 AND LARGER AND ASTM A706, 60 KSI REINFORCING STEEL TO BE WELDED

MECHANICAL COUPLERS: BAR-LOCK COUPLER SYSTEM, TYPE 2 (L-SERIES), IAPMO ER 0319. INFILL THE LOCATIONS OF THE REINFORCING STEEL SAMPLE WITH MORTAR. ROUGHEN EXPOSED CONCRETE SURFACES TO 1/4" AMPLITUDE AND CLEAN OF LAITANCE, FOREIGN MATTER, AND LOOSE PARTICLES AND PAINT TO MATCH EXISTING CONDITIONS. WHERE GREATER THAN 1.5" THICKNESS IS REQUIRED, USE GROUT AS NOTED IN CONCRETE CORE REPAIR

MORTAR: SIKATOP 122 PLUS OR SIKATOP 123 PLUS TWO COMPONENT POLYMER MODIFIED MORTAR, OR APPROVED EQUAL TEST EACH REINFORCING BAR SAMPLE IN ACCORDANCE WITH PROCEDURES CONTAINED IN ASTM A370-A9, ASTM A751 AND

ASTM A615. TEST FULL SECTION OF BAR OR WIRE, NOT REDUCED DIAMETER SECTION. SUBMIT THE FOLLOWING RESULTS IN A COMPLETE TESTING REPORT:

YIELD AND TENSILE STRENGTH MODULUS OF ELASTICITY

CHEMICAL COMPOSITION CARBON EQUIVALENT

STEEL SURFACE DEFORMATION DESCRIPTION FOR EACH SAMPLE

MODE OF FAILURE FOR EACH SAMPLE STRESS VERSUS STRAIN PLOT

PHOTOGRAPH OF SAMPLE LOCATION PRIOR TO EXTRACTION. PHOTOS TO INCLUDE PLAN ID. PHOTOGRAPH OF EACH SAMPLE BEFORE AND AFTER TEST. PHOTOS TO INCLUDE PLAN ID PHOTOGRAPH OF REPAIR WORK, PHOTOS TO INCLUDE PLAN ID.

MTP METAL DECK

METAL DECK TESTING: METAL DECK COUPONS SHALL BE 2 INCHES WIDE BY 18 INCHES LONG, MINIMUM, FOR WEB THICKNESS EQUAL TO OR GREATER THAN 3/16", AND SHALL BE 3/4 INCHES WIDE BY 8 INCHES LONG, MINIMUM, FOR WEB THICKENSS LESS THAN 3/16"

REPAIR ALL STRUCTURAL STEEL COUPONS IN ACCORDANCE WITH CONSTRUCTION DOCUMENTS. STRUCTURAL STEEL PLATE USED FOR REPAIRS SHALL BE ASTM A572 GR. 50. SUBMIT THE FOLLOWING RESULTS IN A COMPLETE TESTING REPORT:

YIELD AND TENSILE STRENGTH MODULUS OF ELASTICITY

CHEMICAL COMPOSITION (COMPLETE LIST OF COMPONENTS PER ASTM A751)

CARBON EQUIVALENT ELONGATION

MODE OF FAILURE FOR EACH SAMPLE STRESS VERSUS STRAIN PLOT PHOTOGRAPH OF SAMPLE LOCATION PRIOR TO EXTRACTION. PHOTOS TO INCLUDE PLAN ID.

PHOTOGRAPH OF EACH SAMPLE BEFORE AND AFTER TEST. PHOTOS TO INCLUDE PLAN ID. PHOTOGRAPH OF REPAIR WORK. PHOTOS TO INCLUDE PLAN ID.

C.A.P. REQUIREMENTS DEG PRIME CONDITION ASSESSMENT REQUIREMENTS

REPORT WILL BE PROVIDED BY DEGENKOLB ENGINEERS AND STAMPED BY CA LICENSED PROFESSIONAL ENGINEER. IT WILL INCLUDE A SUMMARY OF ALL CONDITIONS ASSESSED. REPORT SHALL INCLUDE PHOTOGRAPHS OF ALL TESTING LOCATIONS CLEARLY LINKED TO PLAN CALLOUTS AS REQUIRED BY

OTHER SECTIONS OF THIS SPECIFICATION. REPORT SHALL INCLUDE MEASUREMENTS AND DIMENSIONS AS REQUIRED BY TABLES IN DETAILS ON SHEETS S501 AND S502. NARRATIVE DESCRIPTIONS OF DEVIATIONS FROM EXPECTED CONDITIONS SHALL BE INCLUDED ON A CASE BY CASE BASIS TO

INFORM ENGINEER OF DEVIATIONS. NOTE DEVIATIONS ON DETAILS PROVIDED FOR VERIFICATION AS REQUIRED.

C.A.P. CONCRETE ELEMENT

CONCRETE ELEMENT VERIFICATION REINFORCED CONCRETE ELEMENT (DESTRUCTIVE VERIFICATION):

NOTIFY SEOR 48 HOURS PRIOR TO EXPOSURE. EXPOSE REINFORCING BY LOCAL MINIMIZED REMOVAL OF CONCRETE COVER AND OTHER MATERIALS TO INSPECT

REINFORCING SYSTEM DETAILS. DOCUMENT ALL STAGES OF VERIFICATION WITH PHOTOGRAPHS, PHOTOS TO INCLUDE PLAN ID.

PHOTOGRAPH OF SAMPLE LOCATION PRIOR TO EXPOSURE PHOTOGRAPH ANY PHYSICAL DETERIORATION OR DEGRADATION AND NOTIFY SEOR IMMEDIATELY

PHOTOGRAPH OF EXPOSED CONDITION

PHOTOGRAPH OF REPAIR WORK REPAIR AREA PER SPECIFICATIONS AND DETAILS AFTER SEOR HAS OBSERVED. SUBMIT SKETCHES DOCUMENTING AS-BUILT CONDITIONS AND LOCATIONS ON PLAN

NON-DESTRUCTIVE METHODS MAY BE USED FOR VERIFICATION OF TYPICAL REBAR SPACING, REBAR DEVELOPMENT LENGTH AND REBAR SPLICE LENGTH WITH SEOR APPROVAL REINFORCED CONCRETE ELEMENT (NONDESTRUCTIVE VERIFICATION):

FOR FLAT AREAS (WALLS, SLABS, ETC.), SCAN FOUR-FOOT SQUARE AREA. FOR COLUMNS, SCAN ALL FOUR SIDES OVER THE BOTTOM SIX FEET. THIS MAY BE IN SAME AREA OF REBAR EXTRACTION UNLESS NOTED OTHERWISE. MARK WALL WITH CHALK TO ILLUSTRATE REINFORCING PATTERN. CHALK MARKS SHALL REMAIN IN PLACE. TAPE MAY BE USED IN LIEU OF CHALK.

MEASURE ELEMENT SIZES AS NOTED IN DETAILS (I.E. DEPTH, THICKNESS, ETC.). DOCUMENT ALL STAGES OF VERIFICATION WITH PHOTOGRAPHS. PHOTOS TO INCLUDE PLAN ID. PHOTOGRAPH OF SAMPLE LOCATION PRIOR TO CHALK OR TAPE APPLICATION

PHOTOGRAPH OF CHALK OR TAPE AND NOTES IF DEVIATIONS FROM EXISTING DRAWINGS ARE NOTED AS A RESULT OF ANY VERIFICATION, ADDIONAL VERIFICATION LOCATIONS MAY BE REQUIRED. NOTIFY SEOR OF ANY DEVIATIONS IMMEDIATELY.

C.A.P. STRUCTURAL STEEL ELEMENT

STRUCTURAL STEEL ELEMENT VERIFICATION

LOCATIONS MAY BE REQUIRED. NOTIFY SEOR OF ANY DEVIATIONS IMMEDIATELY.

STRUCTURAL STEEL ELEMENT (NONDESTRUCTIVE VERIFICATION): PHOTOGRAPH ANY PHYSICAL DETERIORATION OR DEGRADATION AND NOTIFY SEOR IMMEDIATELY MEASURE ELEMENT MEMBER SIZES AS NOTED IN DETAILS (I.E. SHAPE, DEPTH, THICKNESS, ETC.).

NOTE MEMBER ORIENTATIONS AS REQUIRED IN DETAILS. LOCATE OR IDENTIFY PLATES AND WELDS AS NOTED IN DETAILS (I.E. DIMENSIONS, THICKNESS, CONDITION, ETC.) LOCATE OR IDENTIFY BOLTS AS NOTED IN DETAILS (I.E. BOLT SIZE, BOLT SPACING, BOLT EDGE DISTANCE, ETC.) DOCUMENT ALL STAGES OF VERIFICATION WITH PHOTOGRAPHS. PHOTOS TO INCLUDE PLAN ID.

IF DEVIATIONS FROM EXISTING DRAWINGS ARE NOTED AS A RESULT OF ANY VERIFICATION, ADDIONAL VERIFICATION

PHOTOGRAPH OF SAMPLE LOCATION PRIOR TO REMOVAL OF ARCHITECTURAL FINISHES OR FIREPROOFING. PHOTOGRAPHS OF MEASUREMENTS WHERE APPLICABLE. PHOTOGRAPH OF REPAIRED CONDITION INCLUDING REPAIR OF FIREPROOFING AND/OR REPLACEMENT OF

C.A.P. STEEL DECK

STEEL DECK VERIFICATION VERIFY DECK PROFILE.

DEPTH TOP FLUTE WIDTH

ARCHITECTURAL FINISHES.

BOTTOM FLUTE WIDTH CENTER TO CENTER FLUTE SPACING

SUBMIT THE FOLLOWING RESULTS IN A COMPLETE VERIFICATION REPORT PHOTOGRAPH OF EXPOSED VERIFICATION LOCATIONS. PHOTOS TO INCLUDE PLAN ID.

PHOTOGRAPH ANY PHYSICAL DETERIORATION OR DEGRADATION AND NOTIFY SEOR IMMEDIATELY. IF DEVIATIONS FROM EXISTING DRAWINGS ARE NOTED AS A RESULT OF ANY VERIFICATION, ADDIONAL VERIFICATION LOCATIONS MAY BE REQUIRED. NOTIFY SEOR OF ANY DEVIATIONS IMMEDIATELY.

POST-INSTALLED ANCHORS

SLAB ON GRADE REPAIR

RECOMMENDATIONS.

SLAB ON GRADE REPAIR:

one inch = one foo

ADHESIVE ANCHORS AND DOWELS ANCHORS AND DOWELS INSTALLED INTO CONCRETE SHALL BE HILTI HIT-RE-500-V3 (ICC-ESR-3814). ADHESIVE ANCHORS INSTALLED PER 19/S401 ARE EXEMPT FROM TESTING PER CBC 1910A.5.3 EXCEPTION 4

LOCATE AND PROTECT EXISTING UTILITIES TO REMAIN DURING AND/OR AFTER CONSTRUCTION.

REPAIR STEEL REINFORCEMENT PER APPLICABLE DETAILS.

STEEL ASSEMBLIES ATTACHED WITH MECHANICAL ANCHORS.

REPAIR ALL UNDERSLAB WATERPROOFING TO MATCH (E) CONDITION

BACKFILL EXCAVATION WITH REMOVED NATIVE SOIL OR ÉQUIVALENT.

SUBMIT ALL PRODUCT DATA FOR REVIEW BY SEOR.

TRAFFICKED PAVING WHERE OCCURS.

MECHANICAL ANCHORS EXPANSION OR WEDGE ANCHORS INTO CONCRETE: HILTI KB-TZ2 (ICC-ESR-4266), SIMPSON STRONG-BOLT 2 (ICC-ESR-3037) OR DEWALT POWER-STUD+ SD2 (ICC-ESR-2502), UNLESS SPECIFICALLY NOTED OTHERWISE.

CONCRETE SHALL BE QUIKRETE, 4000PSI MIN OR EQUIVALENT, ASTM C387. INSTALLATION SHALL BE PER MANUFACTURER'S

PROVIDE 90% MINIMUM COMPACTION OF BACKFILL. 95% COMPACTION OF BACKFILL UNDERNEATH HARDSCAPING OR

ALL EMBEDMENT DEPTHS NOTED ON DRAWINGS ARE EFFECTIVE EMBEDMENT PER MANUFACTURER. INSTALL ANCHORS IN ACCORDANCE WITH LATEST ICC-ESR REPORT AND MANUFACTURER INSTRUCTIONS. PROVIDE STAINLESS STEEL FASTENERS FOR EXTERIOR USE OR WHEN EXPOSED TO WEATHER. PROVIDE GALVANIZED CARBON STEEL ANCHORS AT OTHER LOCATIONS, UNLESS OTHERWISE NOTED. IF REINFORCEMENT IS ENCOUNTERED DURING DRILLING, ABANDON AND SHIFT THE HOLE LOCATION TO AVOID THE REINFORCEMENT. PROVIDE A MINIMUM OF 2 ANCHOR DIAMETERS OR 1 INCH, WHICHEVER IS LARGER, OF SOUND CONCRETE BETWEEN THE ANCHOR ANC THE ABANDONED HOLE. FILL THE ABANDONED THE HOLE WITH NON-SHRINK GROUT. IF THE ANCHOR MAY NOT BE SHIFTED AS ABOVE. THE ENGINEER WILL DETERMINE A NEW LOCATION. LOCATE REINFORCEMENT AND CONFIRM FINAL ANCHOR LOCATIONS PRIOR TO FABRICATING PLATES, MEMBERS, OR OTHER

ALL ANCHORS REQUIRE SPECIAL INSPECTION AND ARE TO BE PROOF-TESTED BY OWNER'S TESTING AND INSPECTION AGENCY IN ACCORDANCE WITH THE ICC REPORTS AND THE CODE. WEDGE, SLEEVE AND UNDERCUT ANCHORS REQUIRE PROOF TESTING. TEST 50% OF ANCHORS TO THE MANUFACTURER'S RECOMMENDED INSTALLATION TORQUE OR RECOMMENDED TORQUE IN ICC-ESR REPORT.

HCAI STANDARD PROCEDURE

HCAI STANDARD PROCESS OF CONDITION ASSESSMENT

THE CONDITIONS ASSESSMENT OF THE EXISTING STRUCTURAL AND/OR NONSTRUCTURAL COMPONENT CONFIGURATION, QUALITY OF CONSTRUCTION, PHYSICAL CONDITION, AND INTERCONNECTION TO OTHER STRUCTURAL COMPONENTS (CONDITIONS ASSESSMENT) SHALL BE CONDUCTED IN ACCORDANCE WITH THE HCAI APPROVED METHODOLOGY. HCAI SHALL CONDUCT REVIEW AND APPROVAL OF THE CONDITIONS ASSESSMENT.

PRIOR TO PERFORMANCE OF CONDITIONS ASSESSMENT, PERMITS SHALL BE OBTAINED FROM HCAI. THESE PROJECTS MAY BE PROCESSED IN ACCORDANCE WITH THE FREER MANUAL AS A FIELD REVIEW PROJECT WHEN THE FOLLOWING INFORMATION IS

AN OVERALL BUILDING FLOOR PLAN SHOWING THE PROPOSED LOCATIONS OF INSPECTION, AND: EMERGENCY PROCEDURES FOR CONSTRUCTION WORKERS, AND; DETAILS AND REQUIREMENTS FOR RESTORATION OF FINISHES AND/OR FIRE RATED ASSEMBLIES, AND; WHEN INSPECTION IMPACTS MEANS OF EGRESS, A TEMPORARY EXITING PLAN, AND;


A COPY OF THE PREVIOUSLY APPROVED MATERIALS TESTING AND ASSESSMENT CRITERIA.

CONSTRUCTION DOCUMENTS WHICH SHALL INCLUDE AT A MINIMUM:

PLANS AND DETAILS FOR TEMPORARY CONSTRUCTION BARRIERS¹, AND; FIRE WATCH PROCEDURES.1 DURING THE CONDITIONS ASSESSMENT, FIRE-RESISTIVE ASSEMBLIES, FIRE-RESISTIVE CONSTRUCTION AND THE MEANS OF EGRESS SHALL BE MAINTAINED IN ACCORDANCE WITH CHAPTERS 7 AND 33 OF THE CALIFORNIA FIRE CODE. THESE PLANS AND PROCEDURES SHALL BE REVIEWED AND APPROVED BY THE HCAI FIELD STAFF (AREA COMPLIANCE OFFICER, FIRE AND LIFE SAFETY OFFICER AND DISTRICT STRUCTURAL ENGINEER) AND THE LOCAL FIRE AUTHORITY (AS APPLICABLE) IN ACCORDANCE WITH SECTION 3301 OF THE CALIFORNIA FIRE CODE. CÓMPLIANCE WITH PROVISIONS OF CHAPTER 33 OF THE CALIFORNIA FIRE CODE ARE IN ADDITION TO ANY ADDITIONAL REGULATIONS OR REQUIREMENTS PERTAINING TO DUST CONTROL, NOISE CONTROL AND ASBESTOS ABATEMENT ENFORCED BY AGENCIES OTHER THAN HCAI FDD.

1. WHEN IT IS NOT POSSIBLE TO MAINTAIN FIRE-RESISTIVE ASSEMBLIES, FIRE-RESISTIVE CONSTRUCTION AND/OR THE MEANS OF EGRESS, TEMPORARY CONSTRUCTION BARRIERS AND/OR A FIRE WATCH SHALL BE PROVIDED IN ACCORDANCE WITH HCAI FDD CAN 9-3301 AND HCAI FDD PIN 14. WHEN DEMOLITION, INSPECTION AND RECONSTRUCTION IS CONTINUOUS, NO HOT WORK IS INVOLVED AND INSPECTORS AND CONSTRUCTION WORKERS ARE IN CONSTANT ATTENDANCE. ENFORCEMENT OF TEMPORARY CONSTRUCTION BARRIER AND / OR FIRE WATCH REQUIREMENTS MAY BE DEFERRED. UNDER THESE CONDITIONS, APPROPRIATE PROCEDURES SHALL BE ESTABLISHED IN THE EVENT OF A FIRE OR OTHER EMERGENCY.

ABBREVIATIONS

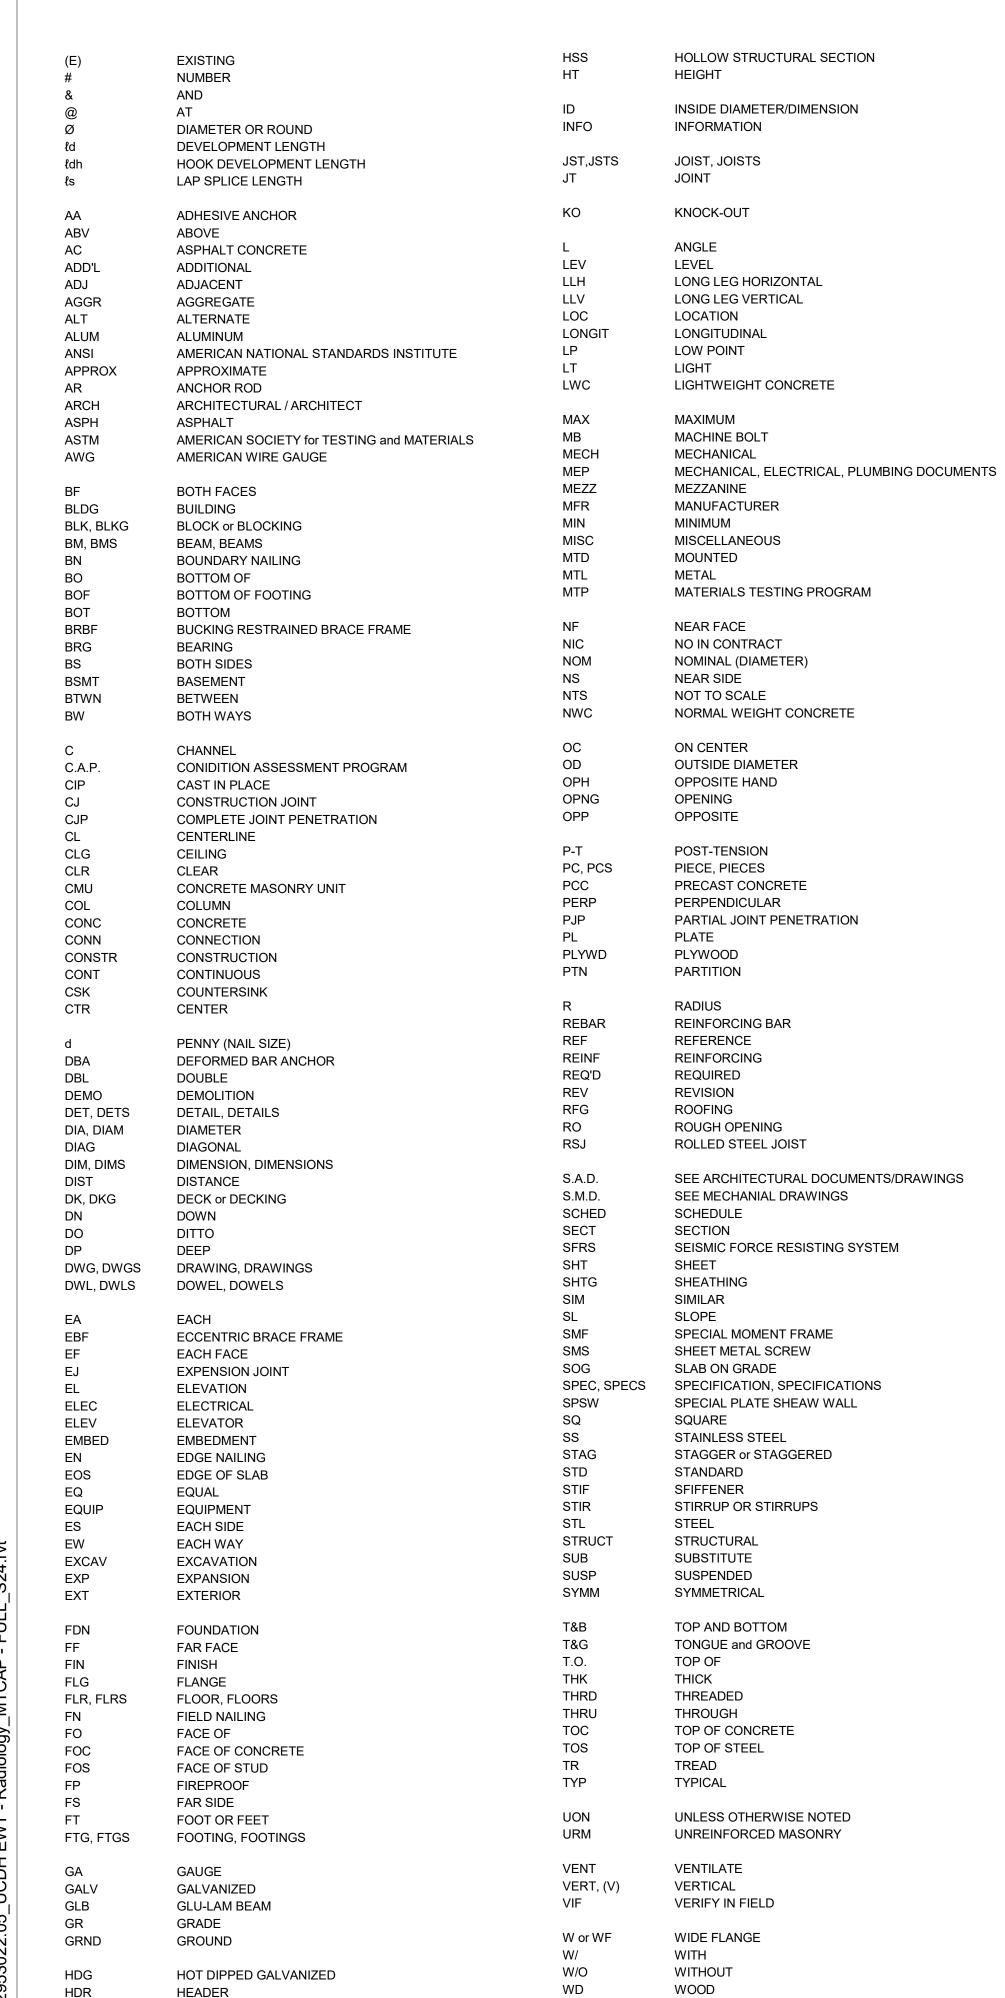

WORK POINT

EXTRA HEAVY

EXTRA STRONG

WWM

X HVY

X STR


XX HVY

XX STR

WEIGHT/TEE SECTION


WELDED WIRE MESH


DOUBLE EXTRA HEAVY DOUBLE EXTRA STRONG

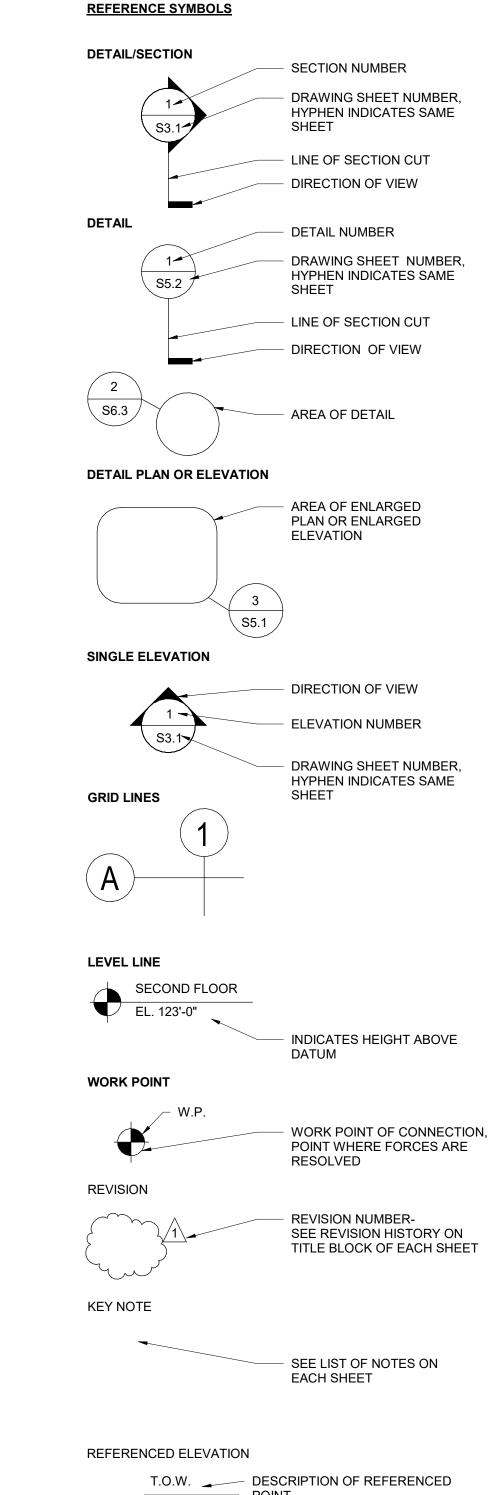


ELEVATION OF POINT

ABOVE DATUM

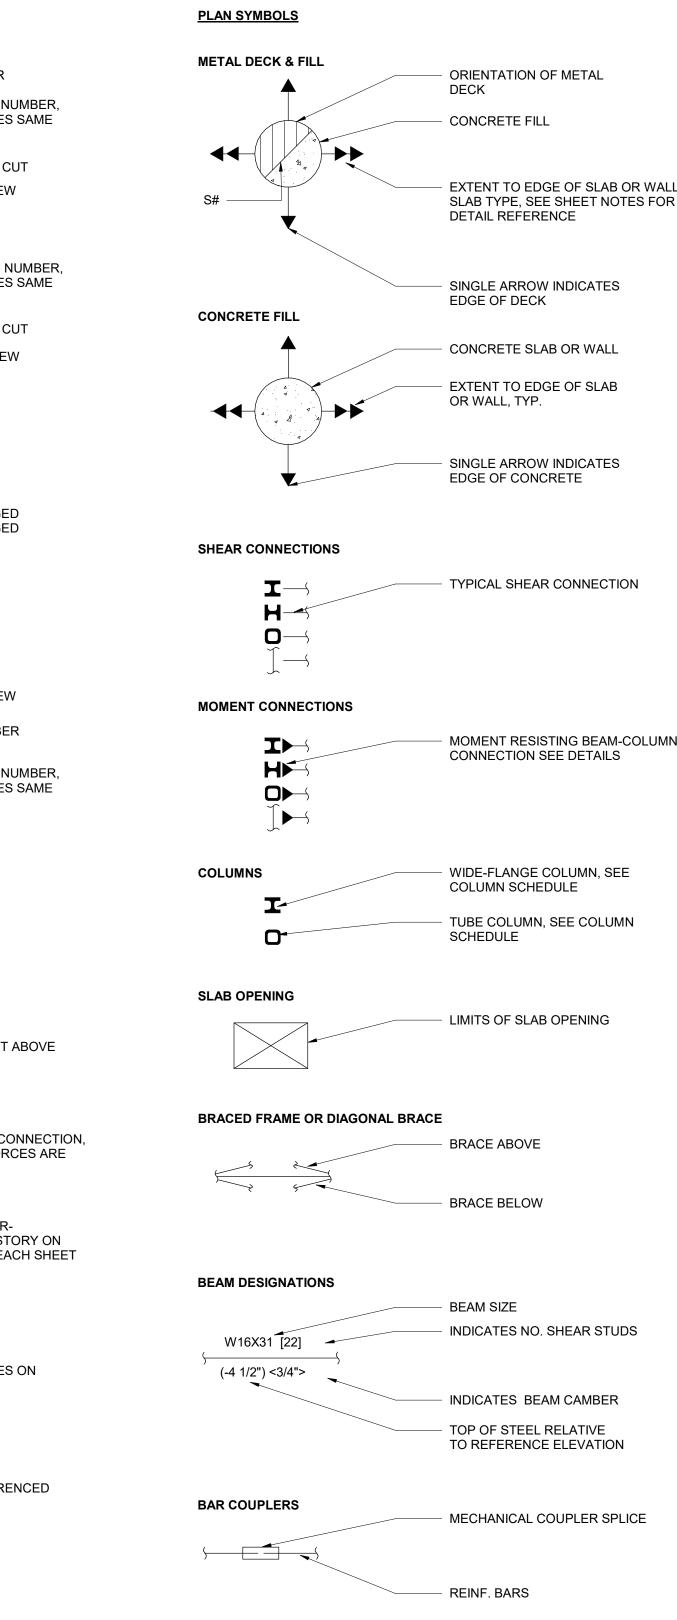

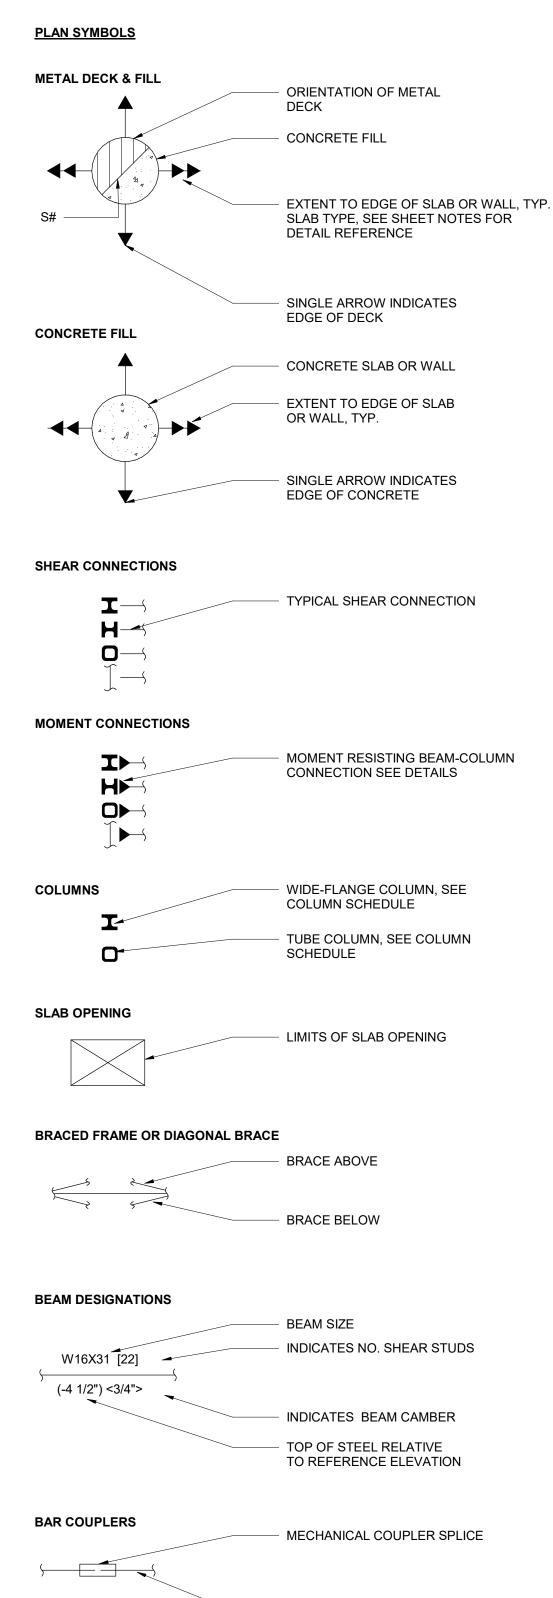

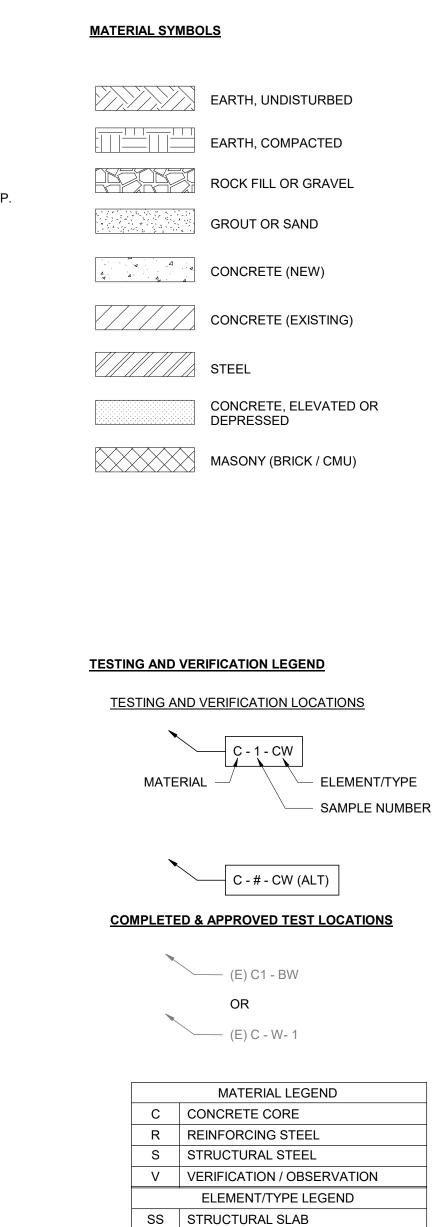

CW | CONCRETE WALL

BM BEAM

CL COLUMN

MD | METAL DECK

DW DIAPHRAGM-WALL CONNECTION

SW | SLAB TO WALL CONNECTION

PPC PRECAST PANEL CONNECTION

BW | BEAM TO WALL CONNECTION

MC | MOMENT CONNECTION

CS | COLUMN SPLICE

CB | COLUMN BASE

SG SEISMIC GAP

GS GIRDER SPLICE

WM WELD METAL

FND FOUNDATION

BLT BOLT

RV RIVET






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SEALS AND SIGNATURES



AUTHORITY HAVING JURISDICTION:

AUTHORITY HAVING JURISDICTION'S PROJECT NO. S251130-34-00 FACILITY NUMBER

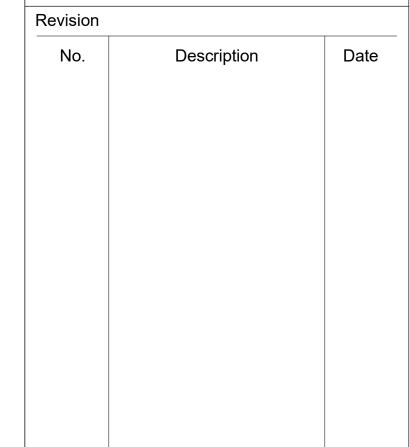

UCDH MEDICAL CENTER EAST WING TOWER & EAST WING RADIOLOGY

Sheet Title:

SYMBOLS AND **ABBREVIATIONS**

Scale:	NTS
Job Number:	C2953022.05
Drawn by:	GG
Design by:	ASH
Checked by:	MGA
Date:	07/10/2025

HOOK, HOOKS

HORIZONTAL

HIGH POINT

HIGH STRENGTH BOLTS

HK, HKS

HORIZ, (H

CONCRETE CORES TABLE

ID A	BUILDING	LEVEL	DEPARTMENT / ROOM	DETAIL	COMPRESSIVE STRENGTH (PSI)	UNIT WEIGHT (PCF)	MODULUS OF ELASTICITY (PSI
C-1-SS (ALT)	EWT	GROUND FLOOR	STORAGE 0132	1/S401			
C-2-\$\$	EWT	GROUND FLOOR	OFFICE 0102D	1/S401			
C-3-SS	EWT	GROUND FLOOR	CORRIDOR 0106 A	1/S401			
C-4-SS	EWR	GROUND FLOOR	JANITOR 0121	1/S401			
C-5-SS	EWT	GROUND FLOOR	MECH 0620B	1/S401			
C-6-SS	EWR	GROUND FLOOR	MECH 0506	1/S401			
C-7-SS (ALT)	EWR	GROUND FLOOR	JANITOR 0521	1/S401			
C-8-SS	EWR	GROUND FLOOR	STORAGE 0523A	1/S401			
C-9-SS (ALT)	EWR	GROUND FLOOR	ELEVATOR MECH 0500B	1/S401			
C-10-SS (ALT)	EWR	GROUND FLOOR	STORAGE 0509C	1/S401			
C-11-SS	EWT	1	MECH 1107C	1/S401			
C-12-SS	EWT	1	SUPPLY STORAGE 1415	1/S401			
C-13-SS	EWR	1	STORAGE 1501E	1/S401			
C-14-SS	EWT	1	VACANT 1119	1/S401			
C-15-SS	EWR	1	STORAGE 1511K	1/S401			
C-16-SS	EWR	1	STORAGE 1525A	1/S401			
C-17-SS	EWT	2	MECH 2004	6/S401			
C-18-SS	EWR	2	MECH 2340A	6/S401			
C-19-SS	EWT	9	FAN MECH 9100	6/S401			
C-20-FND	EWT	GROUND FLOOR	SHELL 0102	1/S401 & 4/S501			

REINFORCING STEEL TABLE

ID	LEVEL	DEPARTMENT / ROOM	DETAIL	YIELD STRENGTH	ULTIMATE STRENGTH	MODULUS OF ELASTICITY	CARBON EQUIVALENT	ELONGATION	STEEL SURFACE DEFORMATION
		A		(KSI)	(KSI)	(KSI)	(-)	(IN.)	(-)
R-2-SS	GROUND FLOOR	SHELL 0102	2/S401						
R-3-SS	GROUND FLOOR	STORAGE 0523A	2/S401						

METAL DECK STRUCTURAL STEEL TABLE

ID	LEVEL	DEPARTMENT / ROOM	DETAIL	YIELD STRENGTH	ULTIMATE STRENGTH	MODULUS OF ELASTICITY	CARBON EQUIVALENT	ELONGATION	STEEL SURFACE DEFORMATIO N
		~~~~~~~~~		(KSI)	(KSI)	(KSI)	(-)	(IN.)	(-)
S-3-MD	9	(ELEVATOR LOBBY 8146 (BELOW))	4/S401						
		A							

#### CONDITION ASSESSMENT TABLE

ID	YEAR	LEVEL		CONDITION DESCRIPTION	DETAIL REFERENCE
V-1-SW	1964	GROUND FLOOR	CORRIDOR 0100	FOUNDATION-SLAB-WALL CONNECTION	2/S501
V-2-CB	1964	GROUND FLOOR	SHELL 0102	COLUMN BASE TO FOUNDATION CONNECTION	4/S501
V-3-SG	1964	1	CORRIDOR 0518 (BELOW)	SEISMIC GAP BETWEEN EWR & NORTH-SOUTH WING	11/S501
V-4-DW	1964	2	OUTSIDE (BELOW)	BEAM TO EXTERIOR WALL CONNECTION - EWR	14/S401
V-5-DW	1964	2	CORRIDOR (BELOW)	BEAM TO INTERIOR WALL CONNECTION - EWR	15/S501
V-6-GS	1964	2	STORAGE 1511B (BELOW)	GIRDER SPLICE AND BEAM CONNECTION - EWR	20/S501
V-7-SG	1964	2	CORRIDOR 1515 (BELOW)	SEISMIC GAP BETWEEN EWT & EWR	12/S501
V-8-SG	1964	2	CORRIDOR 1000 (BELOW)	SEISMIC GAP BETWEEN EWT & NORTH-SOUTH WING	13/S501
V-11-BW	1964	3	MECH 2340A (BELOW)	BEAM TO WALL CONNECTION - EWR ROOF	5/S501
V-15-CW	1964	4	MECH 4144	MASONRY PARTITION WALL	7/S501

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DE Job Number: C2953022.04

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AGENCY APPROVALS:



UCDH MEDICAL CENTER EAST WING TOWER & EAST WING RADIOLOGY MTCAP

Sheet Title:

SCHEDULES & TABLES

Scale:	3/4" = 1'-0"
Job Number:	C2953022.05
Drawn by:	GG
Design by:	ASH
Checked by:	MGA
Date:	07/10/2025

Drawing Number:



one inch = one foot

three-quarters inch = one foot

one-quarter inch = one foot

one-eighth inch = one foot

one-half inch = one foot

one and one-half inches = one foot

IF THIS DRAWING IS NOT 30inx42in IT IS A REDUCED

three inches = one foot




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No.	Description	Date
A HCA	Ai Backcheck #1	08/25/2025

EAST WING TOWER & EAST WING RADIOLOGY

Scale:	As indicated
Job Number:	C2953022.05
Drawn by:	GG
Design by:	ASH
Checked by:	MGA
Date:	07/10/2025
Drawing Number:	

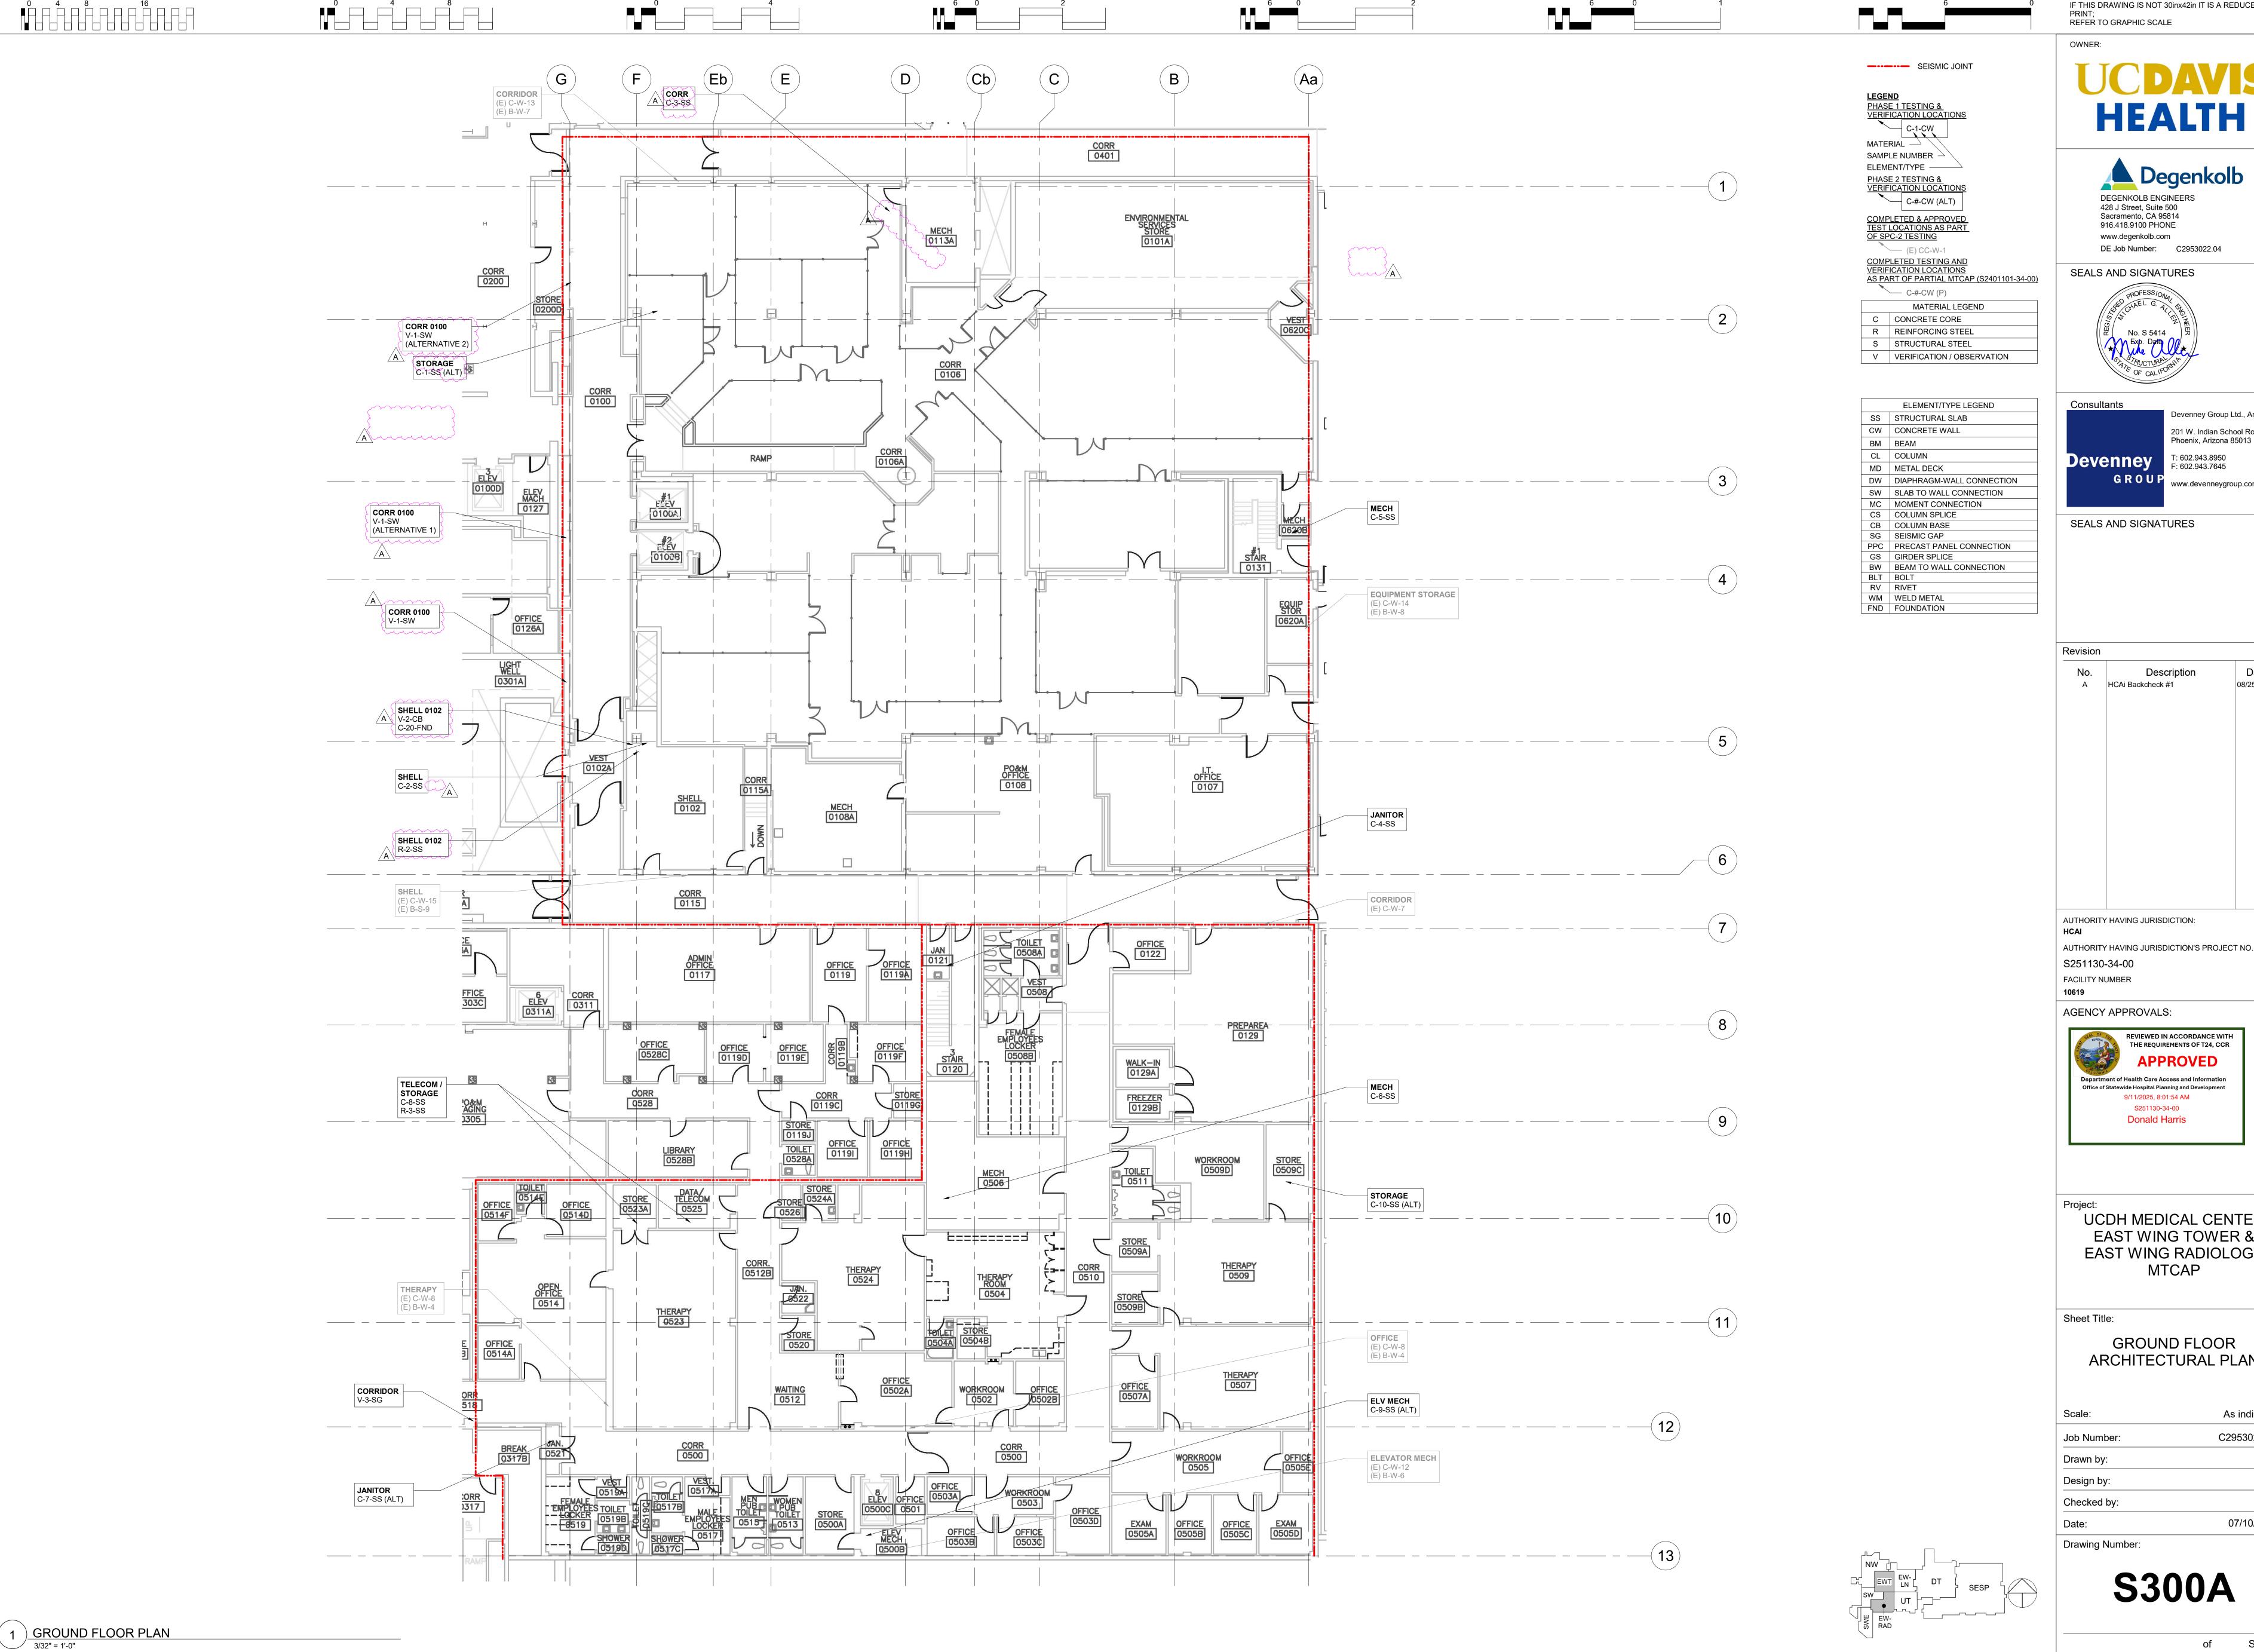

three-quarters inch = one foot

one-quarter inch = one foot

one-eighth inch = one foot

one-half inch = one foot

one inch = one foot

one and one-half inches = one foot

IF THIS DRAWING IS NOT 30inx42in IT IS A REDUCED

three inches = one foot

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No. A	Description HCAi Backcheck #1	Date 08/25/2025		




UCDH MEDICAL CENTER EAST WING TOWER & EAST WING RADIOLOGY

**GROUND FLOOR** ARCHITECTURAL PLAN

Scale:	As indicated
Job Number:	C2953022.05
Drawn by:	GG
Design by:	ASH
Checked by:	MGA
Date:	07/10/2025
Drawing Number:	

**S300A** 

of Sheets

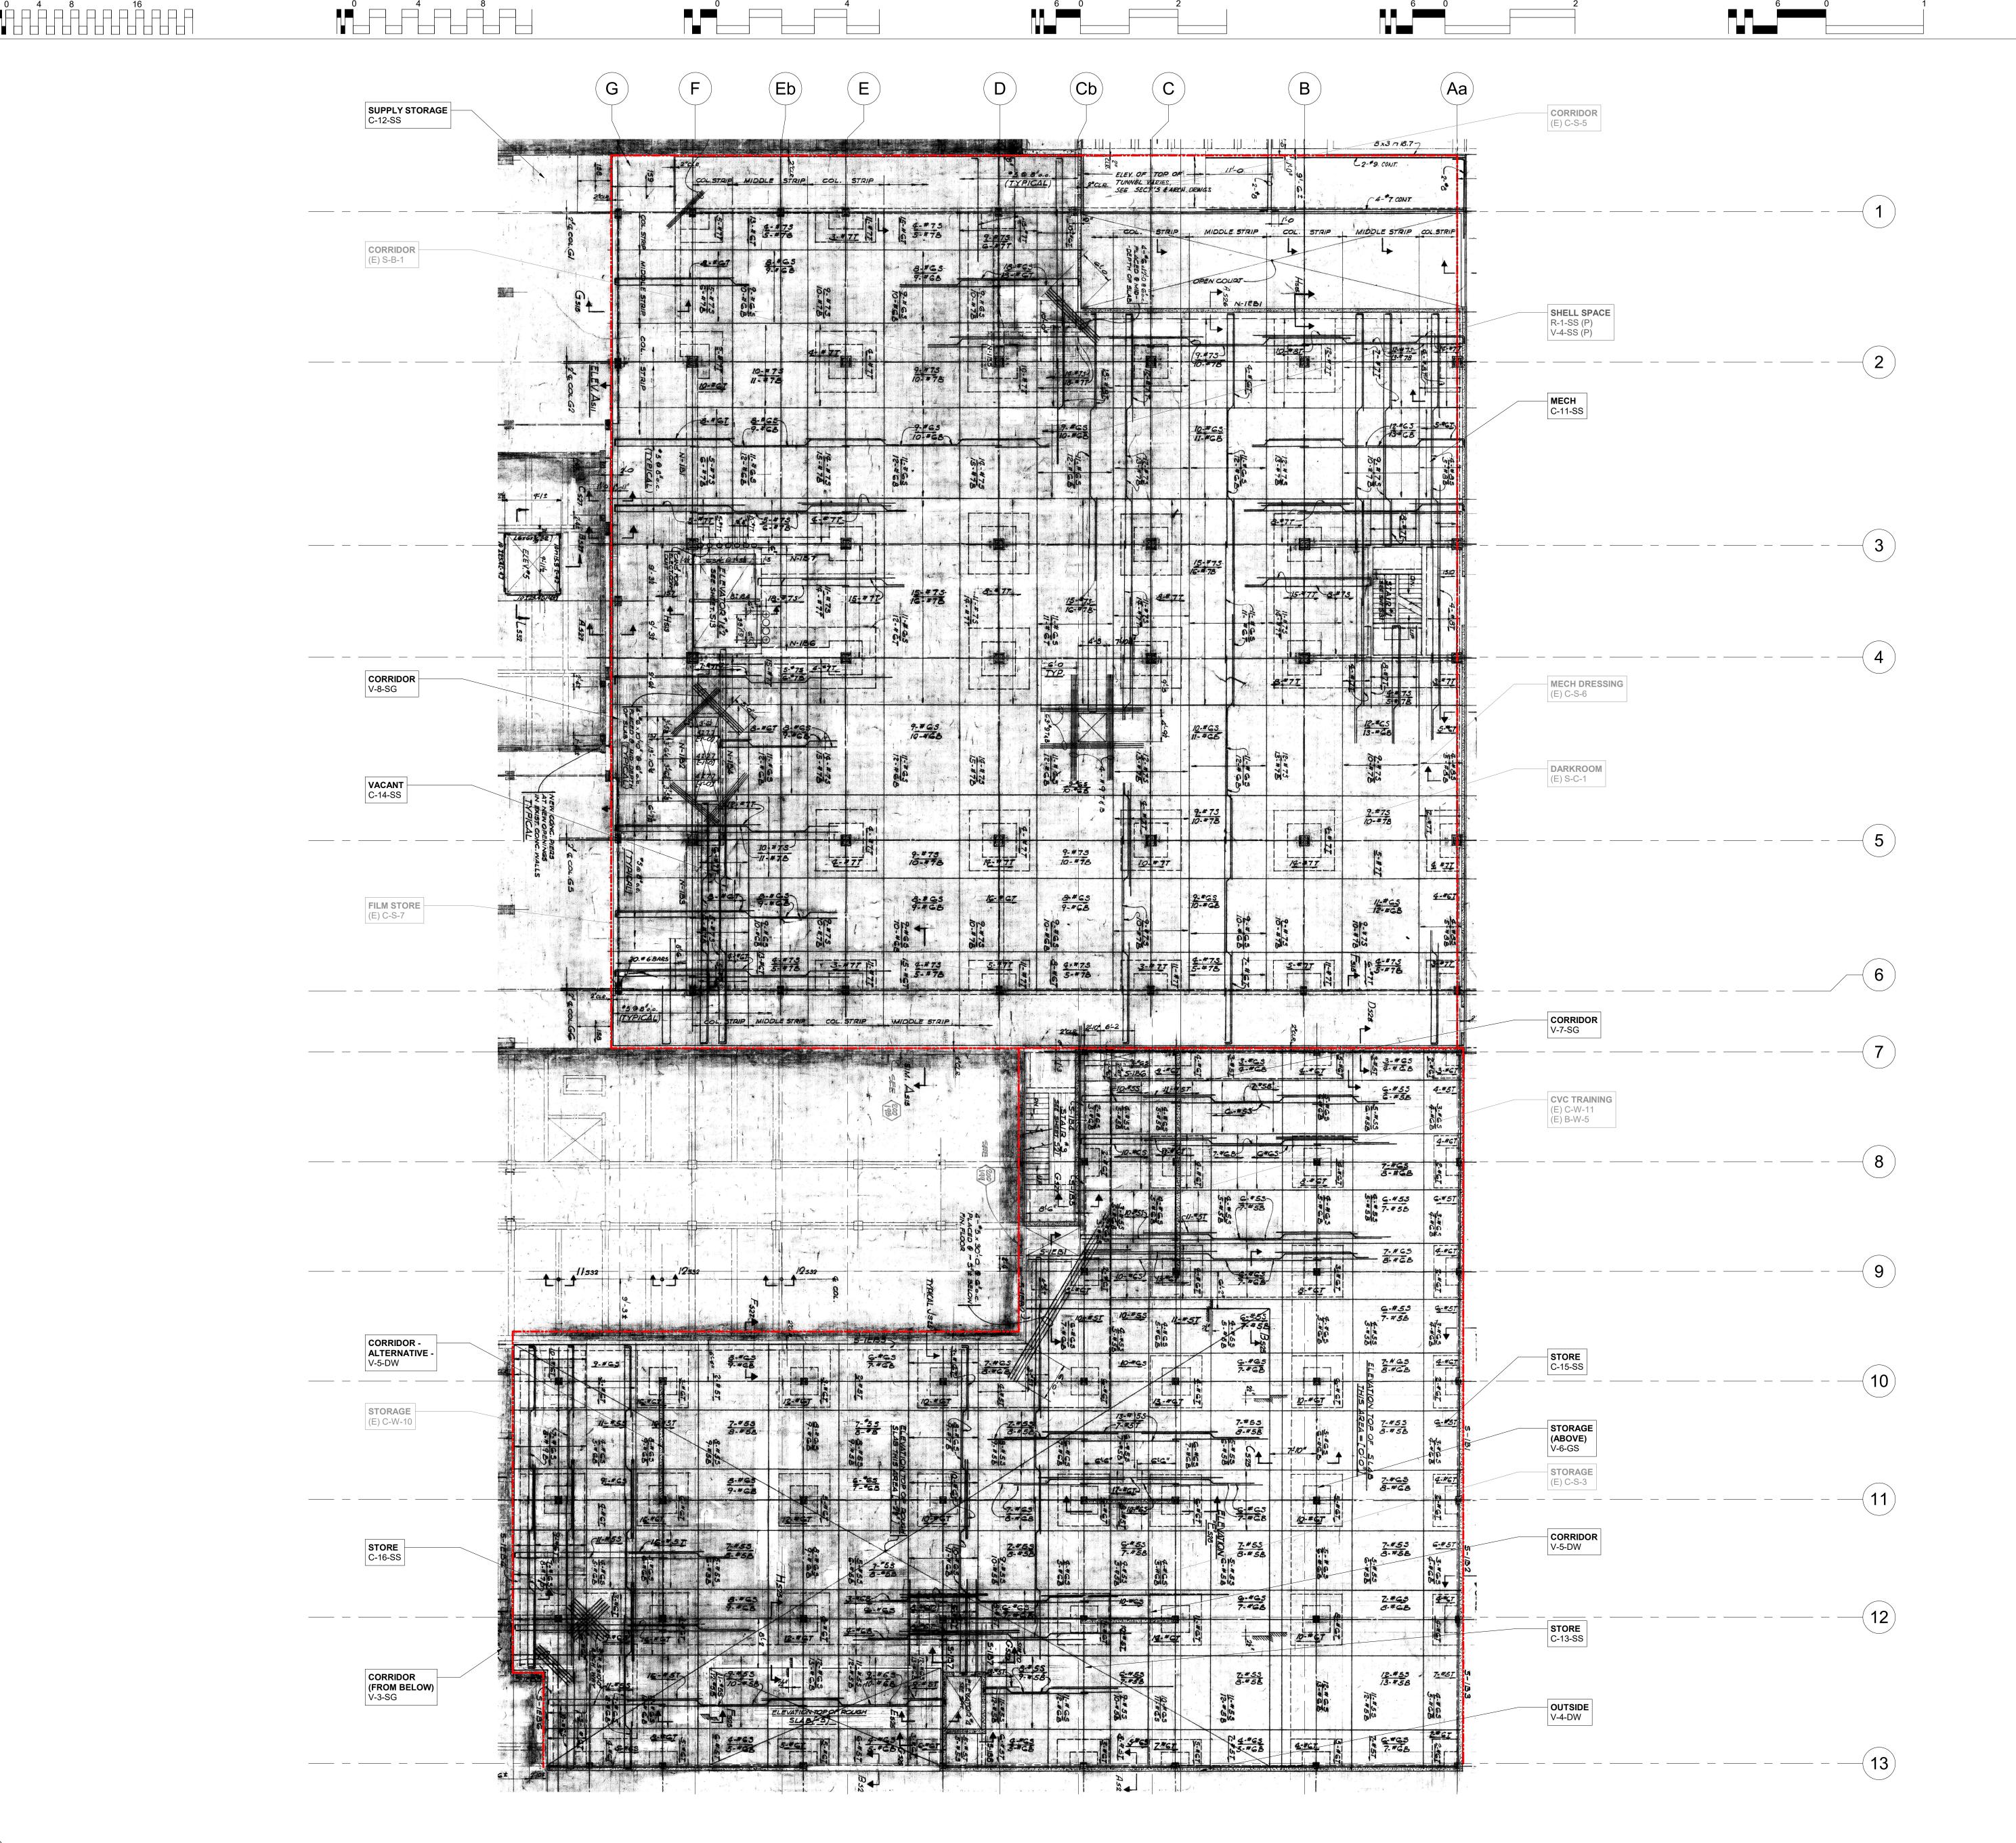

three-quarters inch = one foot

one inch = one foot

one and one-half inches = one foot

IF THIS DRAWING IS NOT 30inx42in IT IS A REDUCED PRINT; REFER TO GRAPHIC SCALE

OWNER:

three inches = one foot

**LEGEND** 

SEISMIC JOINT

PHASE 1 TESTING & VERIFICATION LOCATIONS

C-1-CW

PHASE 2 TESTING & VERIFICATION LOCATIONS

COMPLETED & APPROVED TEST LOCATIONS AS PART OF SPC-2 TESTING

(E) CC-W-1
COMPLETED TESTING AND

C-#-CW (P)

C CONCRETE CORE

R REINFORCING STEEL

S STRUCTURAL STEEL

SS STRUCTURAL SLAB
CW CONCRETE WALL

BM BEAM
CL COLUMN

RV RIVET

WM WELD METAL FND FOUNDATION

MD METAL DECK

CS COLUMN SPLICE

CB COLUMN BASE
SG SEISMIC GAP

VERIFICATION LOCATIONS
AS PART OF PARTIAL MTCAP (S2401101-34-00)

MATERIAL LEGEND

V VERIFICATION / OBSERVATION

ELEMENT/TYPE LEGEND

DW DIAPHRAGM-WALL CONNECTION

SW SLAB TO WALL CONNECTION

PPC PRECAST PANEL CONNECTION
GS GIRDER SPLICE

BW BEAM TO WALL CONNECTION
BLT BOLT

MC MOMENT CONNECTION

C-#-CW (ALT)

MATERIAL — SAMPLE NUMBER - ELEMENT/TYPE —





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AUTHORITY HAVING JURISDICTION'S PROJECT NO. S251130-34-00 FACILITY NUMBER

AGENCY APPROVALS:

REVIEWED IN ACCORDANCE WITH THE REQUIREMENTS OF T24, CCR

APPROVED

Department of Health Care Access and Information

Office of Statewide Hospital Planning and Development 9/11/2025, 8:01:54 AM S251130-34-00 Donald Harris

oject:

UCDH MEDICAL CENTER

EAST WING TOWER &

EAST WING RADIOLOGY

MTCAP

Sheet Title:

1ST FLOOR PLAN

Scale:	As indicated
Job Number:	C2953022.05
Drawn by:	GG
Design by:	ASH
Checked by:	MGA
Date:	07/10/2025

Drawing Numbe


S301

Sheets

1 FIRST FLOOR PLAN

one-quarter inch = one foot

one-eighth inch = one foot

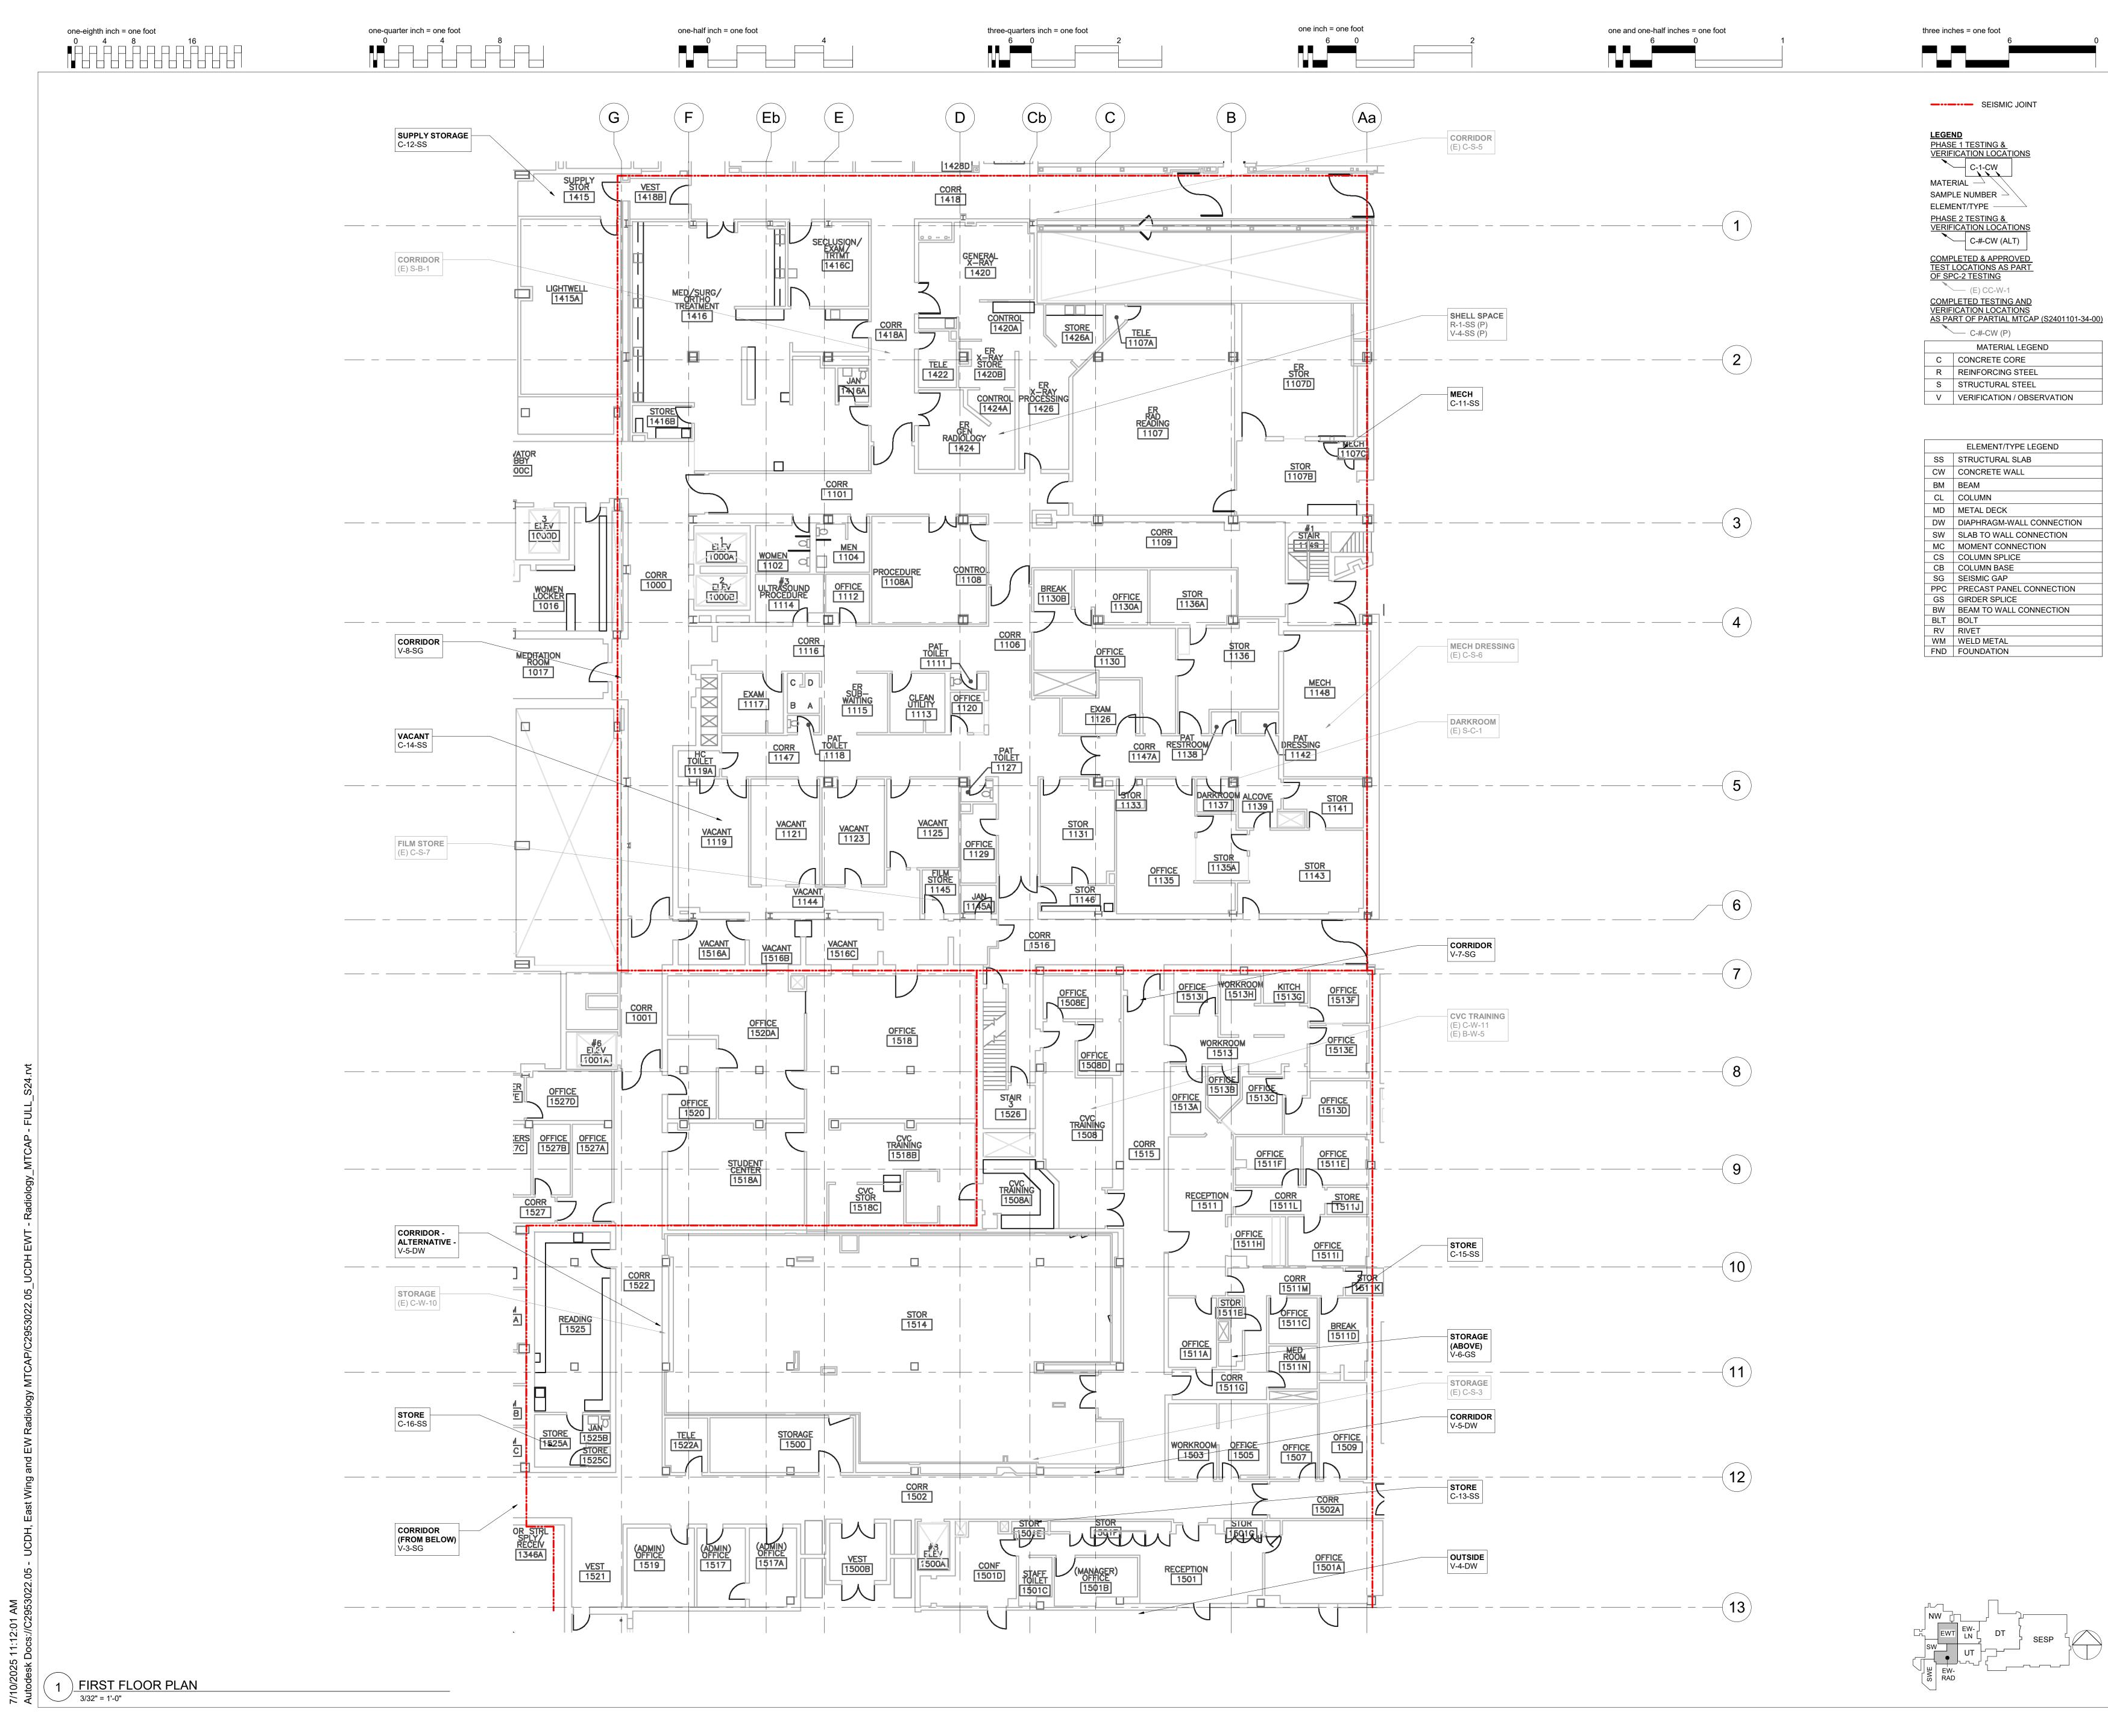

MATERIAL LEGEND

ELEMENT/TYPE LEGEND

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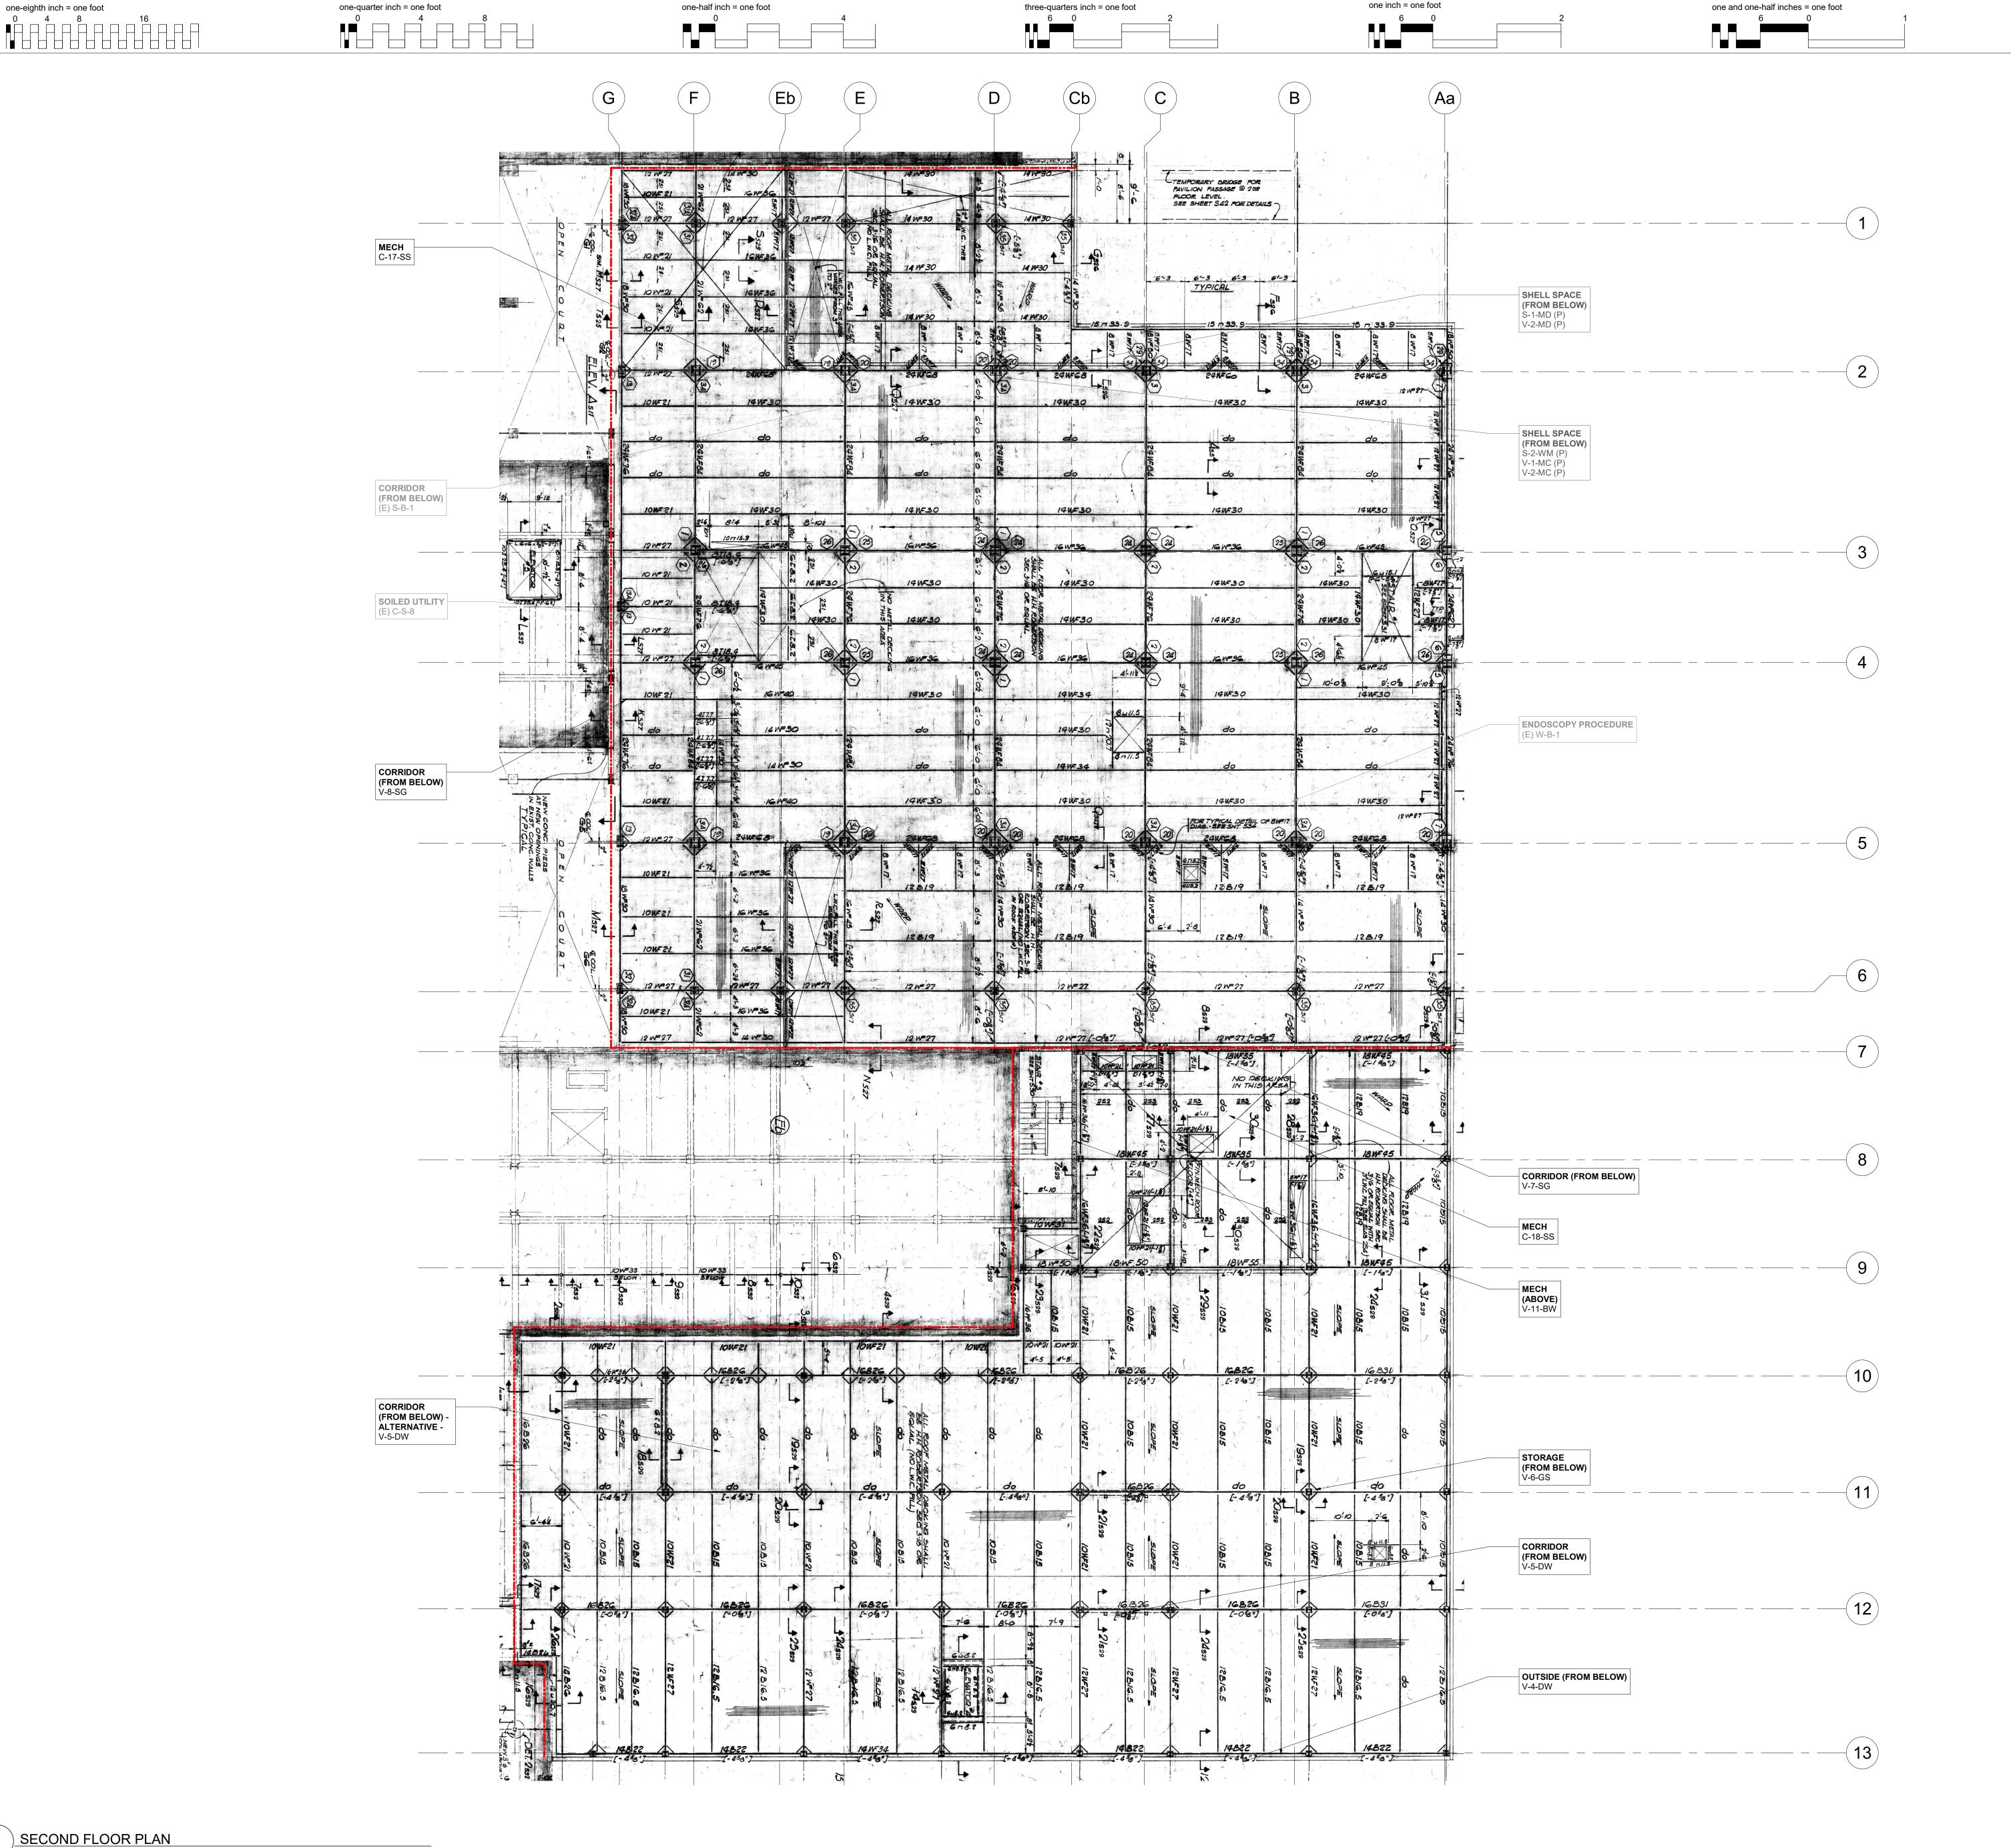


UCDH MEDICAL CENTER EAST WING TOWER & EAST WING RADIOLOGY MTCAP

Sheet Title:

1ST FLOOR ARCHITECTURAL PLAN

Scale:	As indicated
Job Number:	C2953022.05
Drawn by:	GG
Design by:	ASH
Checked by:	MGA
Date:	07/10/2025
Drawin a Number	



OWNER:

three inches = one foot

**LEGEND** 

MATERIAL —

SAMPLE NUMBER ELEMENT/TYPE -

SEISMIC JOINT

PHASE 1 TESTING & VERIFICATION LOCATIONS

C-1-CW

PHASE 2 TESTING & VERIFICATION LOCATIONS

COMPLETED & APPROVED TEST LOCATIONS AS PART OF SPC-2 TESTING

(E) CC-W-1

COMPLETED TESTING AND

VERIFICATION LOCATIONS

C-#-CW (P)

C | CONCRETE CORE R REINFORCING STEEL

S STRUCTURAL STEEL

SS STRUCTURAL SLAB

CW CONCRETE WALL

MD METAL DECK

CS COLUMN SPLICE

CB COLUMN BASE

SG SEISMIC GAP

RV RIVET
WM WELD METAL
FND FOUNDATION

BM BEAM CL COLUMN

AS PART OF PARTIAL MTCAP (S2401101-34-00)

MATERIAL LEGEND

V VERIFICATION / OBSERVATION

ELEMENT/TYPE LEGEND

DW DIAPHRAGM-WALL CONNECTION

SW SLAB TO WALL CONNECTION

PPC PRECAST PANEL CONNECTION
GS GIRDER SPLICE

BW BEAM TO WALL CONNECTION
BLT BOLT

MC MOMENT CONNECTION

C-#-CW (ALT)





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UCDH MEDICAL CENTER EAST WING TOWER & EAST WING RADIOLOGY

MTCAP

Sheet Title:

2ND FLOOR PLAN

Scale:	As indicated
Job Number:	C2953022.05
Drawn by:	GG
Design by:	ASH
Checked by:	MGA
Date:	07/10/2025
Drawing Number:	

Drawing Number:



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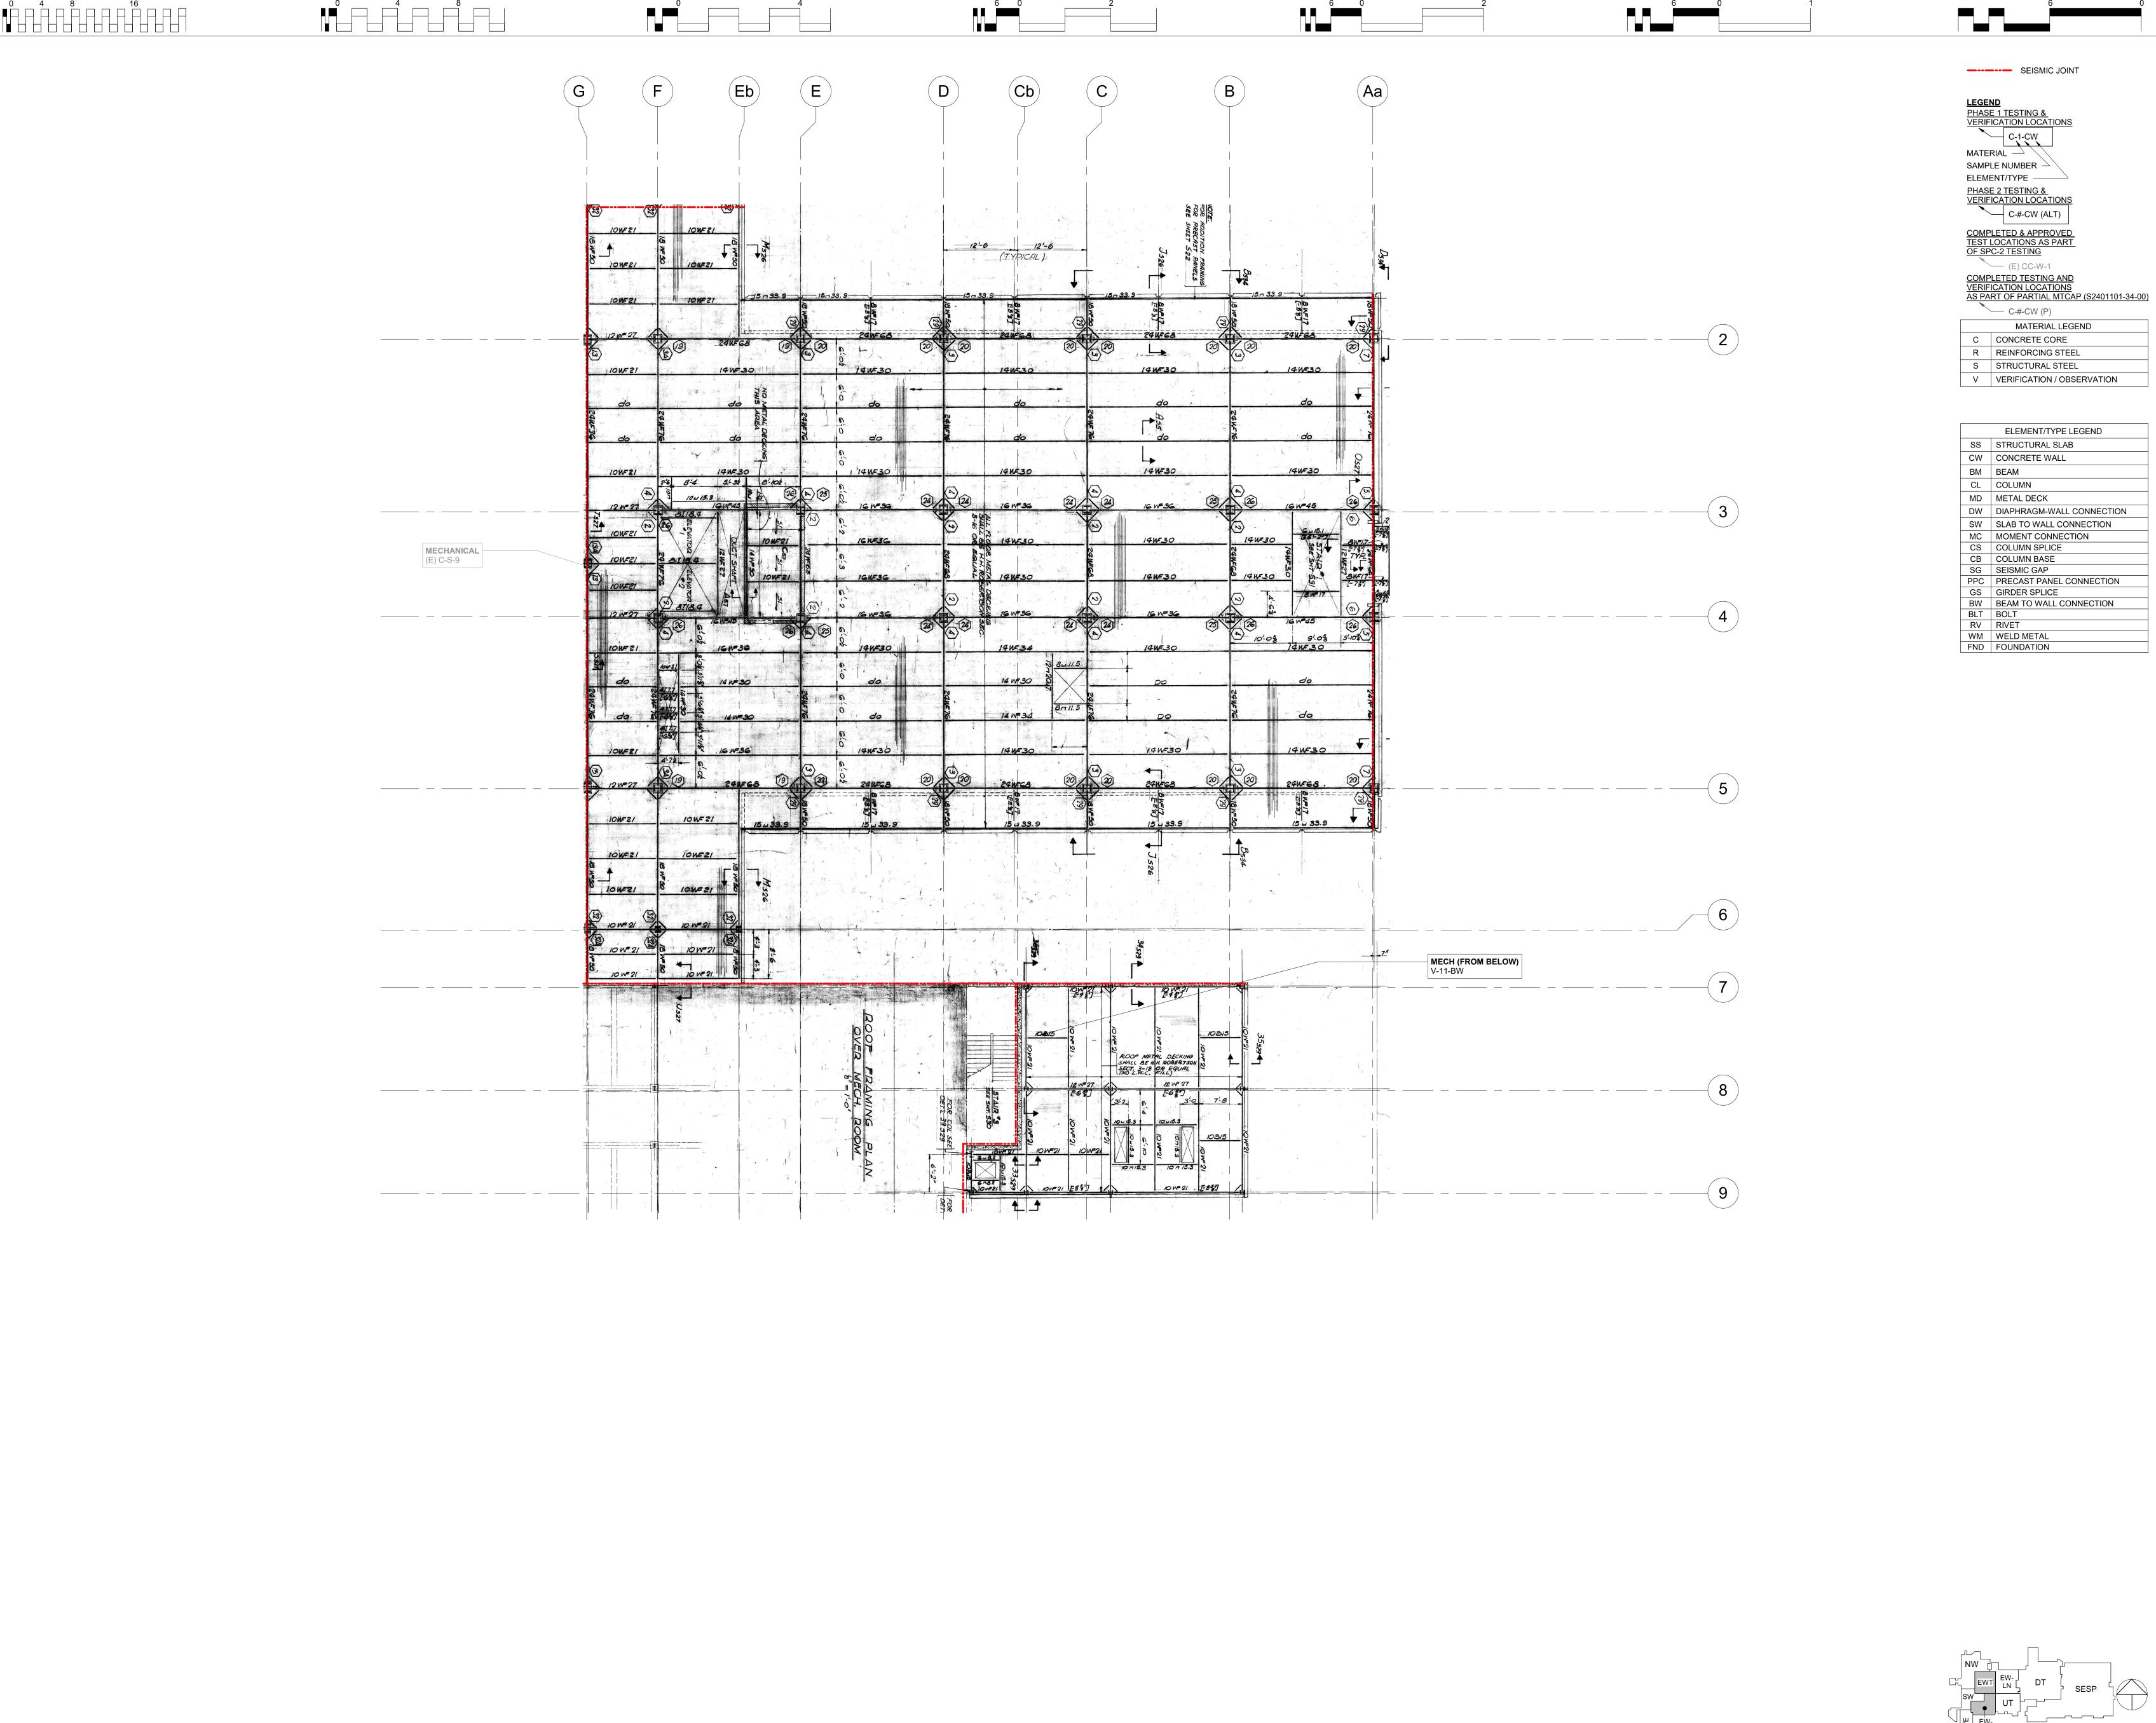


UCDH MEDICAL CENTER EAST WING TOWER & EAST WING RADIOLOGY MTCAP

Sheet Title:

2ND FLOOR ARCHITECTURAL PLAN

Scale:	As indicated	
Job Number:	C2953022.05	
Drawn by:	GG	
Design by:	ASH	
Checked by:	MGA	
Date:	07/10/2025	
Drawing Musehers		



three-quarters inch = one foot

one-quarter inch = one foot

one-eighth inch = one foot

one-half inch = one foot

one inch = one foot

one and one-half inches = one foot

IF THIS DRAWING IS NOT 30inx42in IT IS A REDUCED REFER TO GRAPHIC SCALE

OWNER:

three inches = one foot

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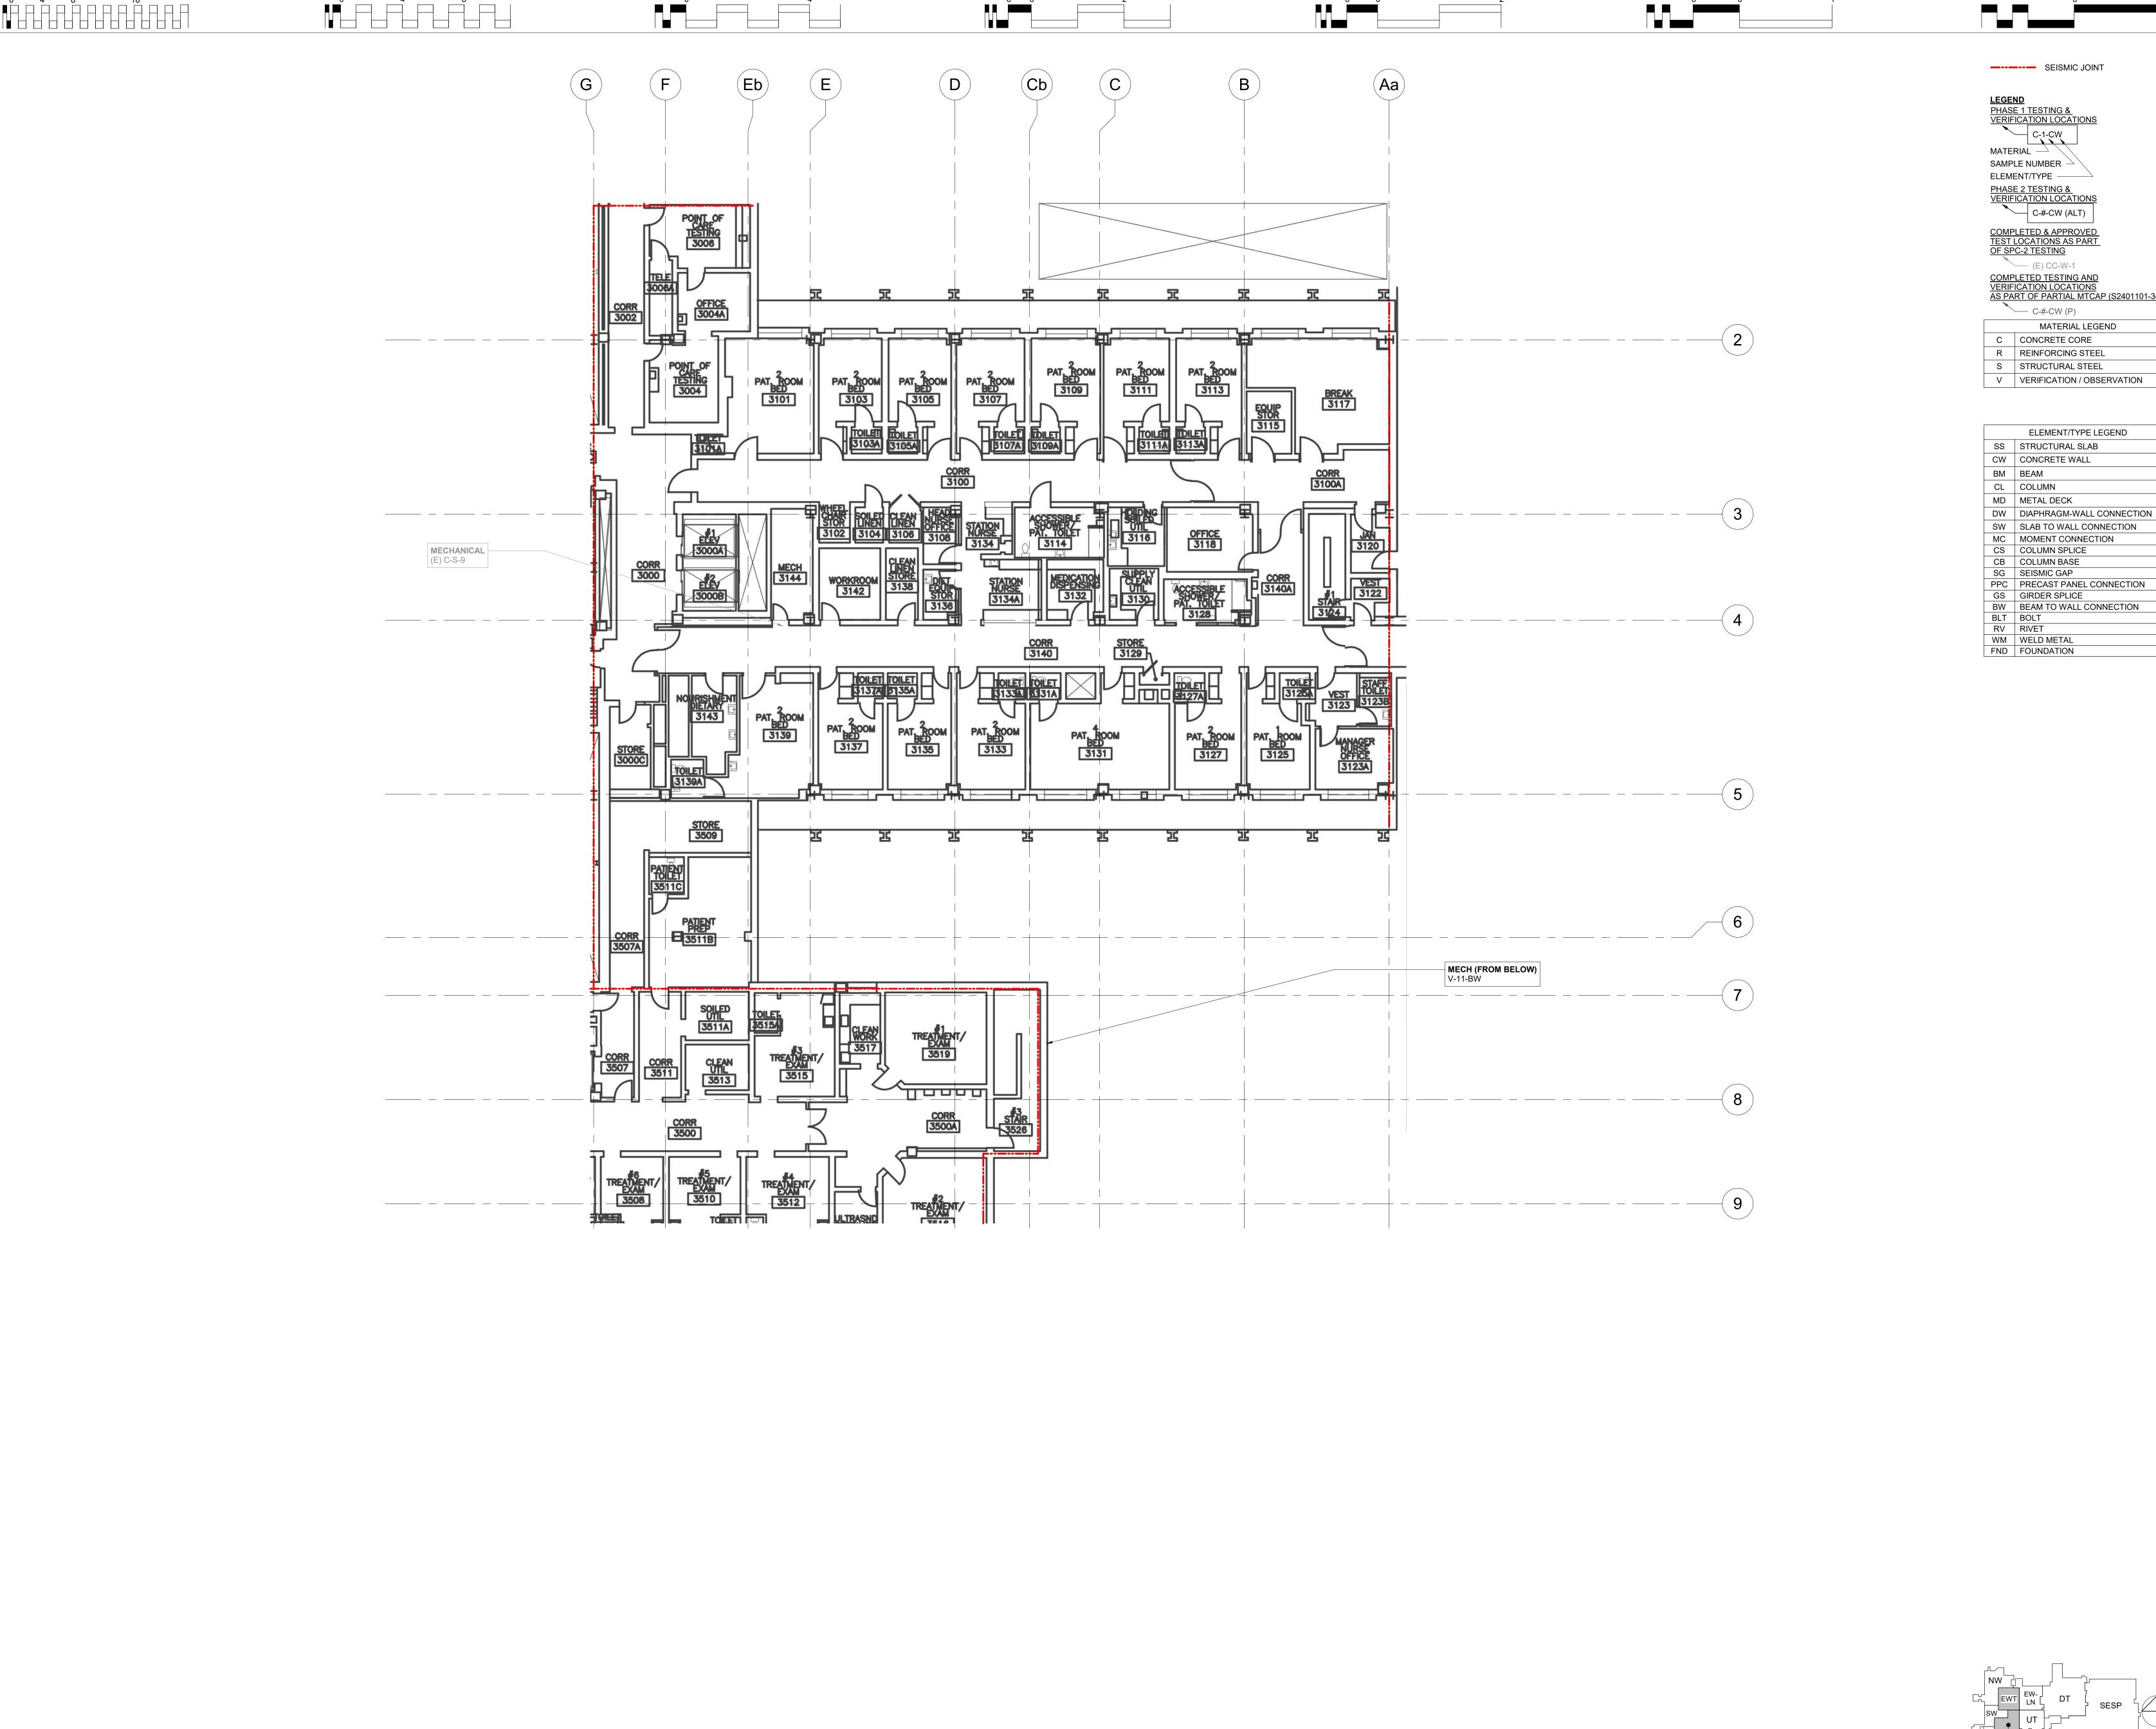
**UCDH MEDICAL CENTER** EAST WING TOWER & **EAST WING RADIOLOGY** MTCAP

Sheet Title:

3RD FLOOR PLAN

Scale:	As indicated
Job Number:	C2953022.05
Drawn by:	GG
Design by:	ASH
Checked by:	MGA
Date:	07/10/2025
Drawing Number:	

**S303** 



three-quarters inch = one foot

one-quarter inch = one foot

one-eighth inch = one foot

one-half inch = one foot

one inch = one foot

one and one-half inches = one foot

IF THIS DRAWING IS NOT 30inx42in IT IS A REDUCED REFER TO GRAPHIC SCALE

COMPLETED TESTING AND
VERIFICATION LOCATIONS
AS PART OF PARTIAL MTCAP (S2401101-34-00)

three inches = one foot

DW DIAPHRAGM-WALL CONNECTION SW SLAB TO WALL CONNECTION

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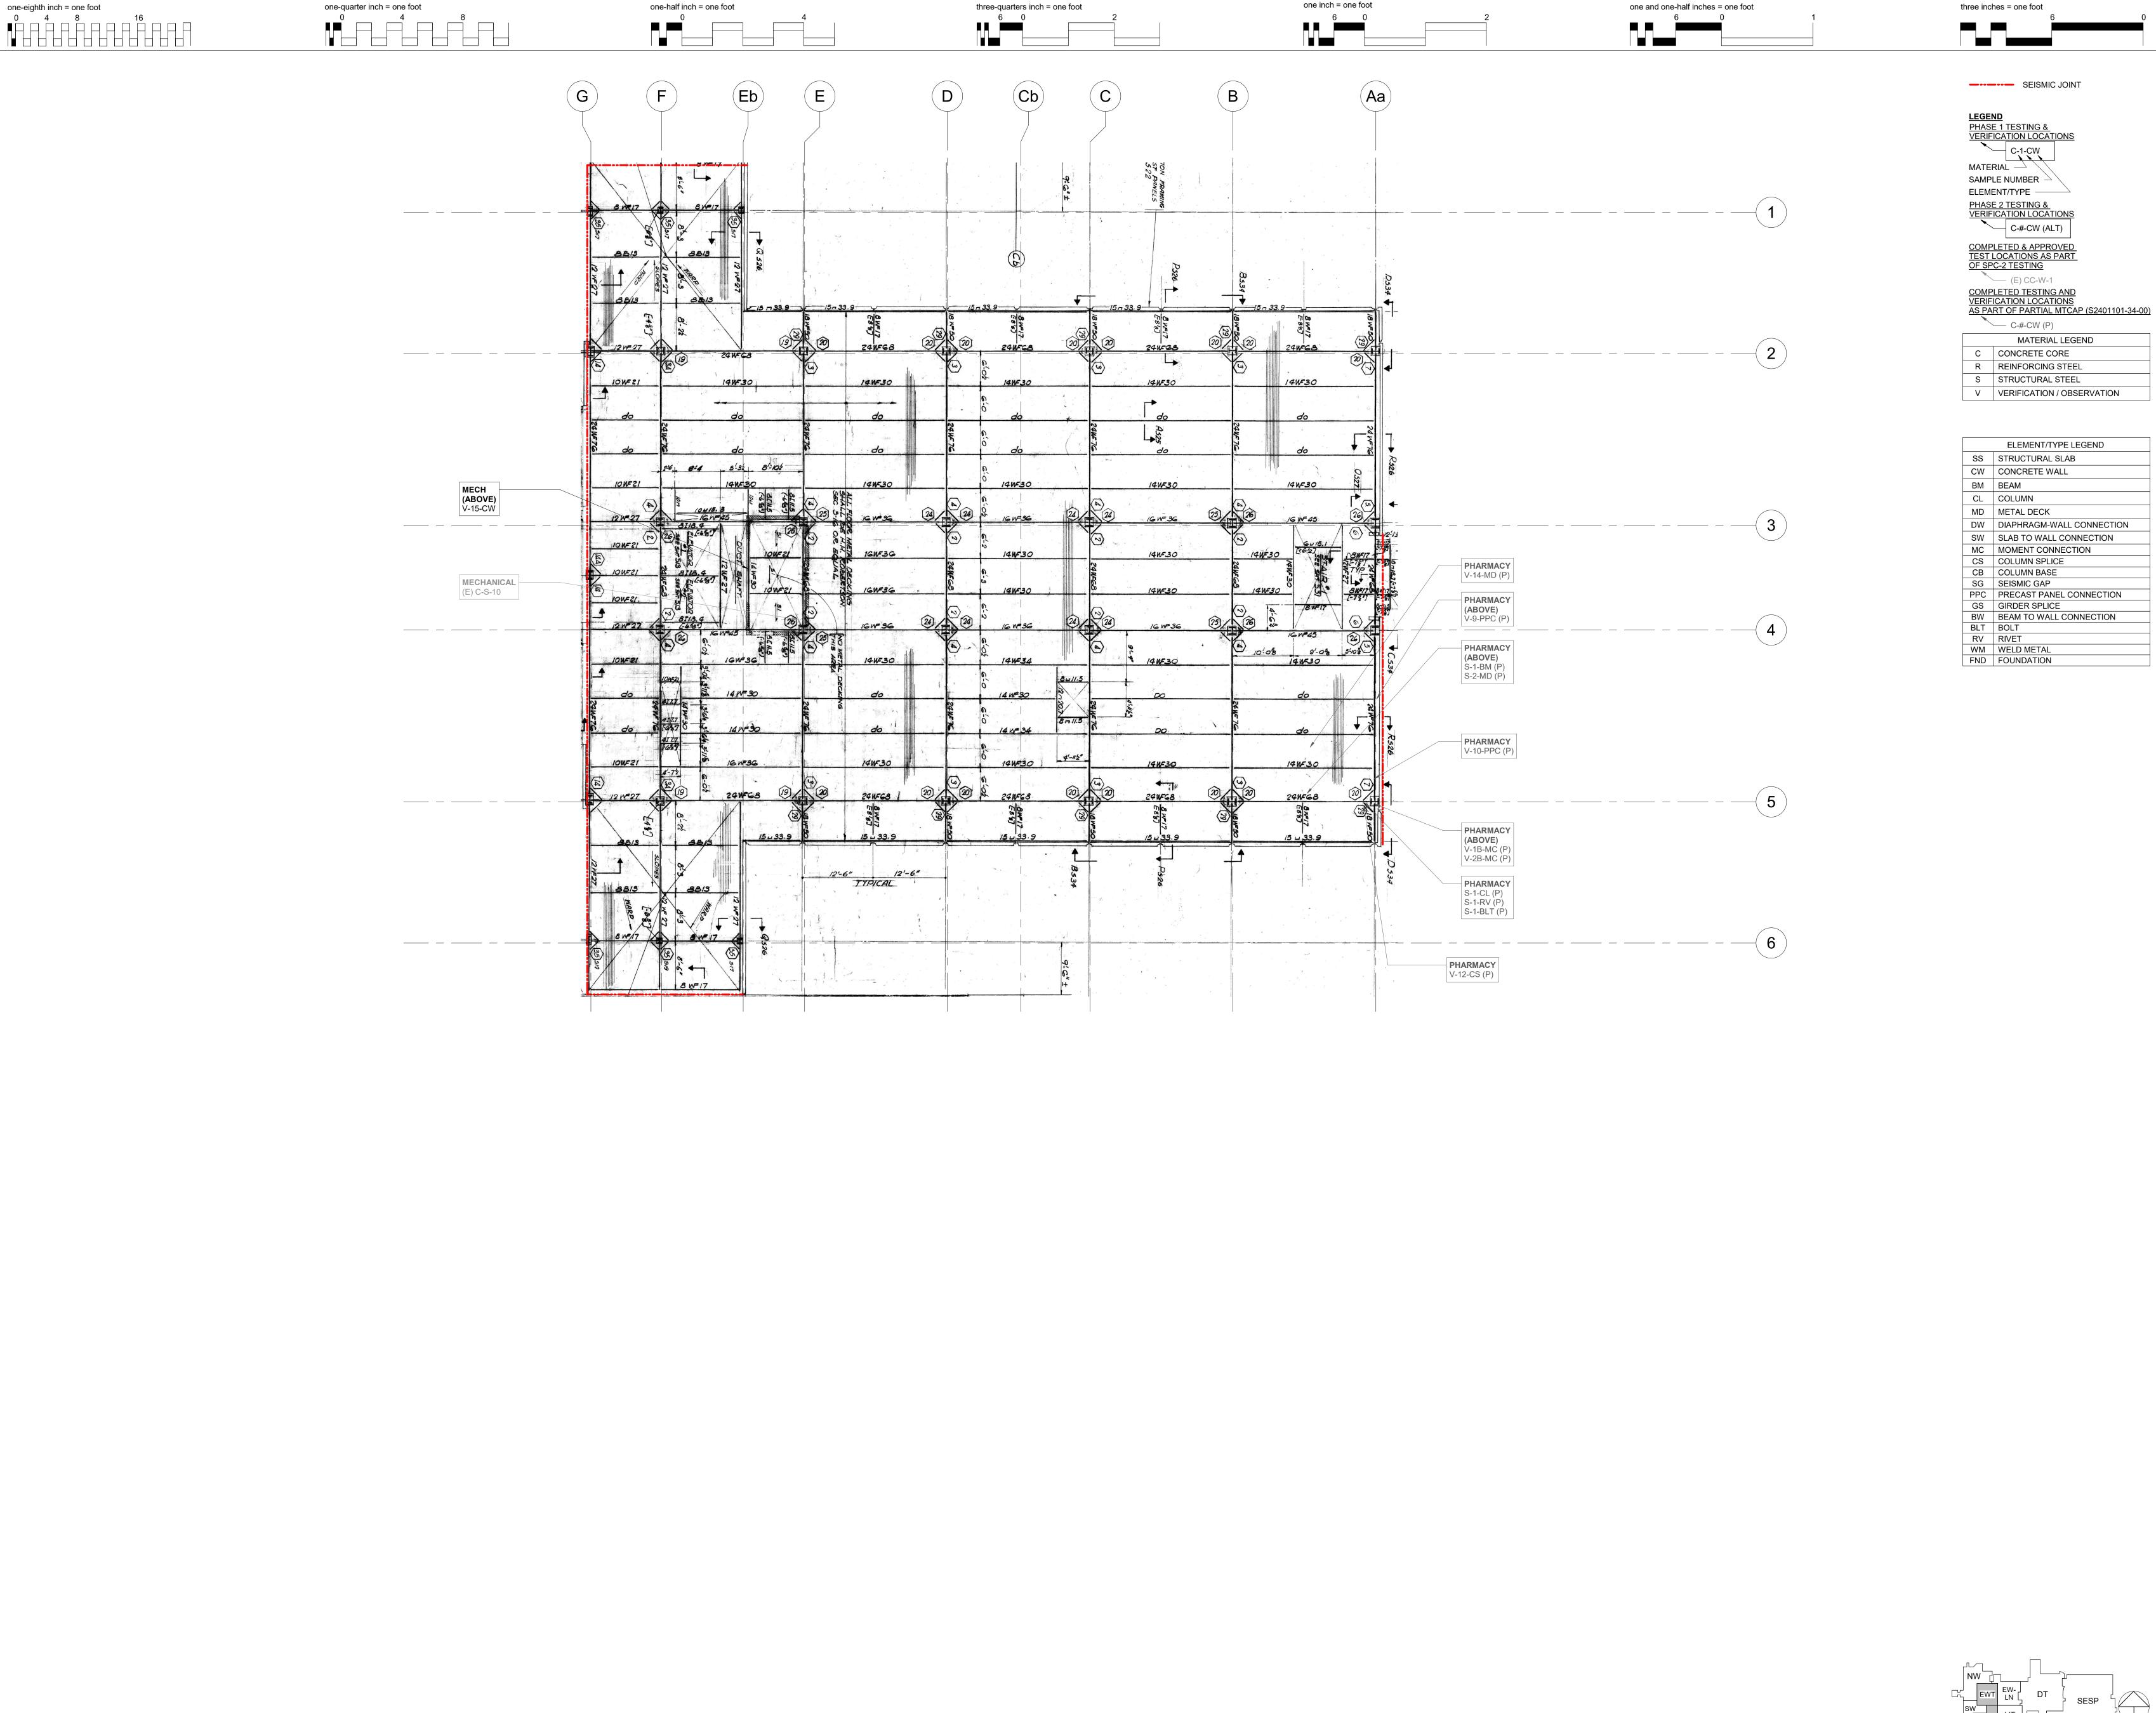
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Sheet Title:

3RD FLOOR ARCHITECTURAL PLAN

Scale:	As indicated
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FOURTH FLOOR PLAN
3/32" = 1'-0"

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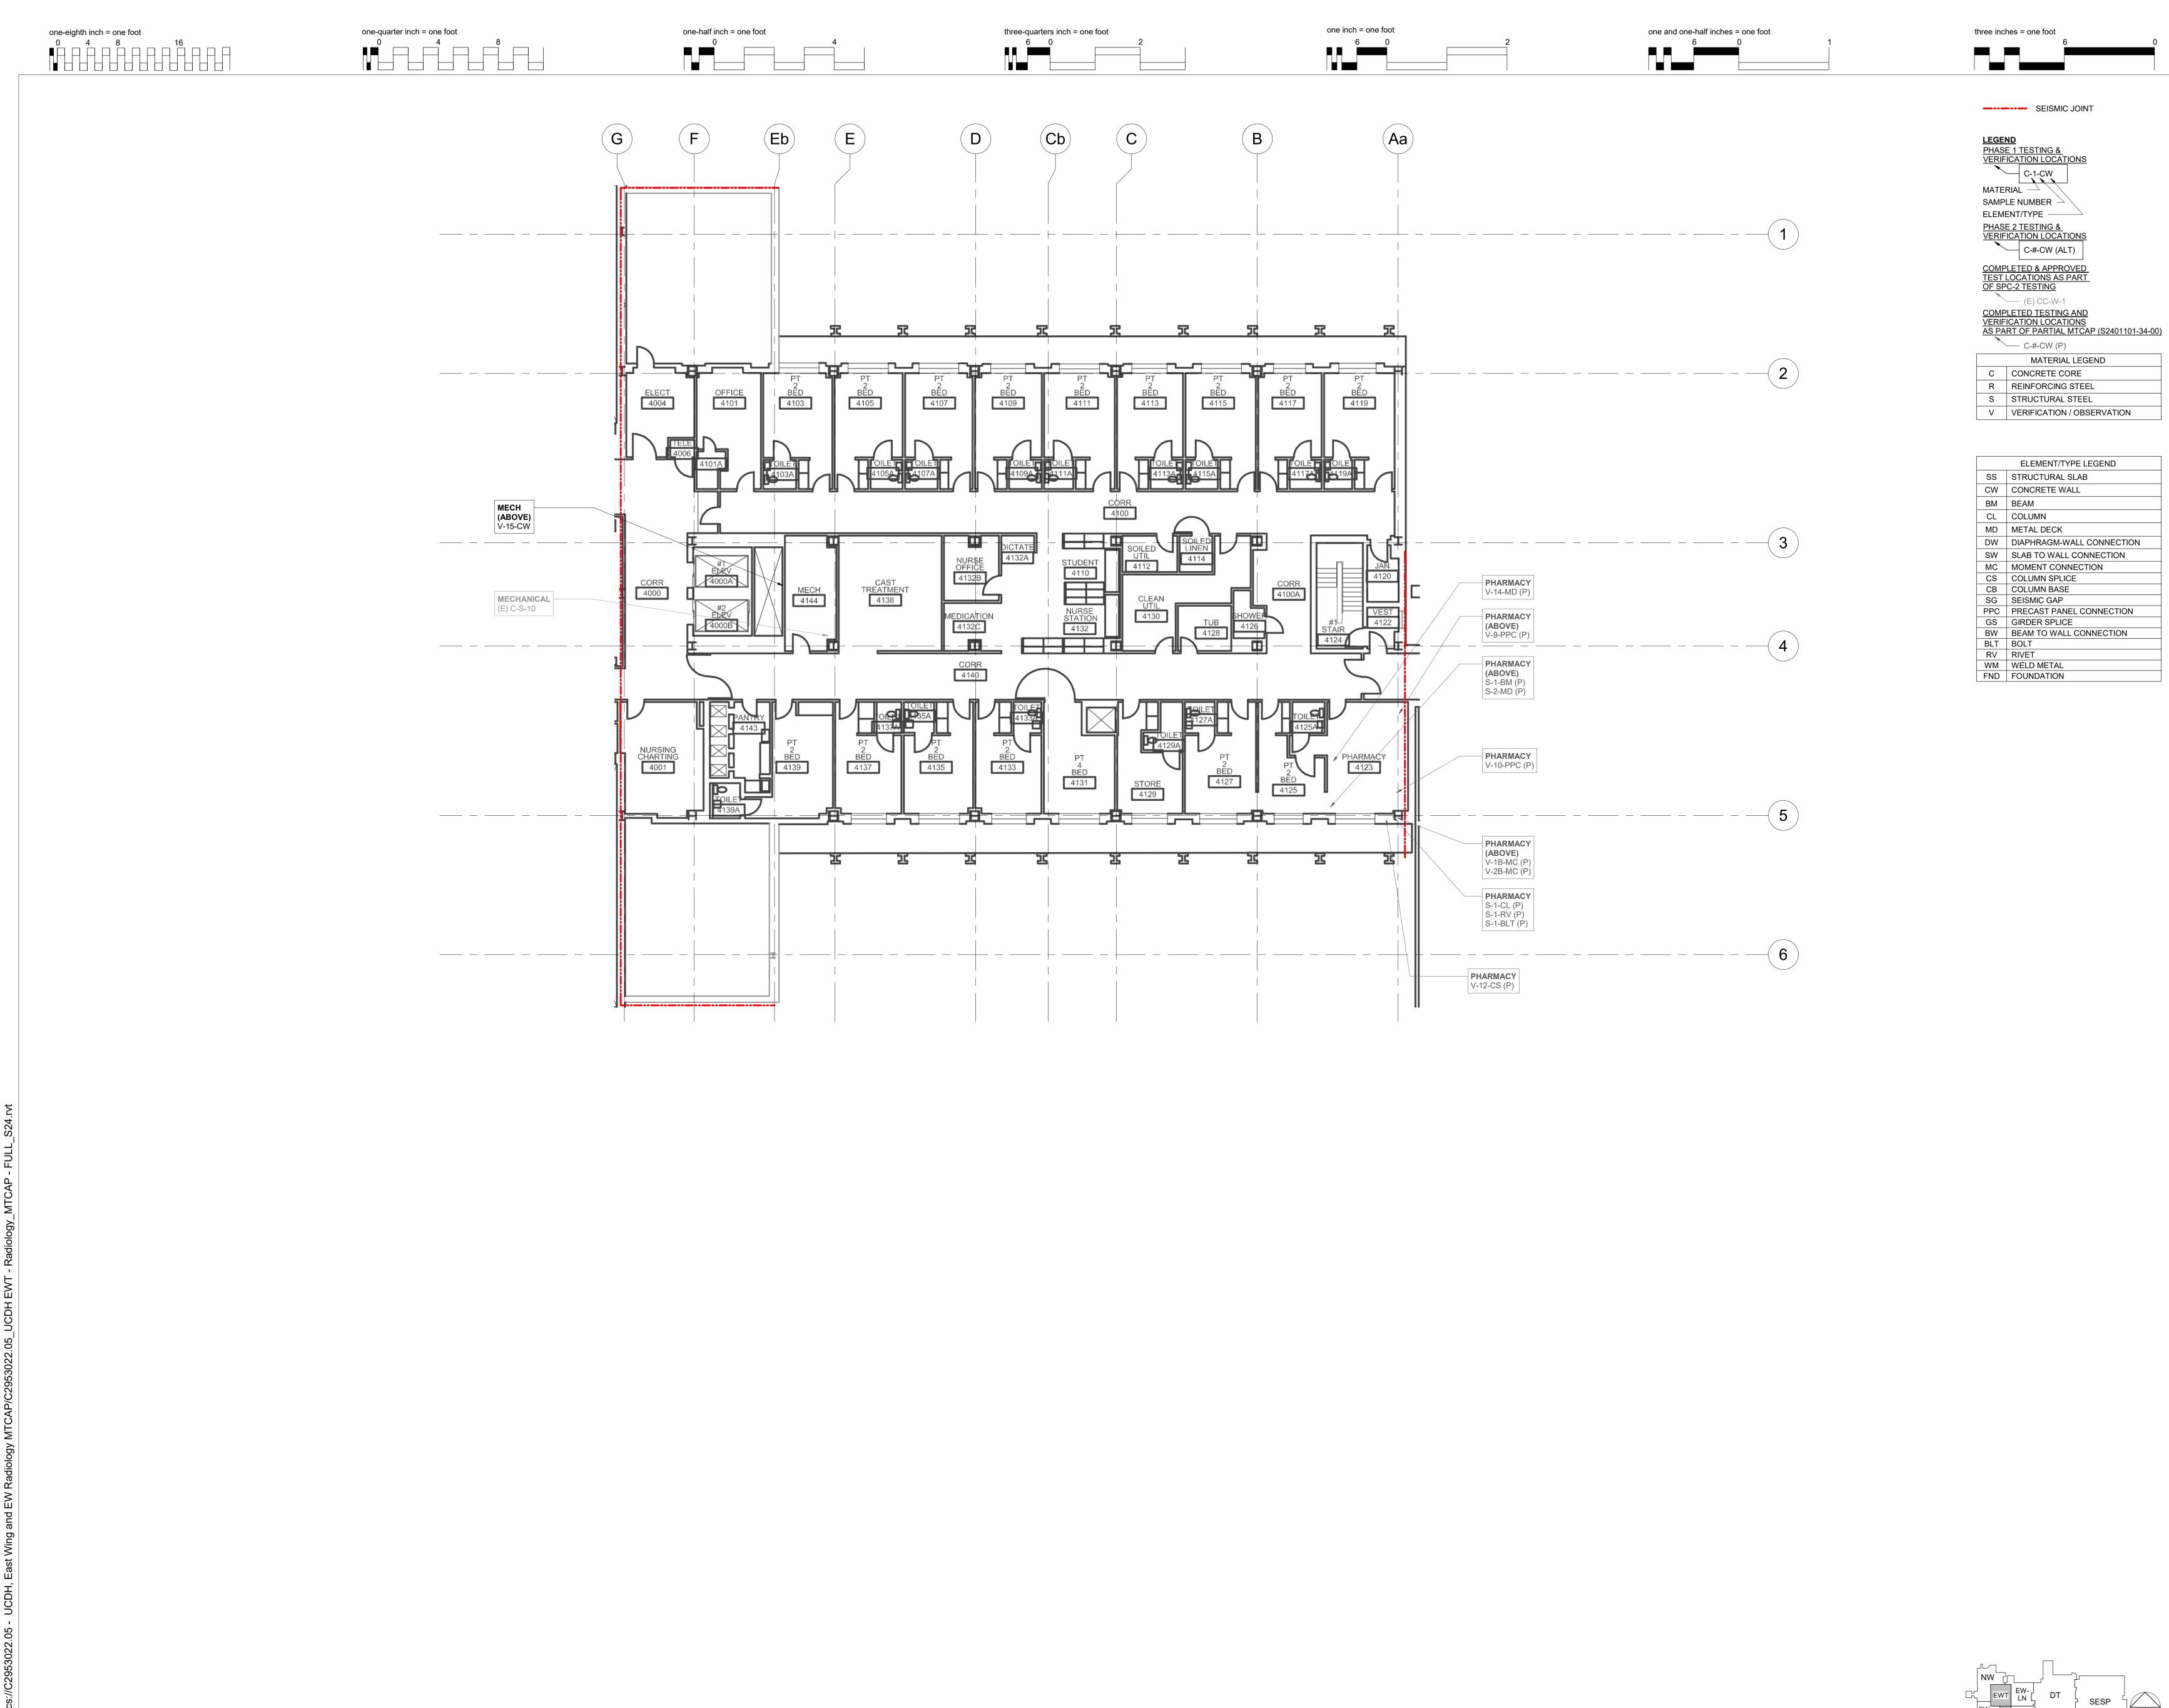


UCDH MEDICAL CENTER EAST WING TOWER & EAST WING RADIOLOGY MTCAP

Sheet Title:

4TH FLOOR PLAN

Scale:	As indicated
Job Number:	C2953022.05
Drawn by:	GG
Design by:	ASH
Checked by:	MGA
Date:	07/10/2025
Drawing Number:	



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UCDH MEDICAL CENTER EAST WING TOWER & EAST WING RADIOLOGY


MTCAP

Sheet Title:

4TH FLOOR ARCHITECTURAL PLAN

Scale:	As indicated
Job Number:	C2953022.05
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Design by:	ASH
Checked by:	MGA
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FOURTH FLOOR PLAN
3/32" = 1'-0"

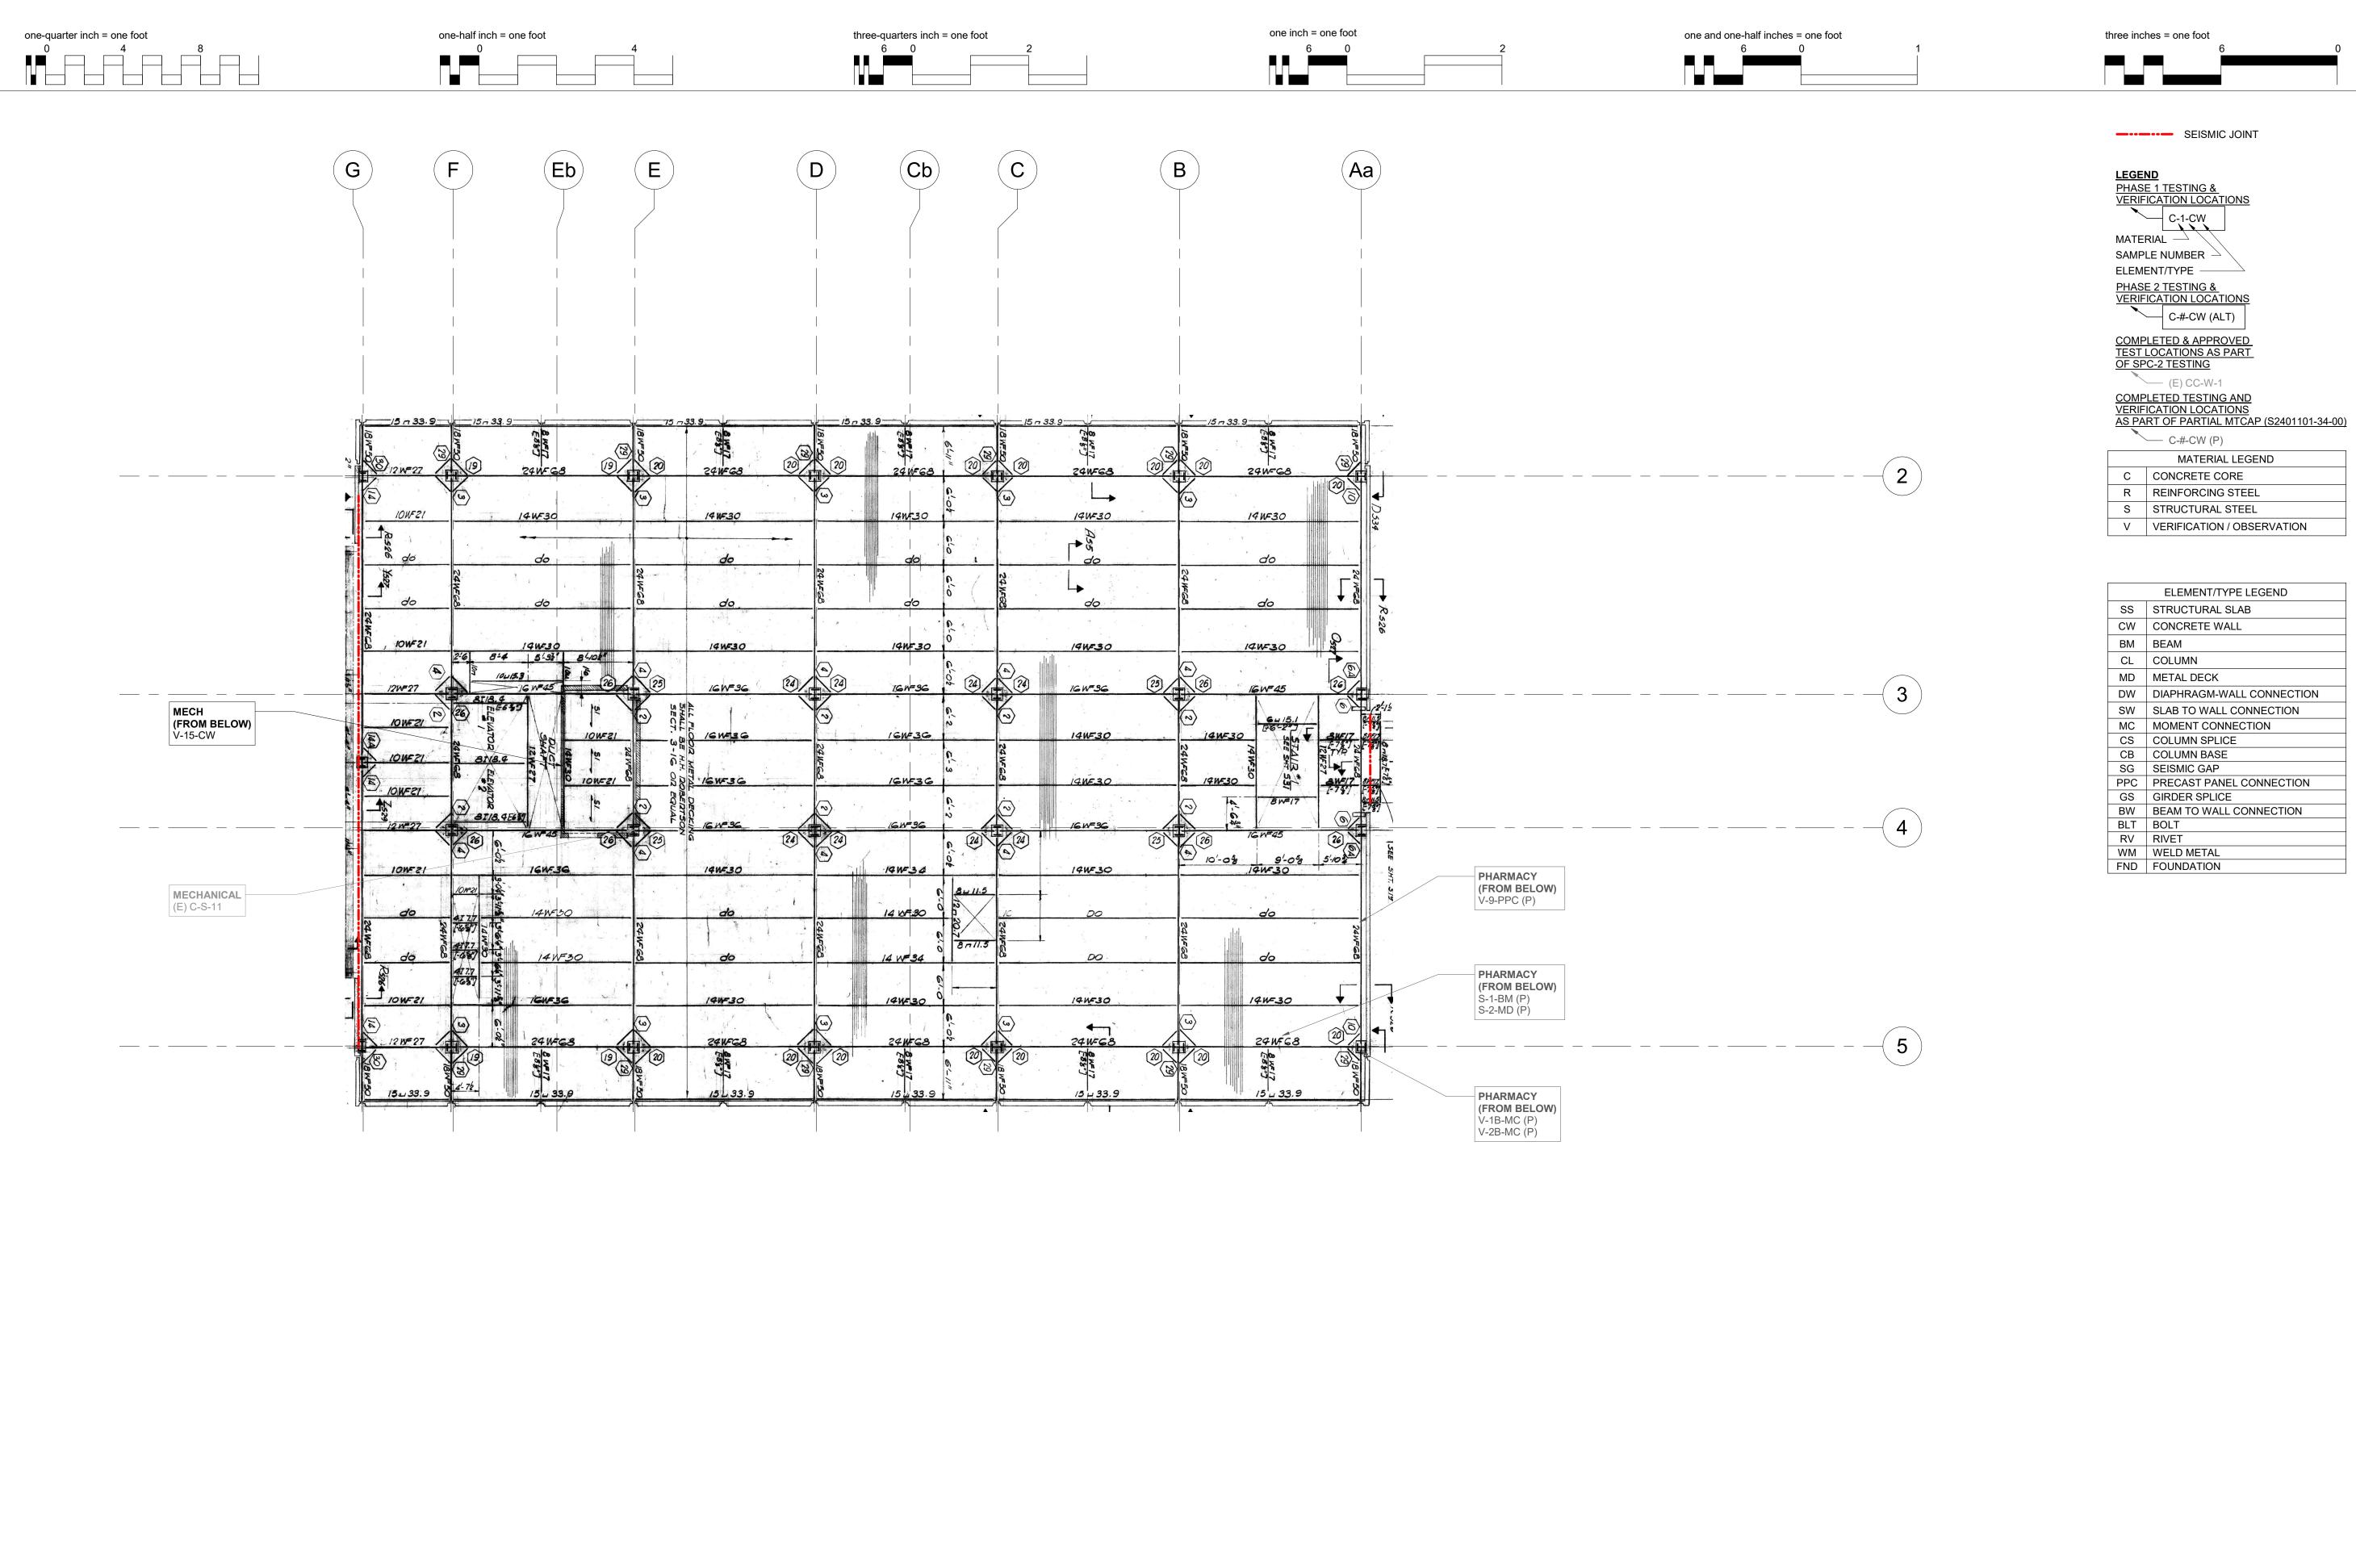

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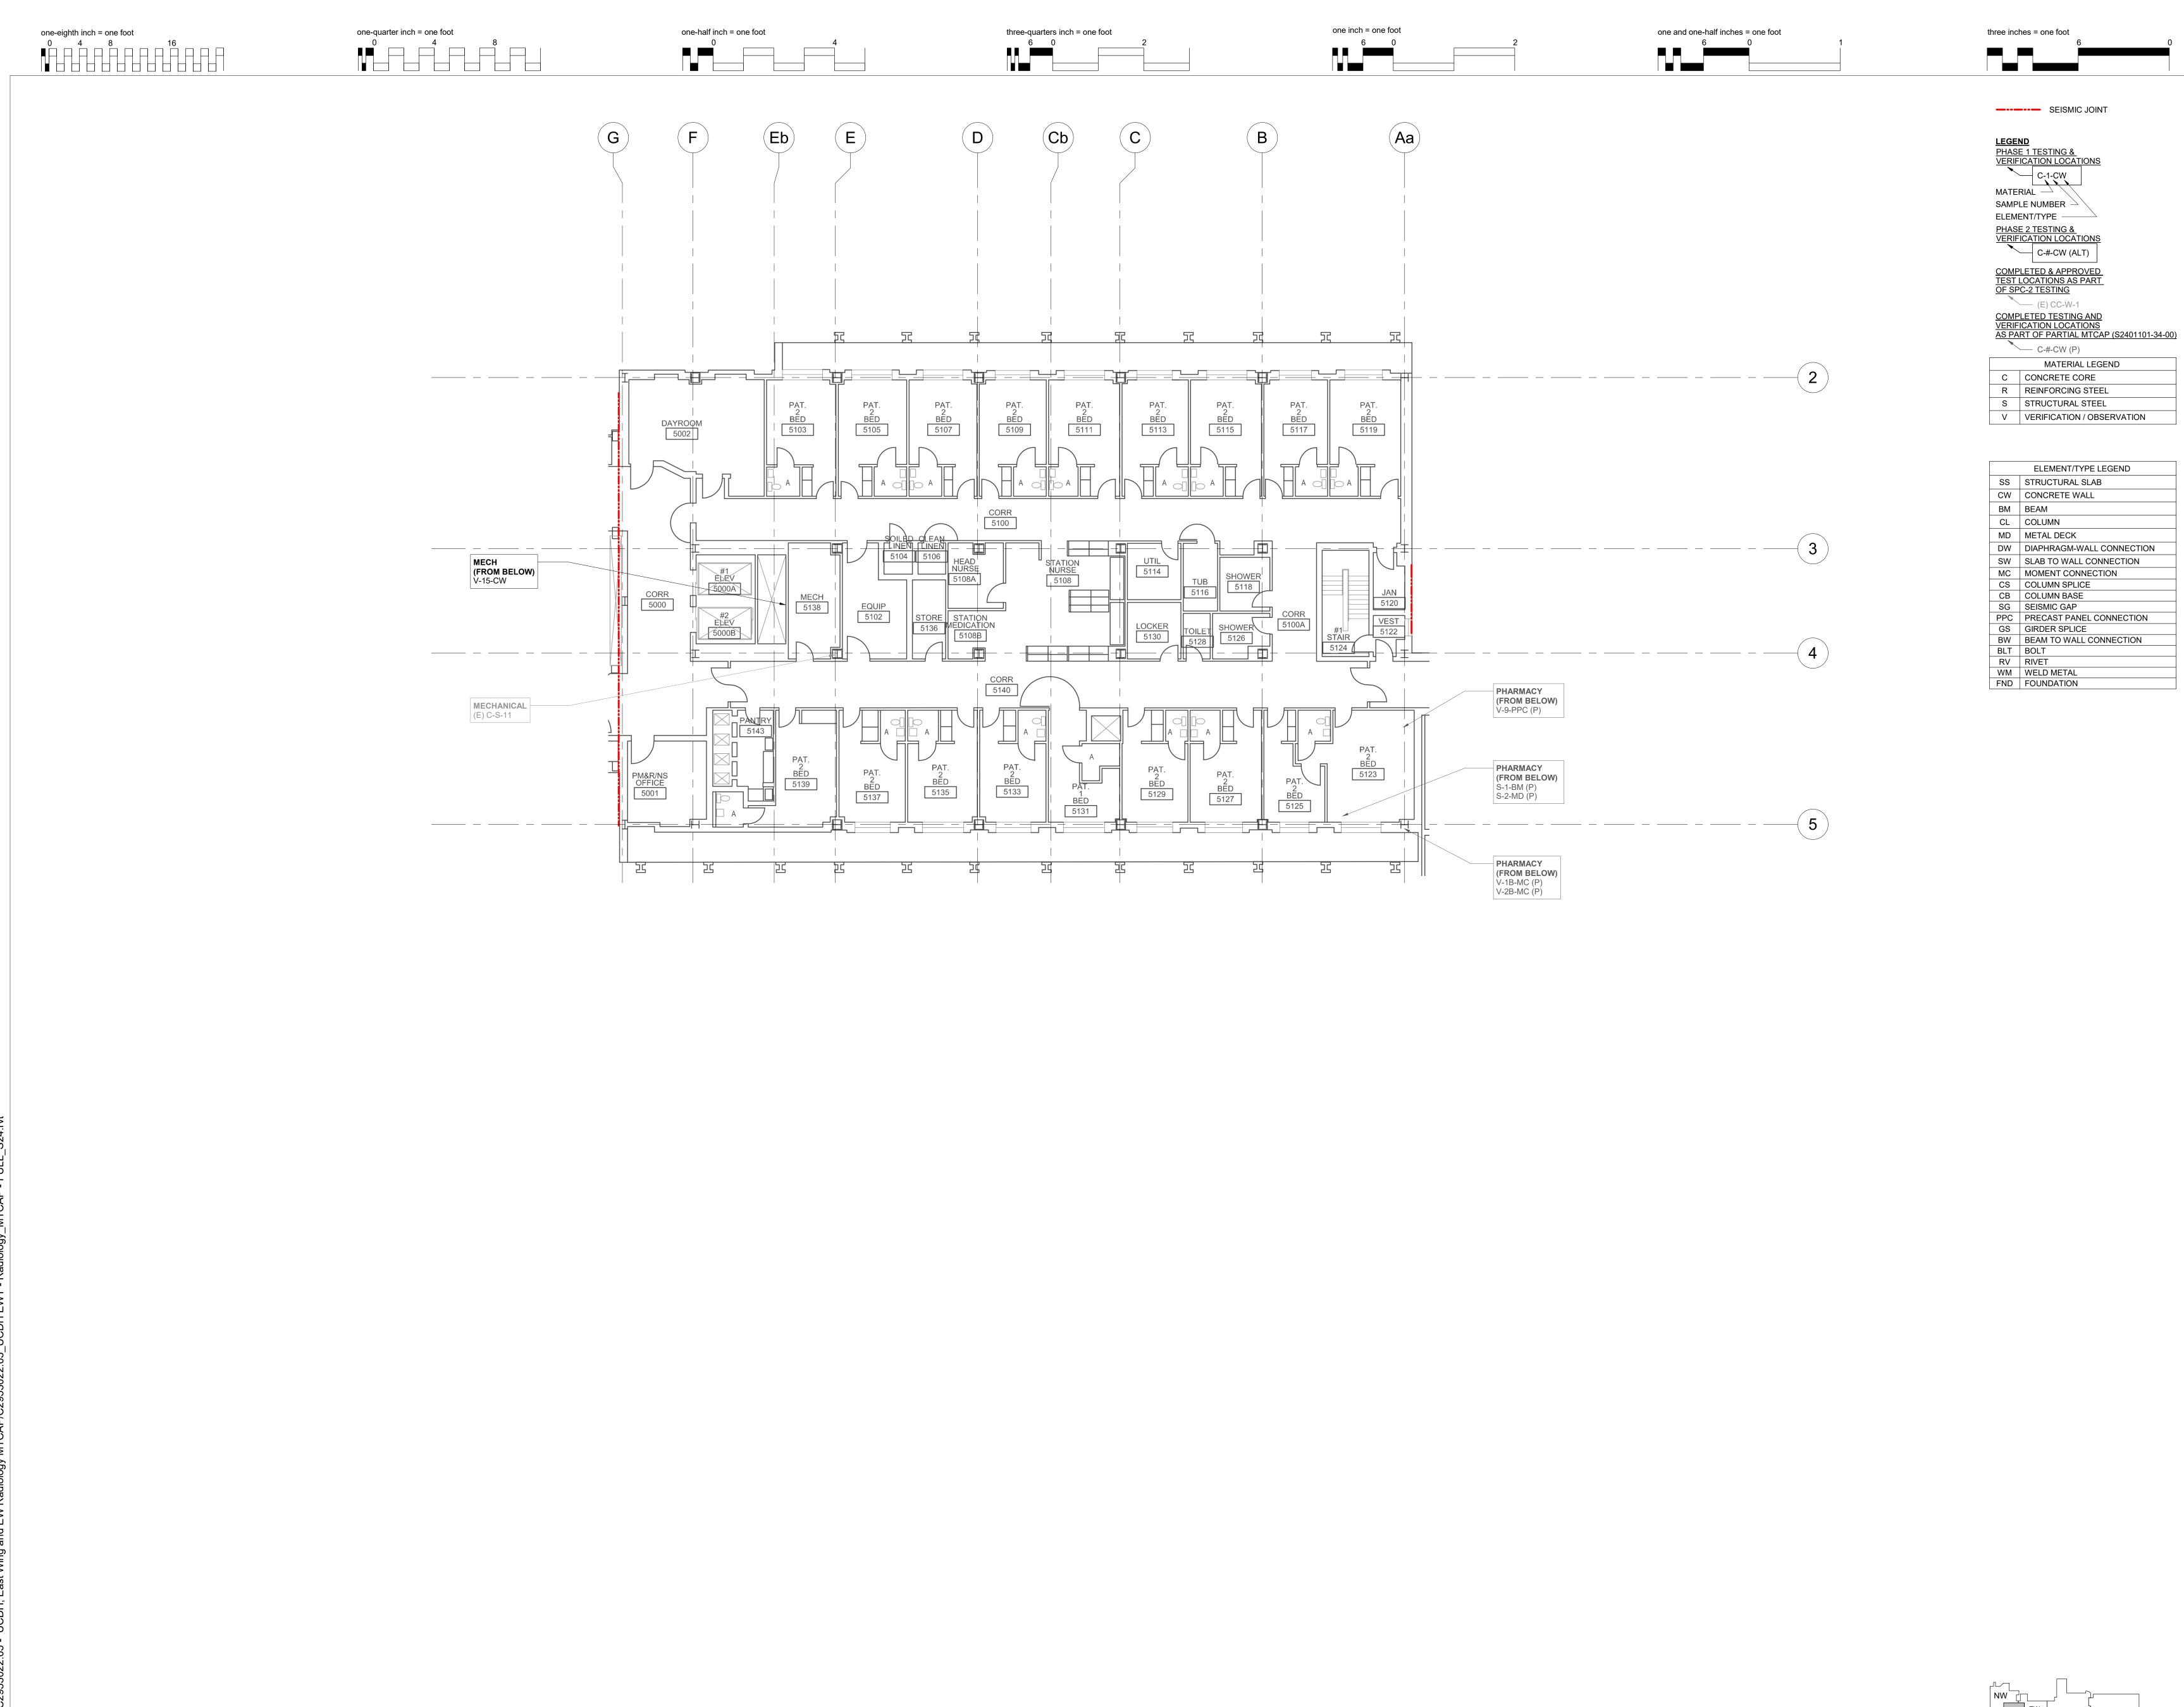
UCDH MEDICAL CENTER EAST WING TOWER & EAST WING RADIOLOGY

MTCAP

Sheet Title:

**5TH FLOOR PLAN** 

Scale:	As indicated
Job Number:	C2953022.05
Drawn by:	GG
Design by:	ASH
Checked by:	MGA
Date:	07/10/2025
Drawing Number:	



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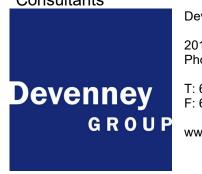
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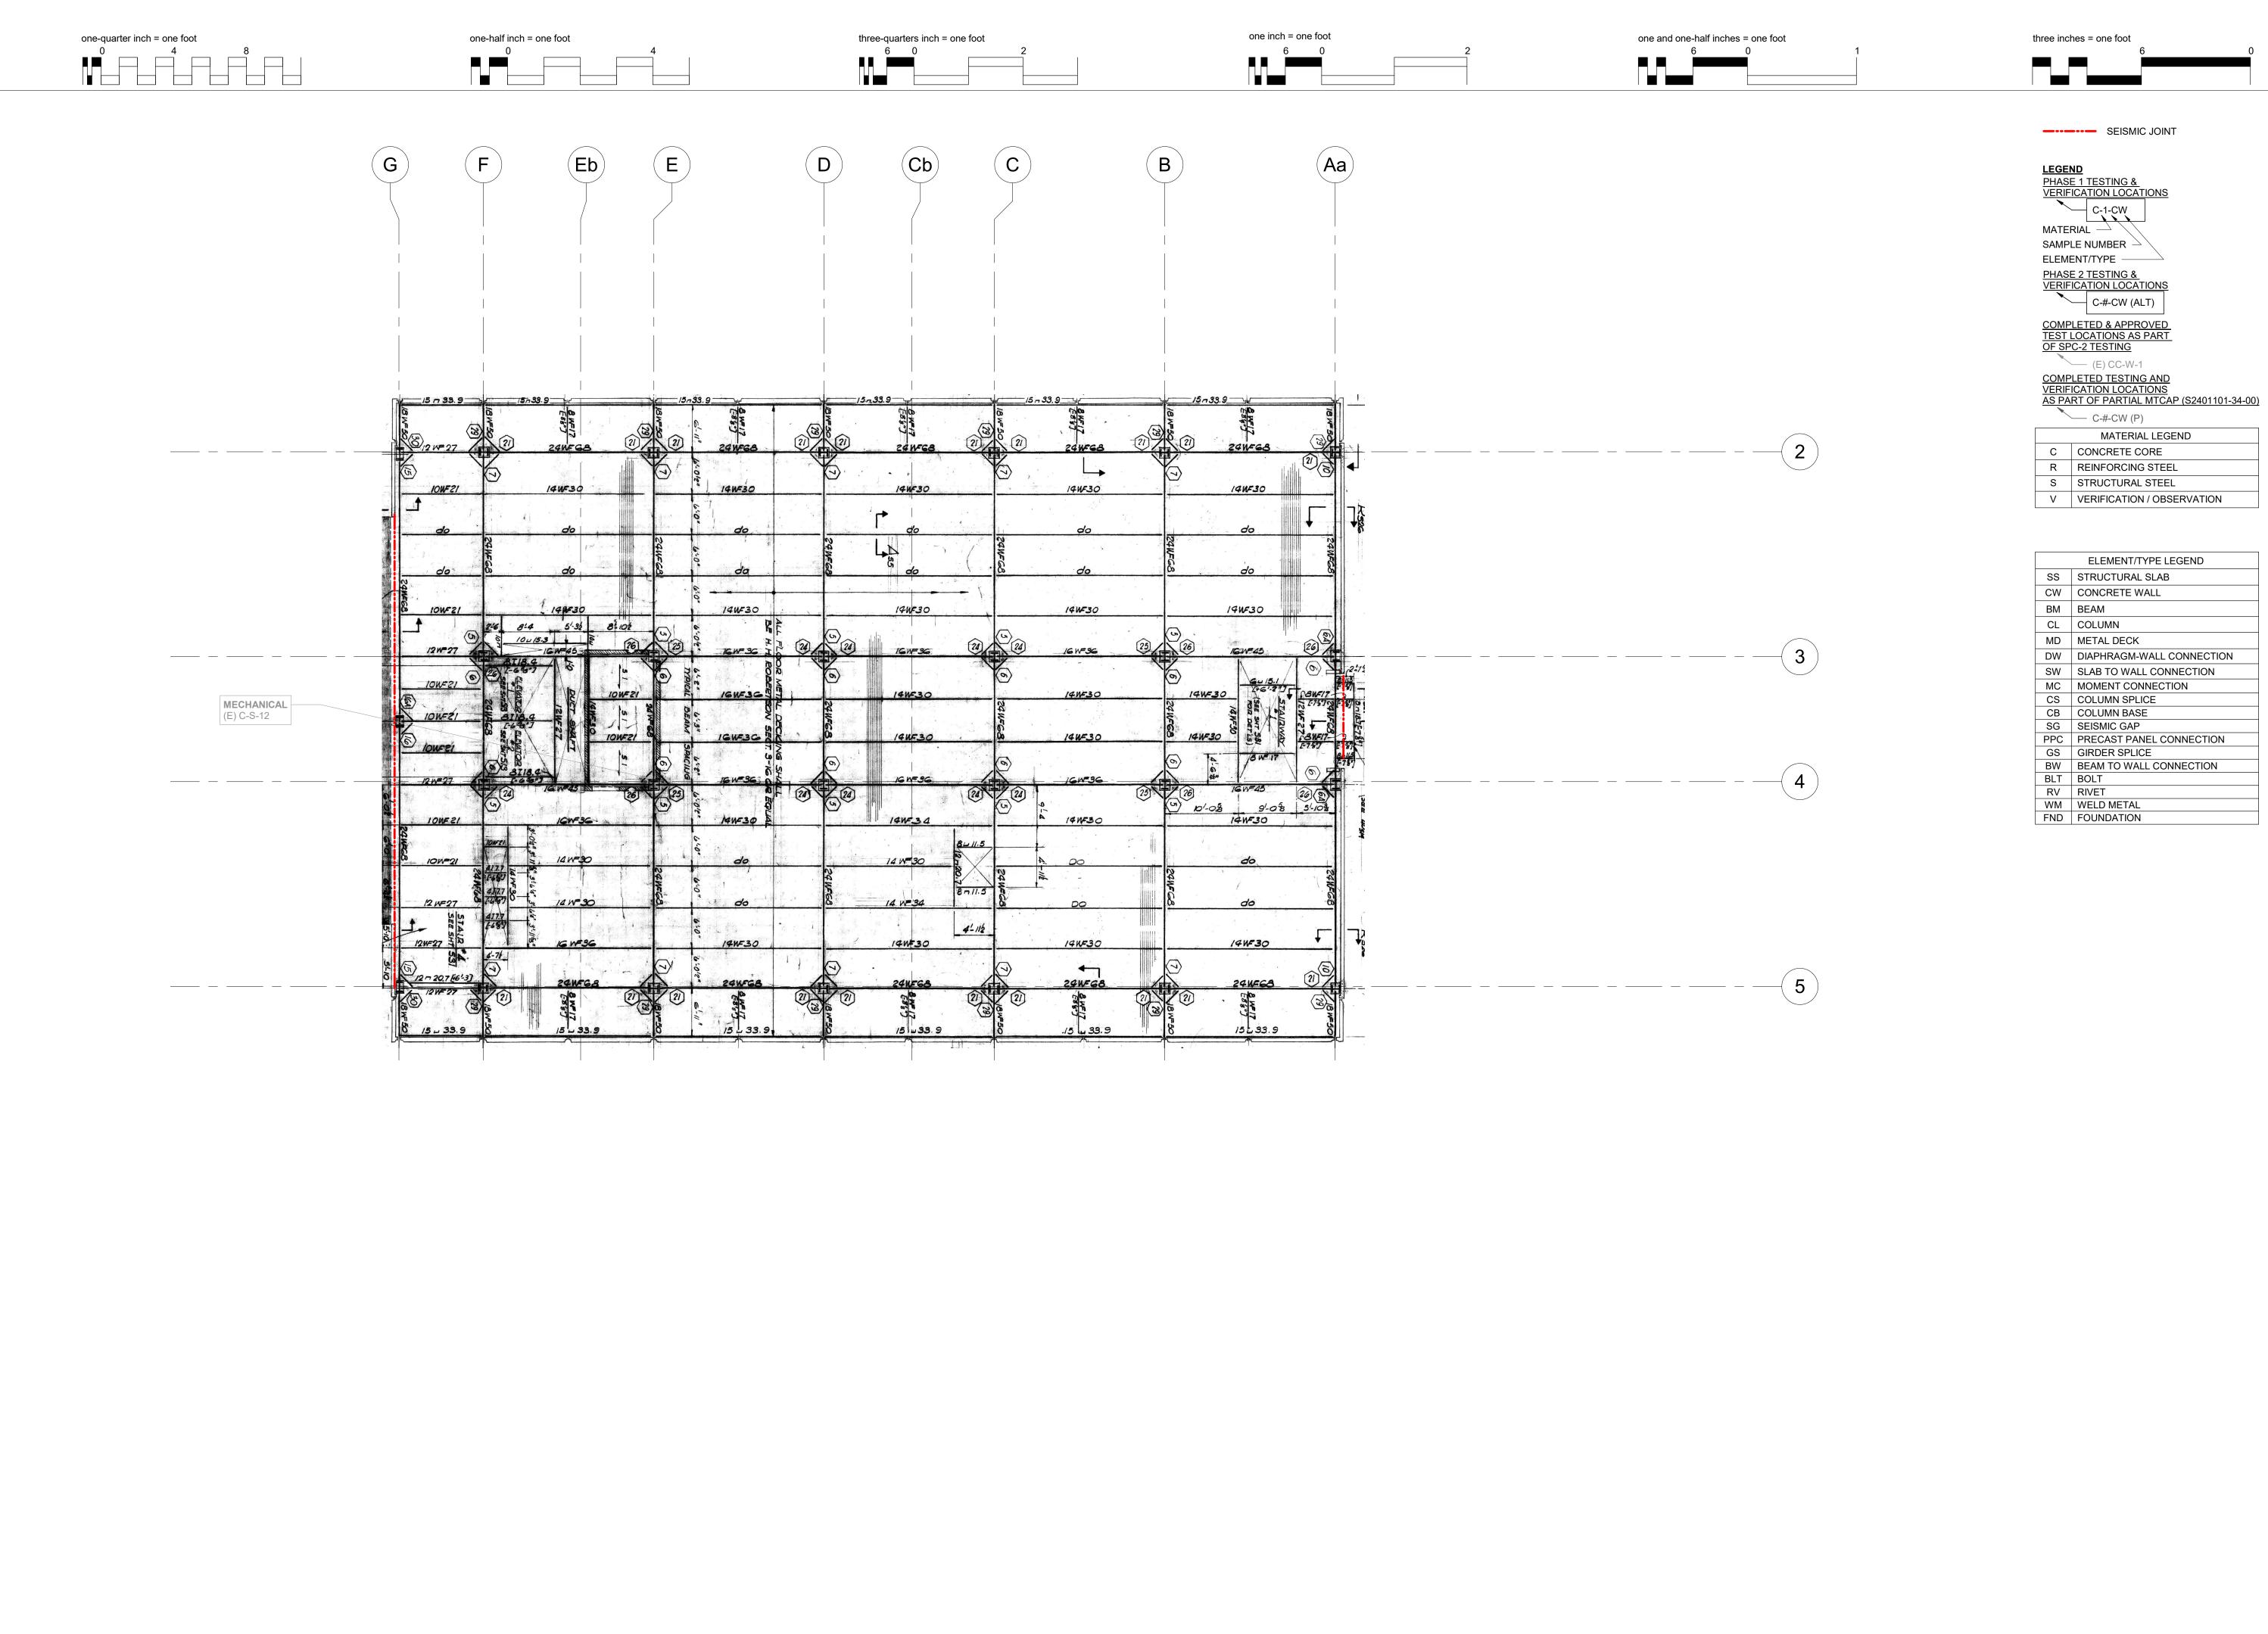


UCDH MEDICAL CENTER EAST WING TOWER & EAST WING RADIOLOGY MTCAP

Sheet Title:

5TH FLOOR ARCHITECTURAL PLAN

Scale:	As indicated
Job Number:	C2953022.05
Drawn by:	GG
Design by:	ASH
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Date:	07/10/2025
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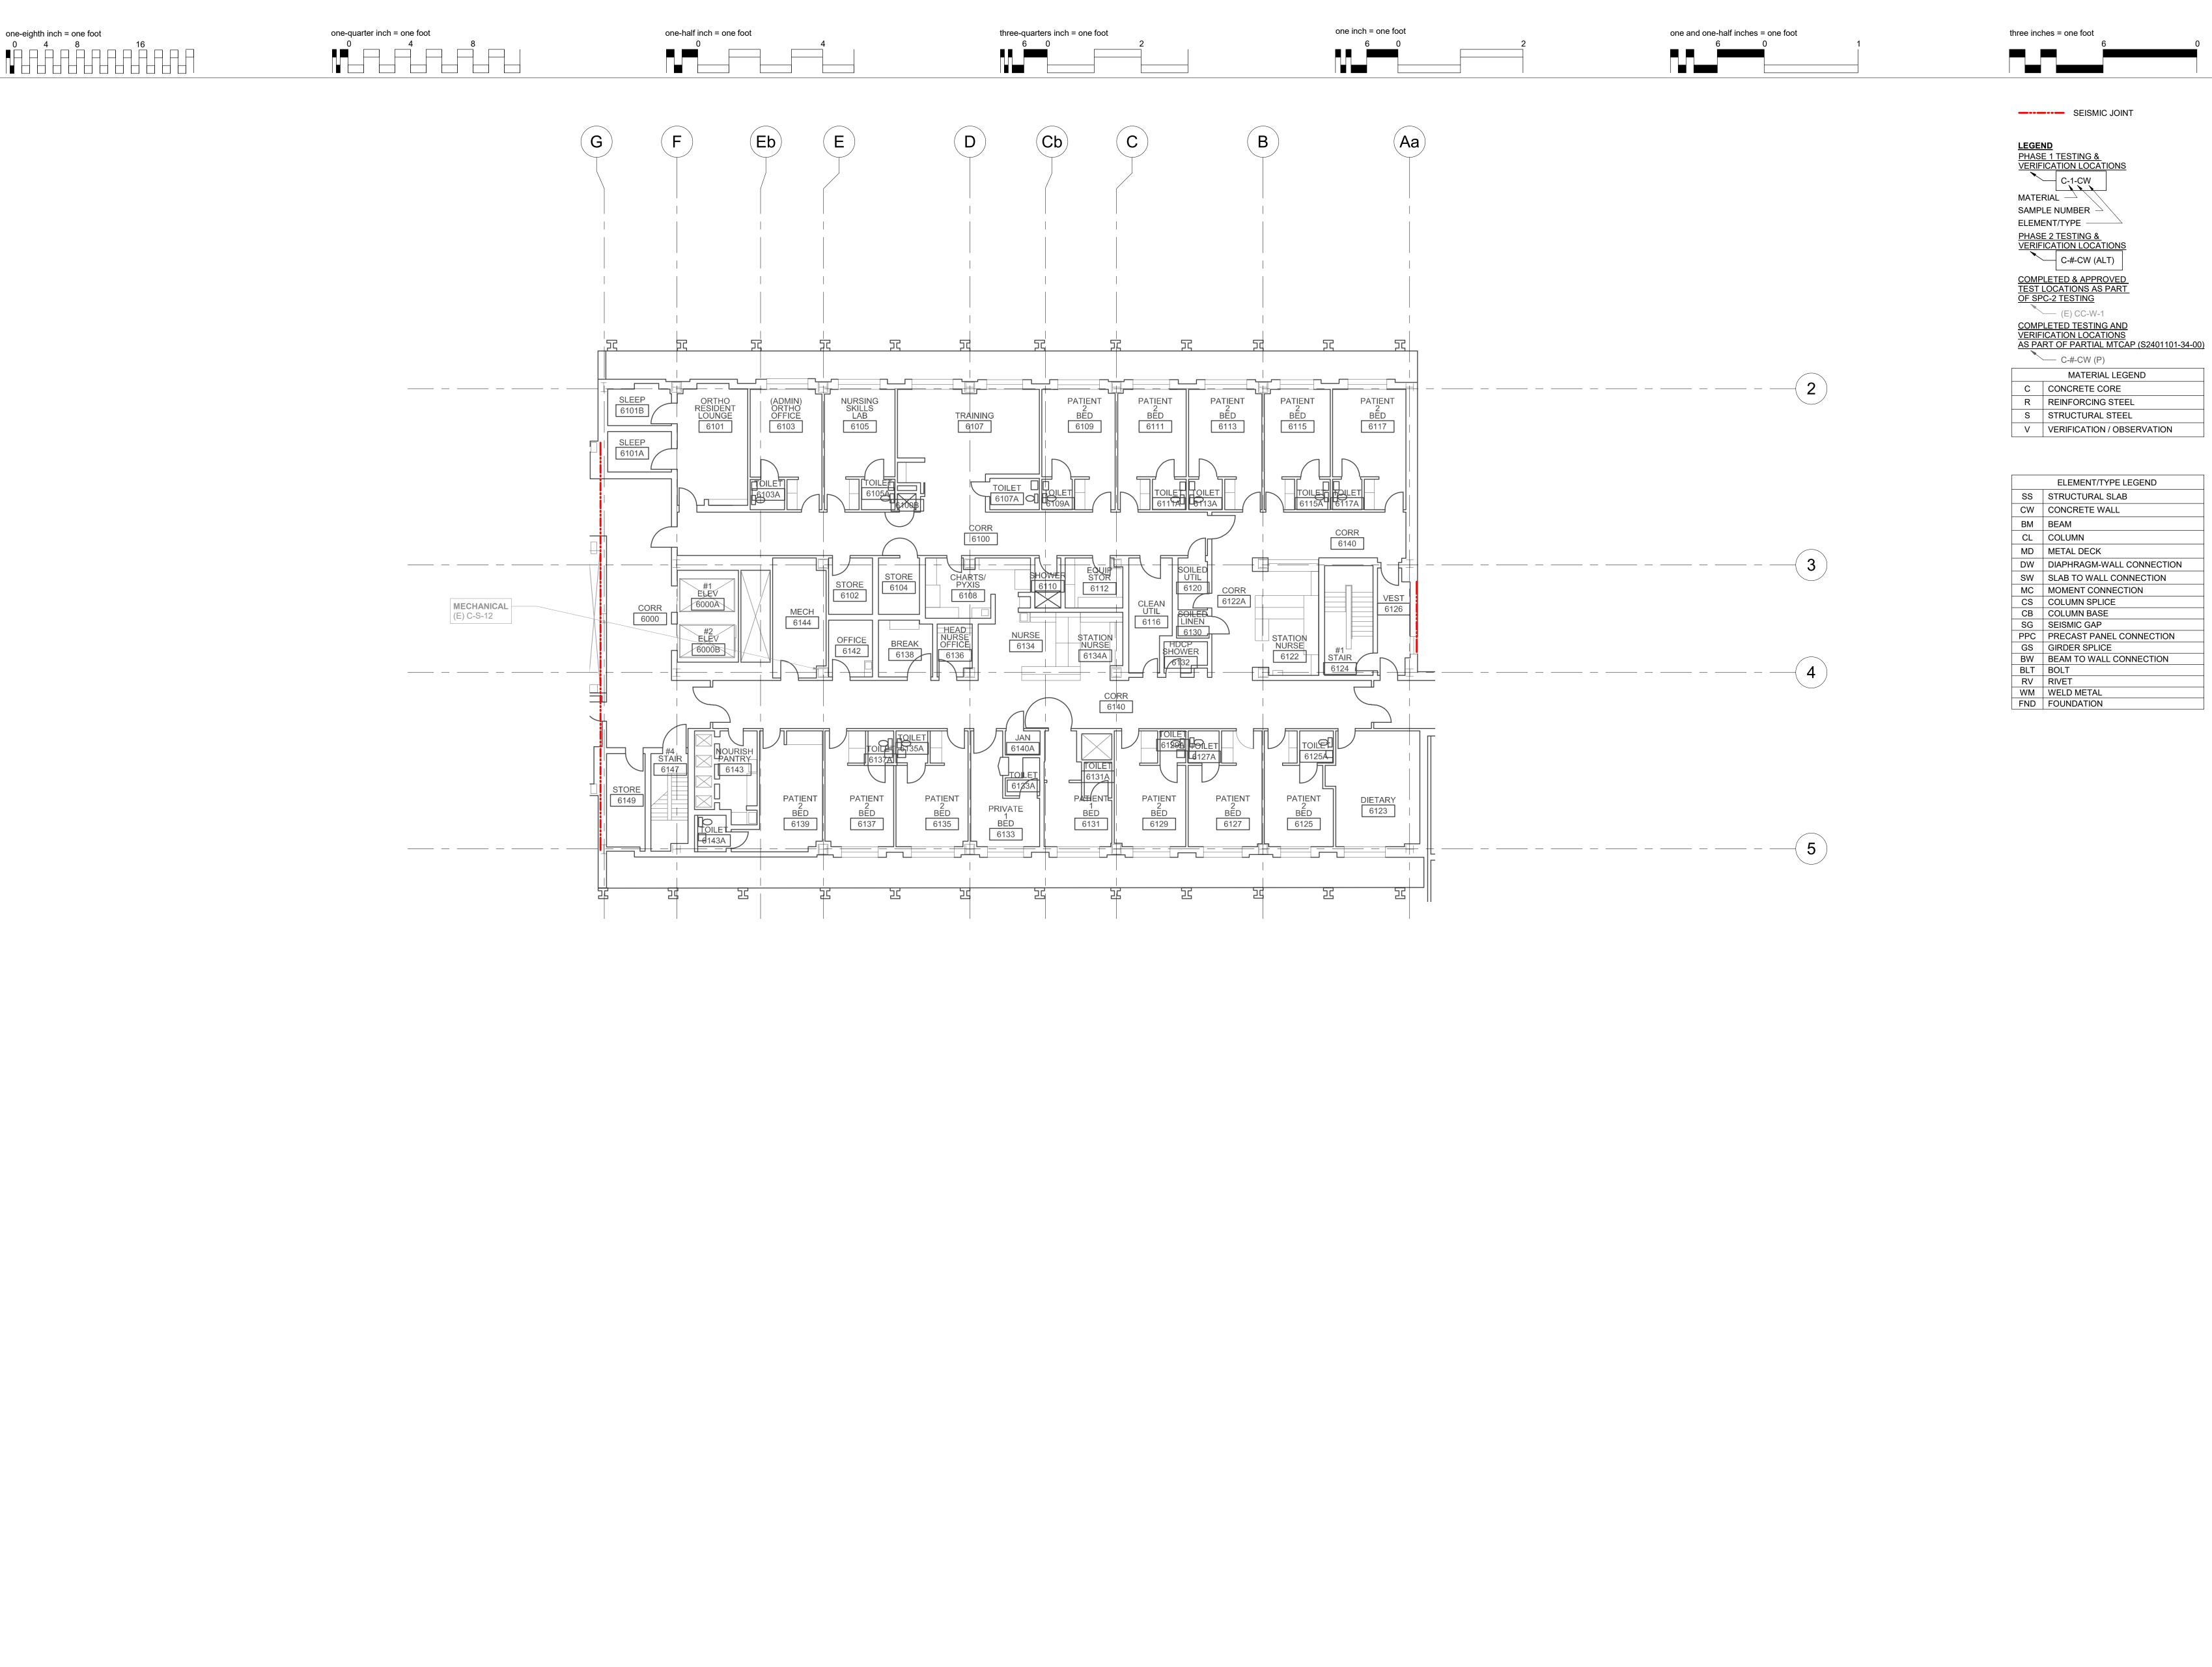
UCDH MEDICAL CENTER EAST WING TOWER & EAST WING RADIOLOGY

Sheet Title:

**6TH FLOOR PLAN** 

MTCAP

Scale:	As indicated
Job Number:	C2953022.05
Drawn by:	GG
Design by:	ASH
Checked by:	MGA
Date:	07/10/2025
Drawing Number:	



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9

AGENCY APPROVALS:



Project:

UCDH MEDICAL CENTER EAST WING TOWER & EAST WING RADIOLOGY MTCAP

Sheet Title:

6TH FLOOR ARCHITECTURAL PLAN


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Design by:	ASH
Checked by:	MGA
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Drawing Number:

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SIXTH FLOOR PLA



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AUTHORITY HAVING JURISDICTION:

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AGENCY APPROVALS:

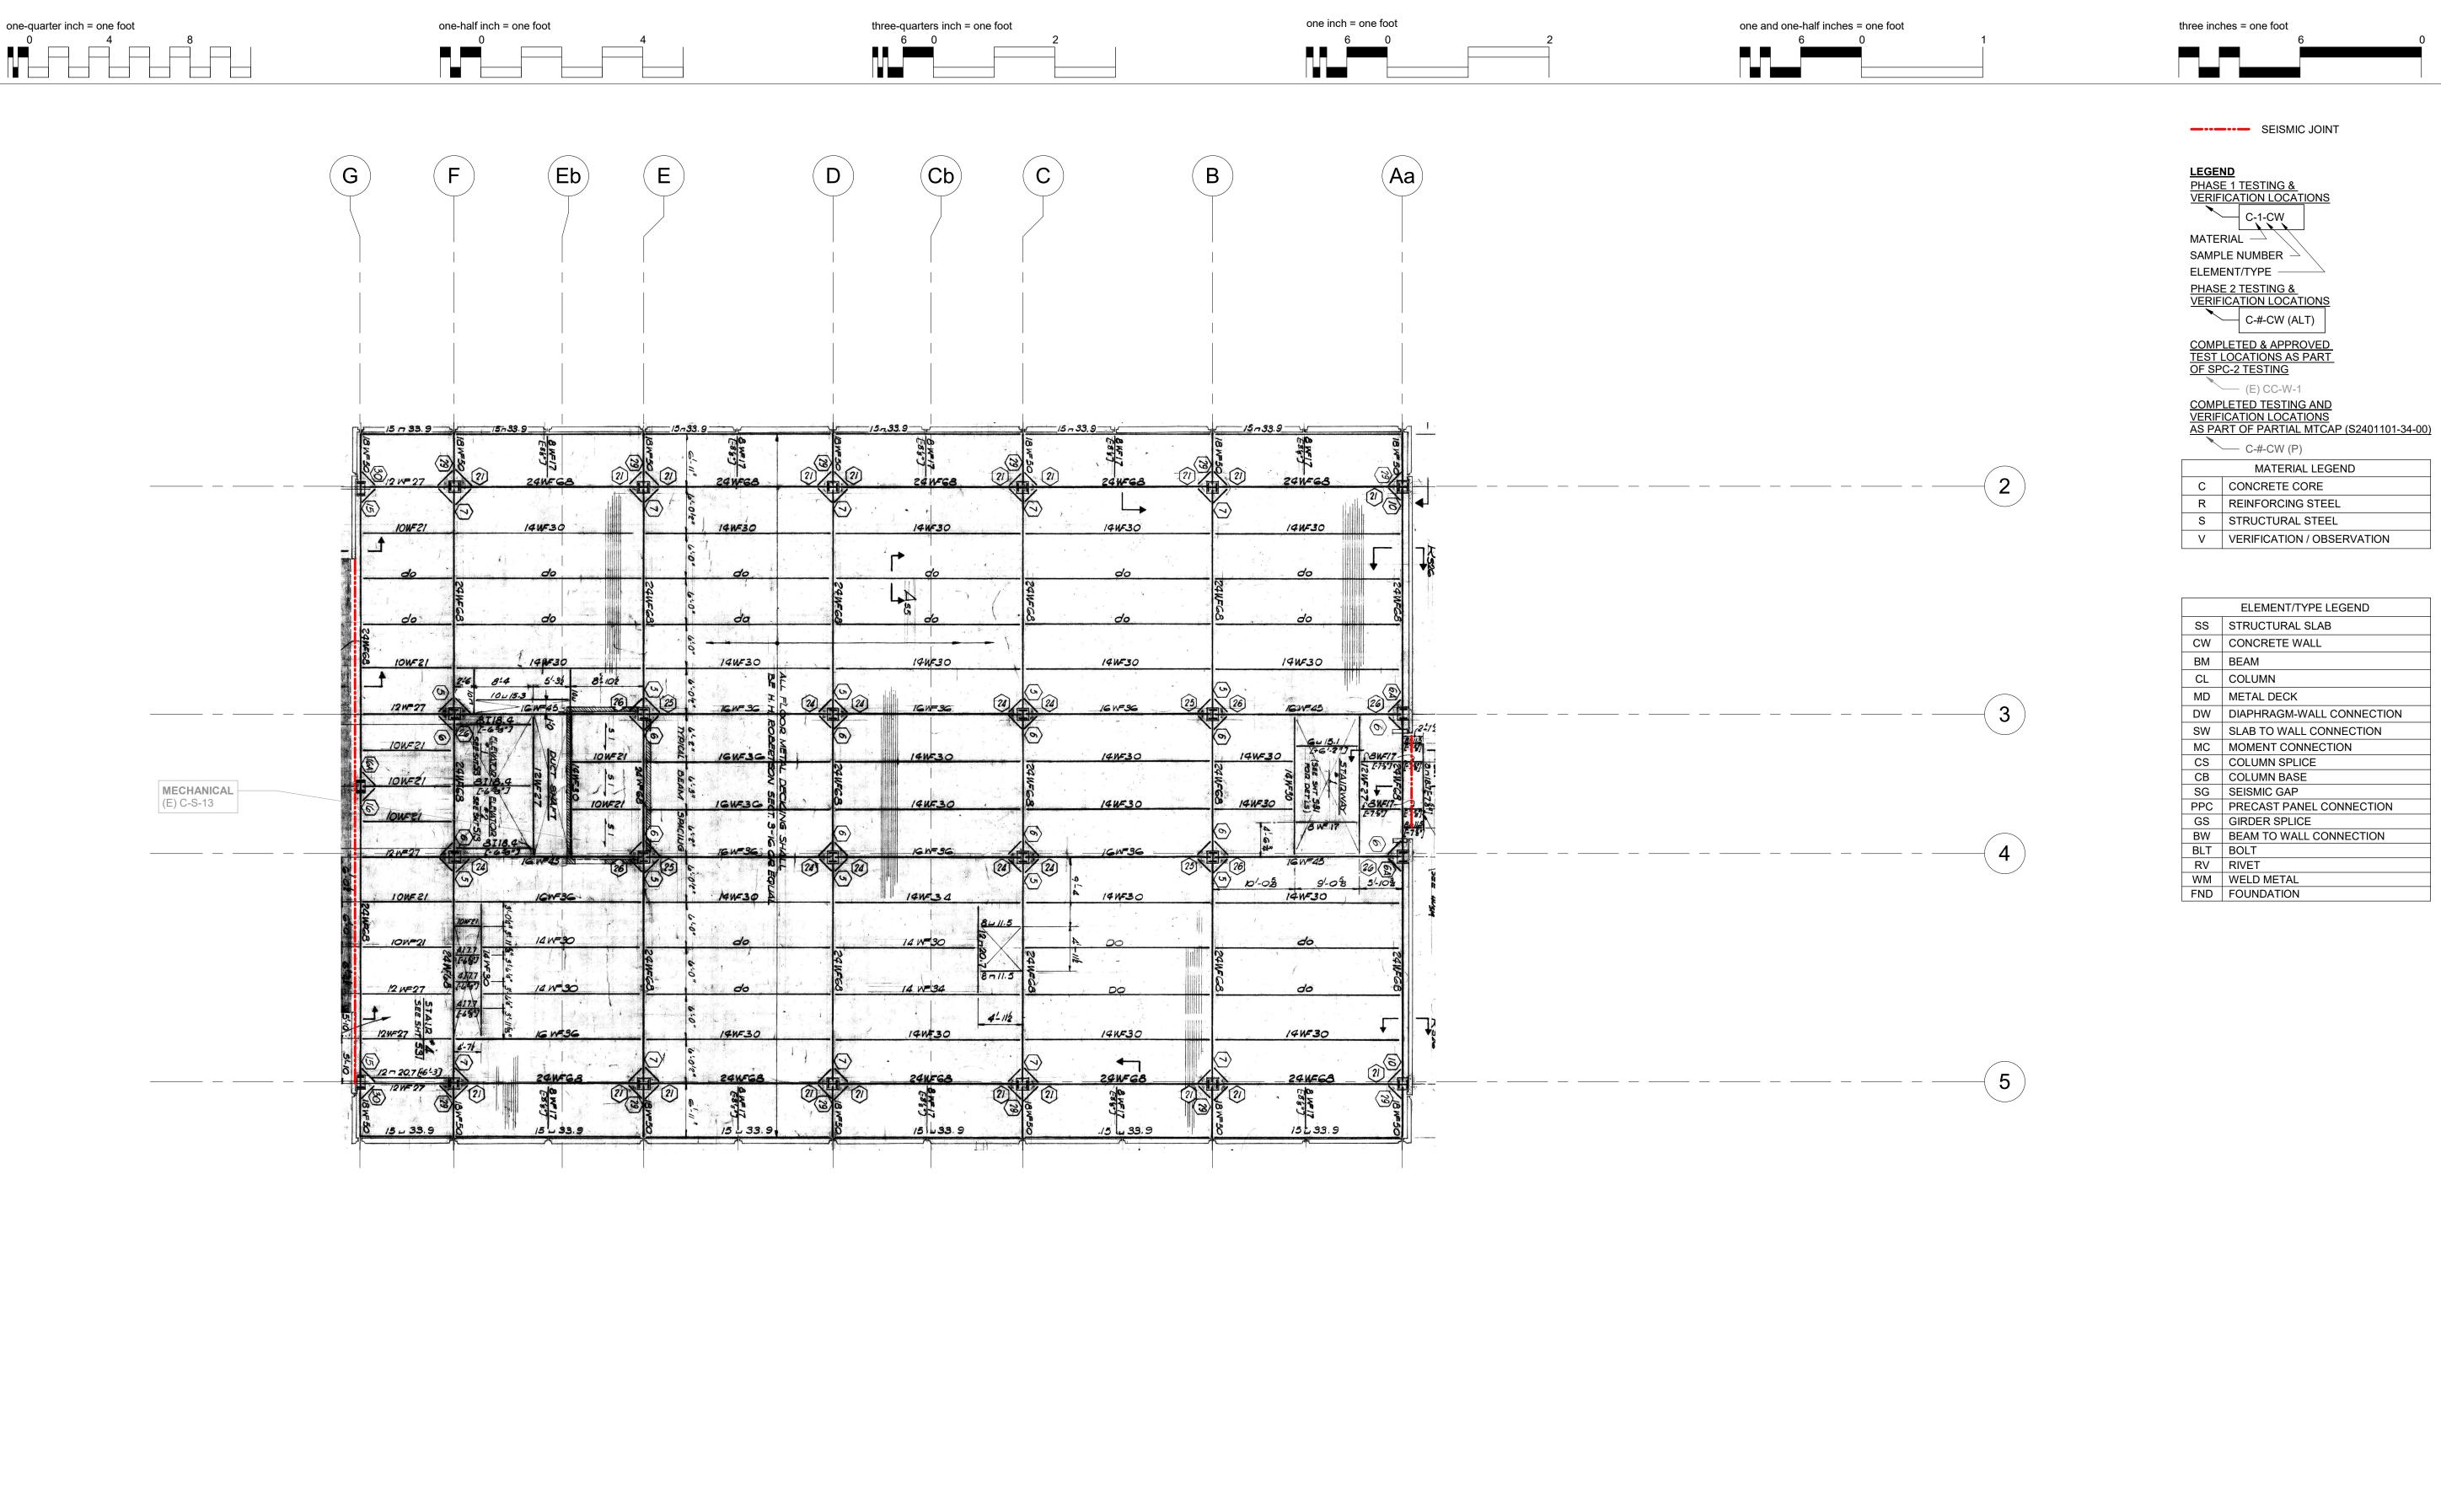
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Sheet Title:

7TH FLOOR PLAN

Scale:	As indicated
Job Number:	C2953022.05
Drawn by:	GG
Design by:	ASH
Checked by:	MGA
Date:	07/10/2025



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No. Description Date
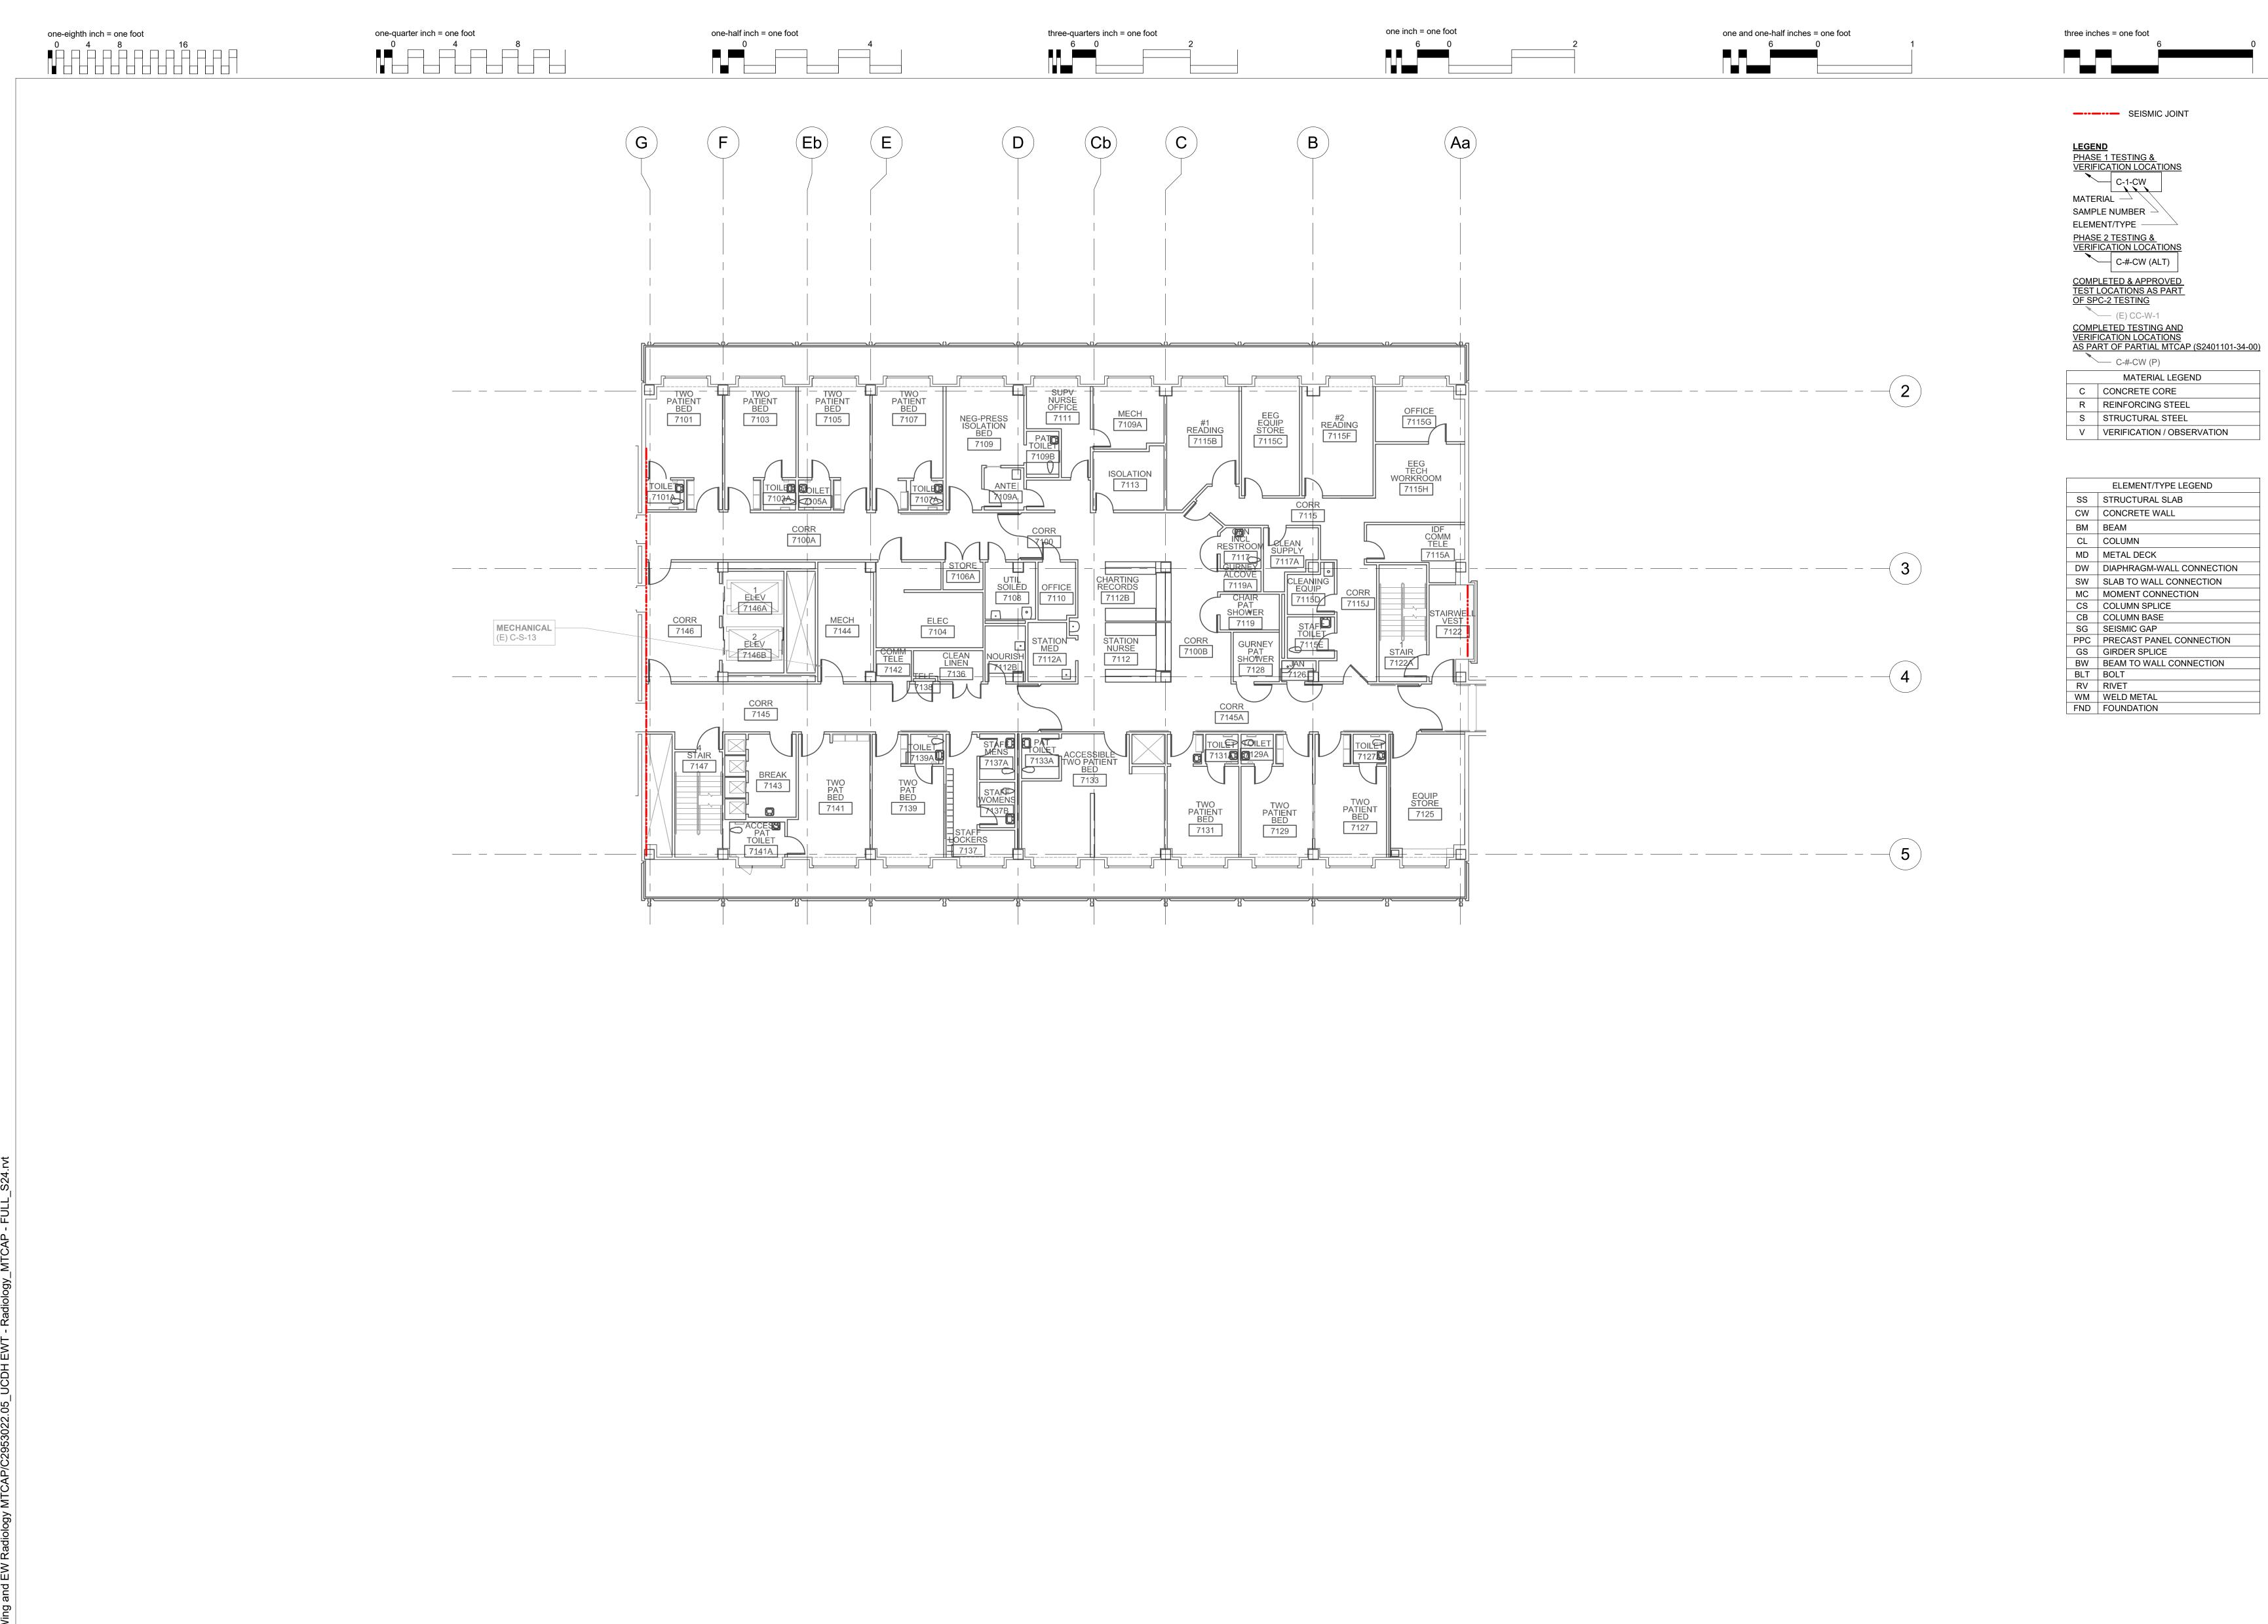
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AUTHORITY HAVING JURISDICTION'S PROJECT NO. S251130-34-00 FACILITY NUMBER

AGENCY APPROVALS:



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UCDH MEDICAL CENTER EAST WING TOWER & EAST WING RADIOLOGY MTCAP

Sheet Title:

7TH FLOOR ARCHITECTURAL PLAN


Scale:	As indicated
Job Number:	C2953022.05
Drawn by:	GG
Design by:	ASH
Checked by:	MGA
Date:	07/10/2025
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Drawing Number:

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of Sheet

1 SEVENTH FLOOR PLAN



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AUTHORITY HAVING JURISDICTION:

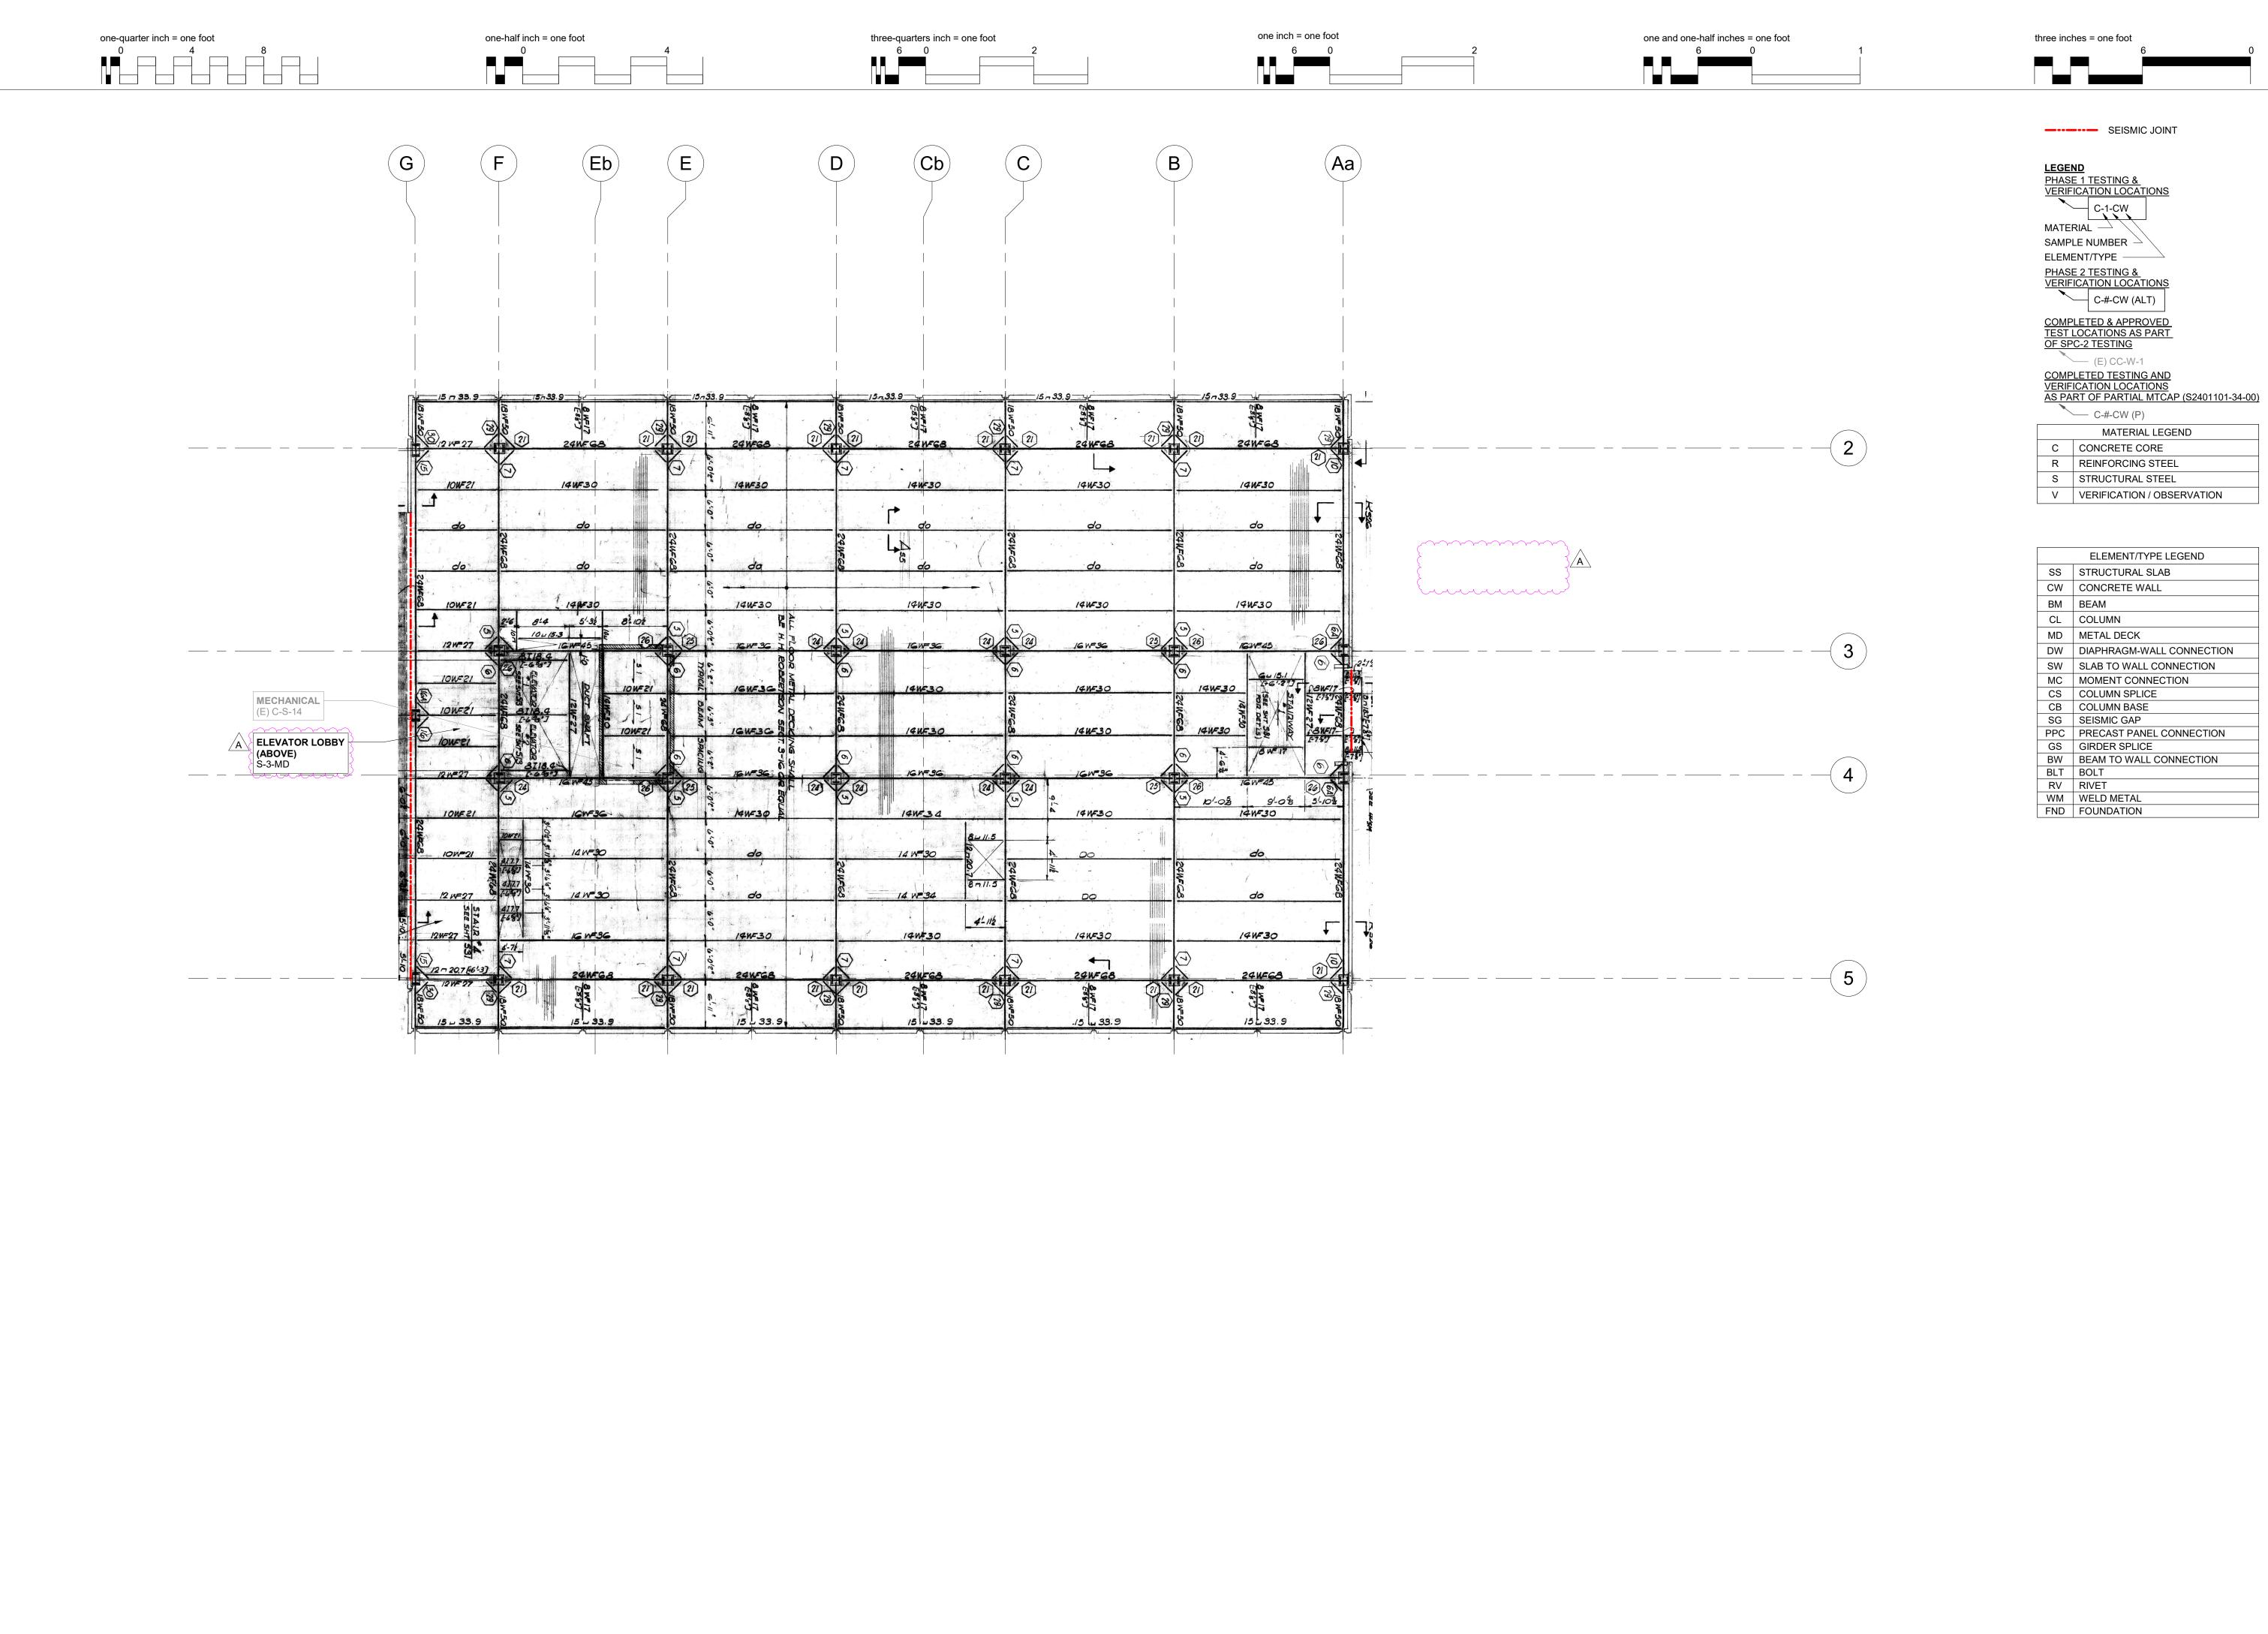AUTHORITY HAVING JURISDICTION'S PROJECT NO. S251130-34-00 FACILITY NUMBER

AGENCY APPROVALS:




UCDH MEDICAL CENTER EAST WING TOWER & EAST WING RADIOLOGY MTCAP

Sheet Title:

8TH FLOOR PLAN

Scale:	As indicated
Job Number:	C2953022.05
Drawn by:	GG
Design by:	ASH
Checked by:	MGA
Date:	07/10/2025
Drawing Number:	

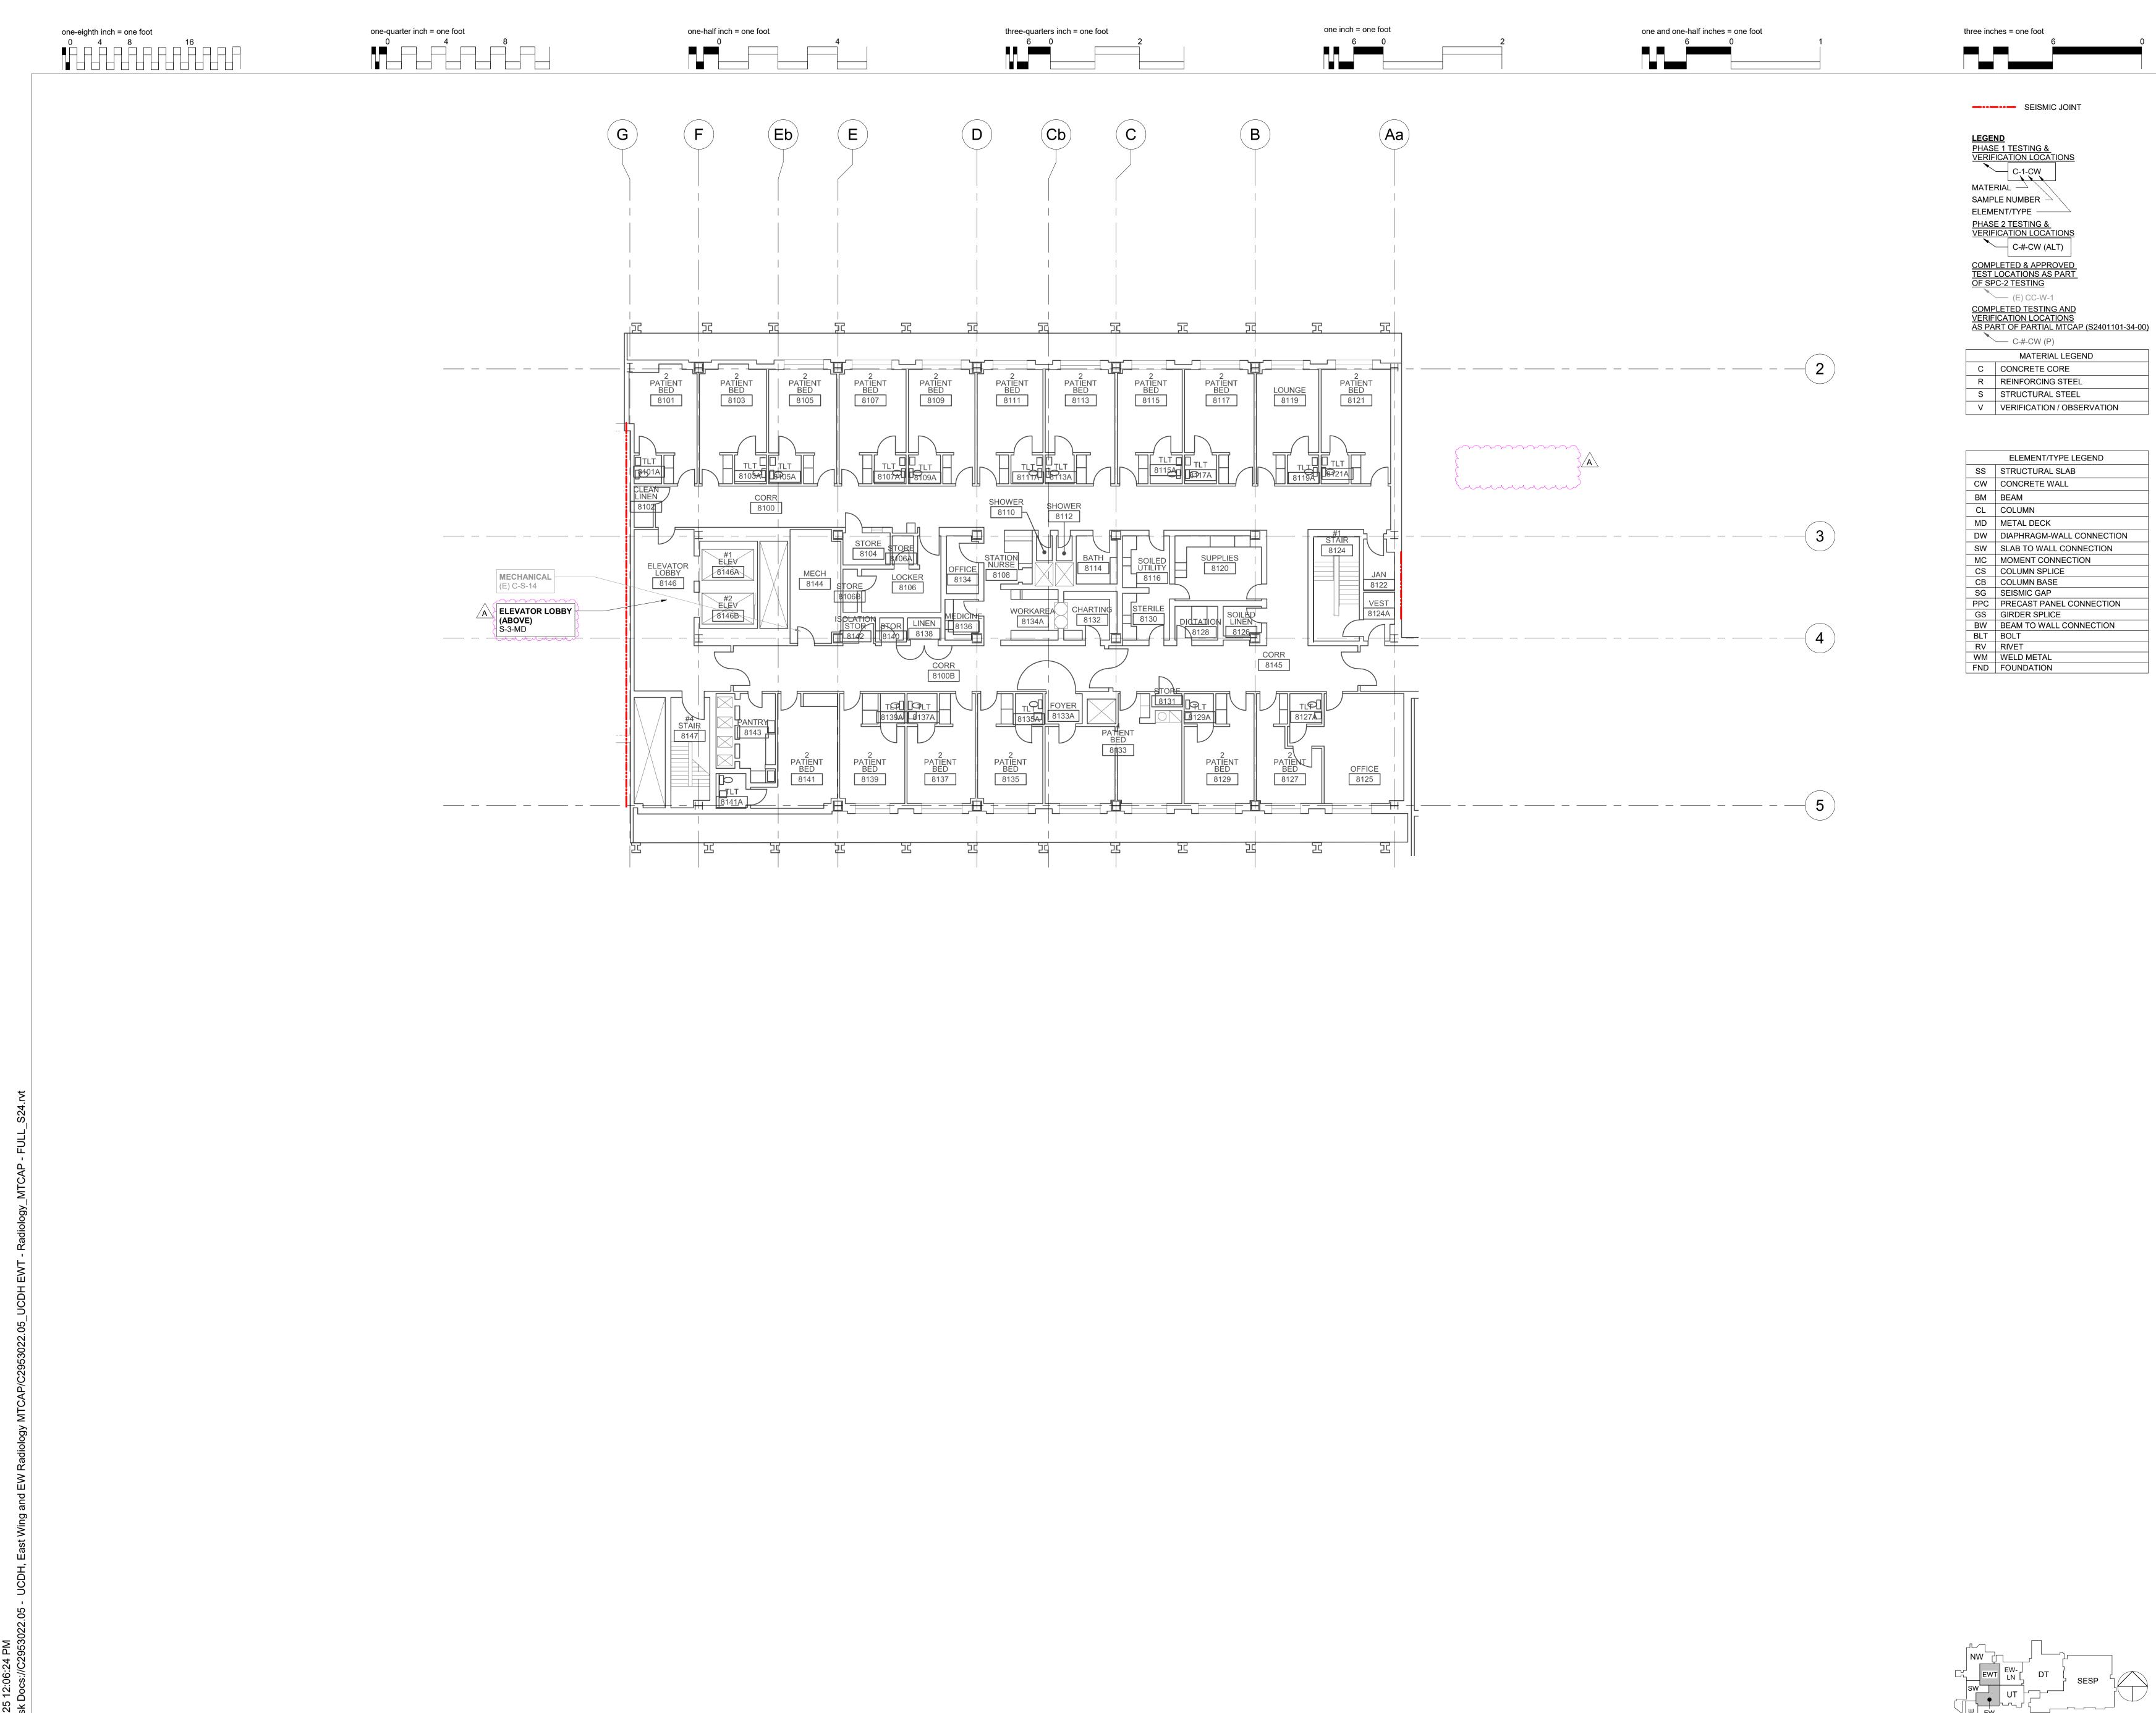

OWNER:

### HEALTH



DEGENKOLB ENGINEERS 428 J Street, Suite 500 Sacramento, CA 95814 916.418.9100 PHONE www.degenkolb.com

DE Job Number: C2953022.04

SEALS AND SIGNATURES



Consultants Devenney

Devenney Group Ltd., Architects 201 W. Indian School Road Phoenix, Arizona 85013 T: 602.943.8950 F: 602.943.7645 GROUP www.devenneygroup.com

SEALS AND SIGNATURES

Revision Description A HCAi Backcheck #1

**AUTHORITY HAVING JURISDICTION:** 

AUTHORITY HAVING JURISDICTION'S PROJECT NO. S251130-34-00 FACILITY NUMBER

AGENCY APPROVALS:




UCDH MEDICAL CENTER EAST WING TOWER & EAST WING RADIOLOGY MTCAP

Sheet Title:

8TH FLOOR ARCHITECTURAL PLAN

Scale:	As indicated
Job Number:	C2953022.05
Drawn by:	GG
Design by:	ASH
Checked by:	MGA
Date:	07/10/2025
Drawing Number:	

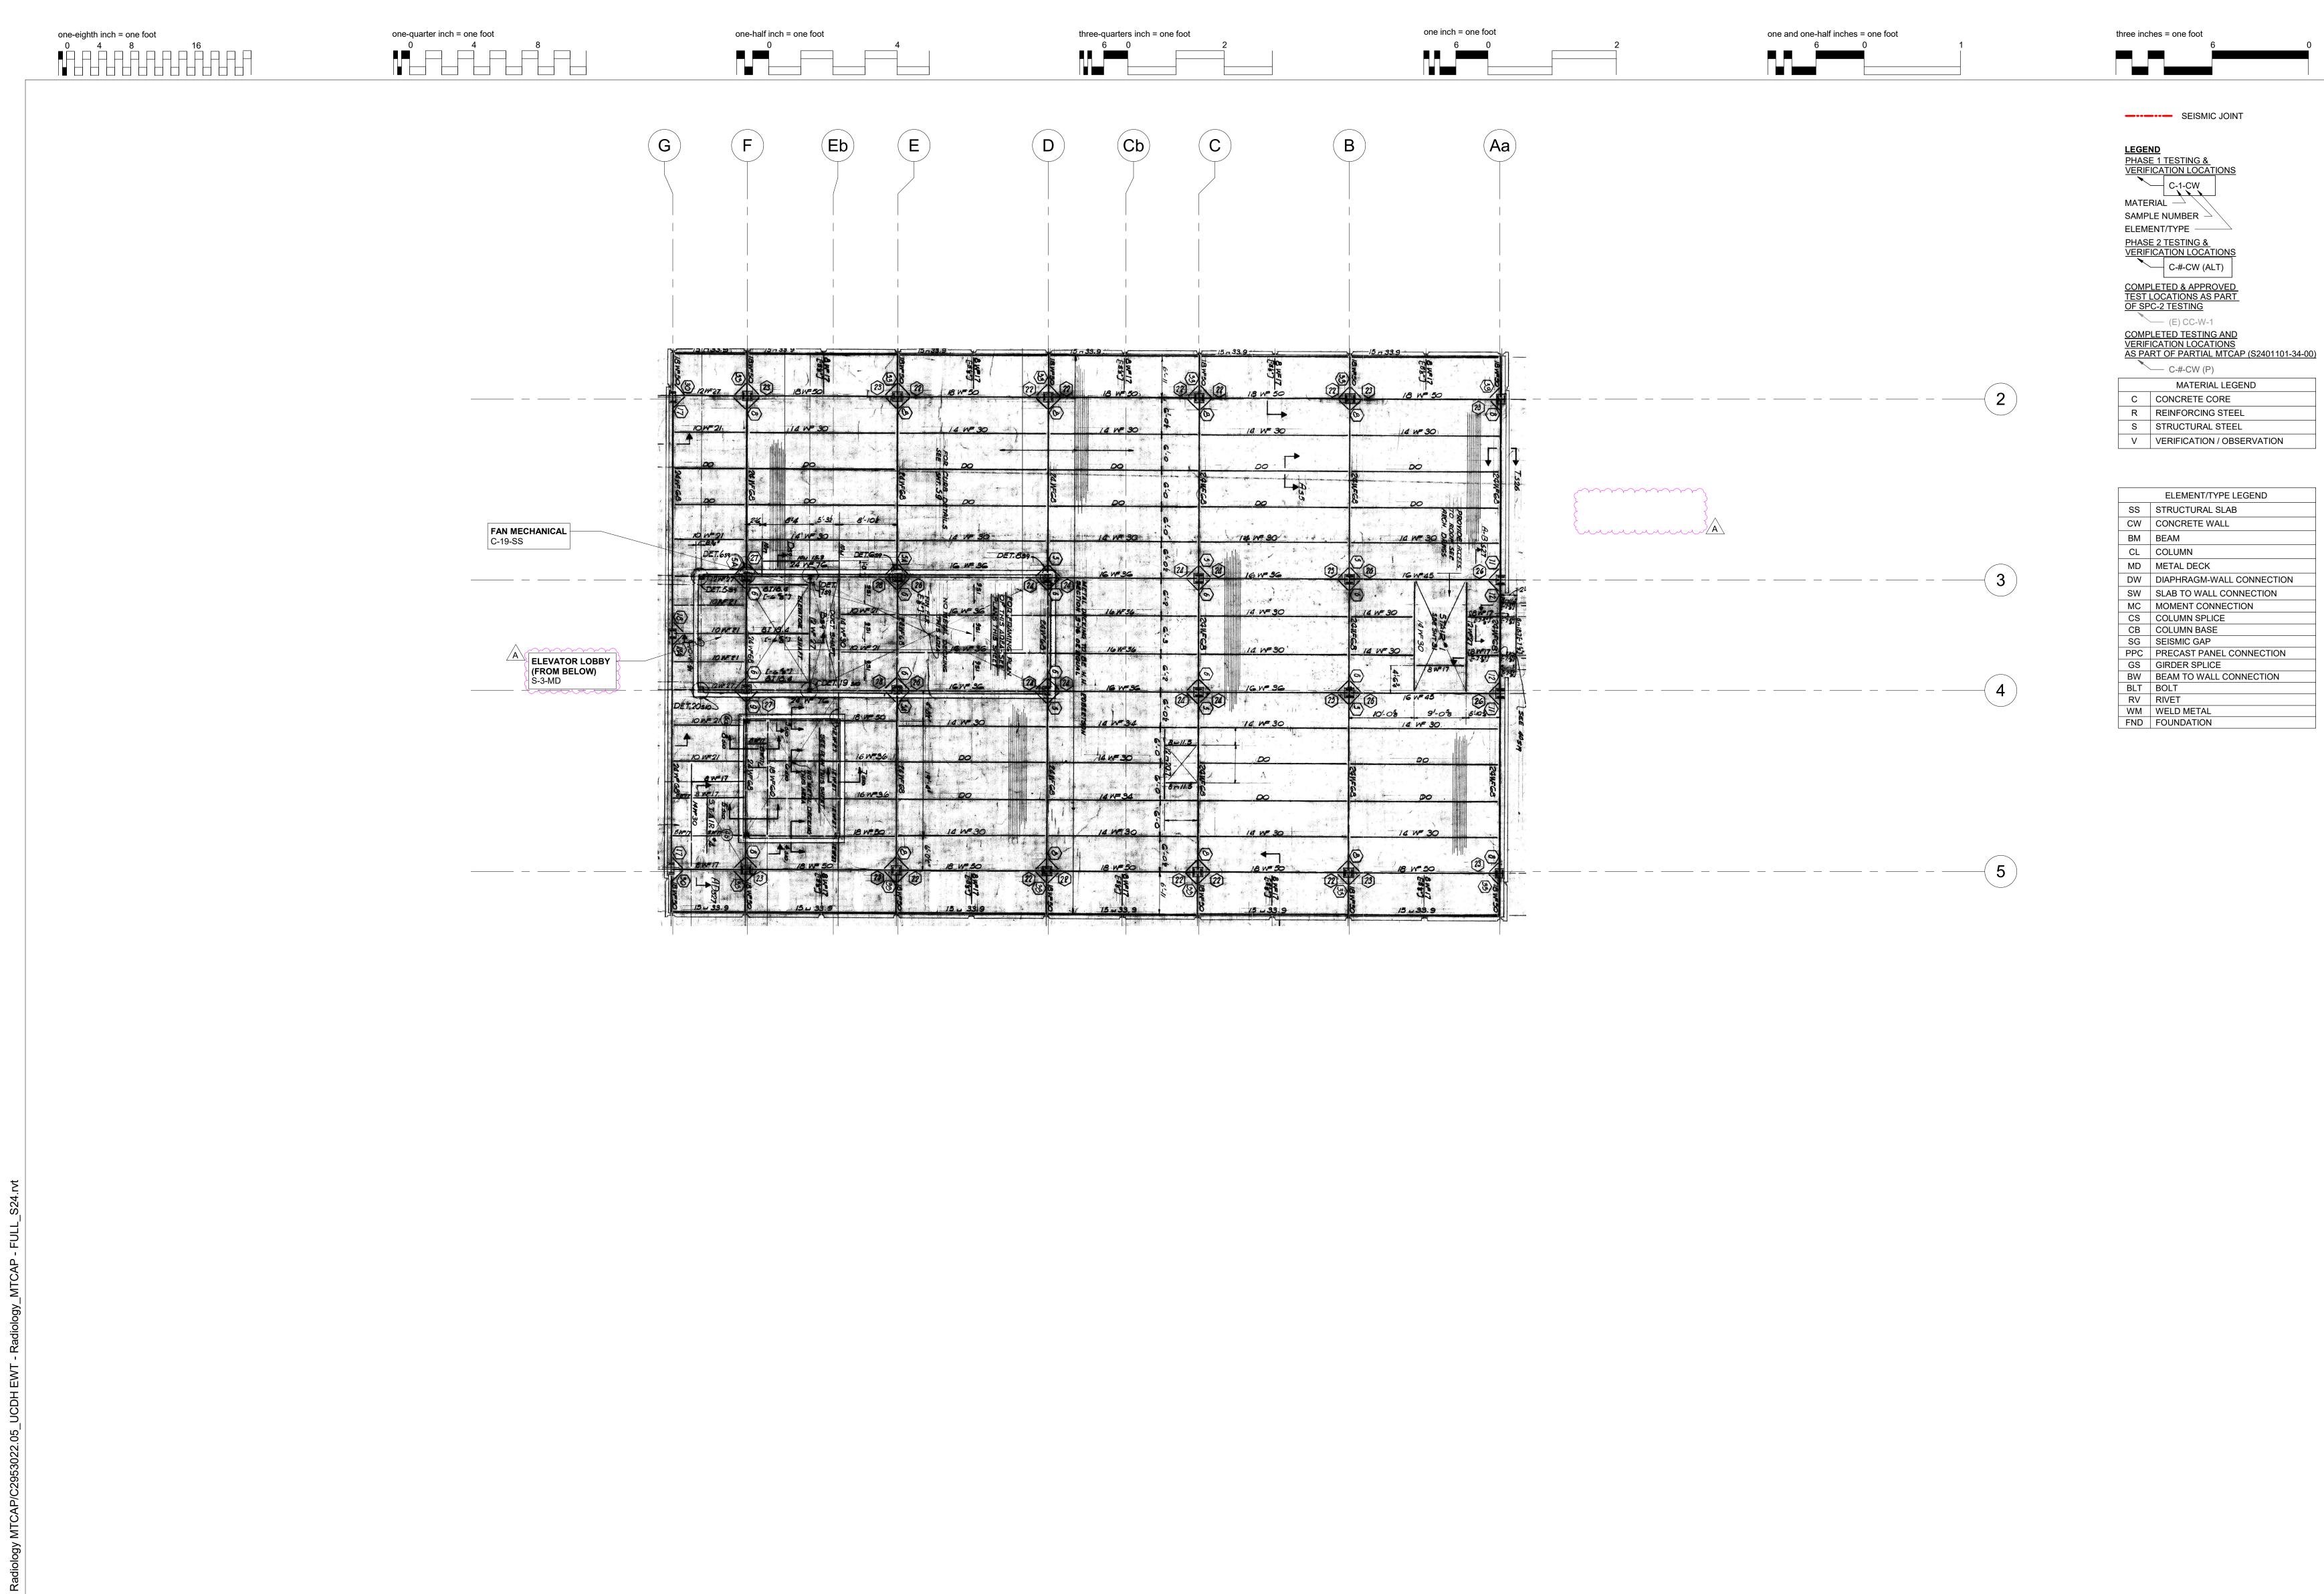

OWNER:

### HEALTH



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SEALS AND SIGNATURES



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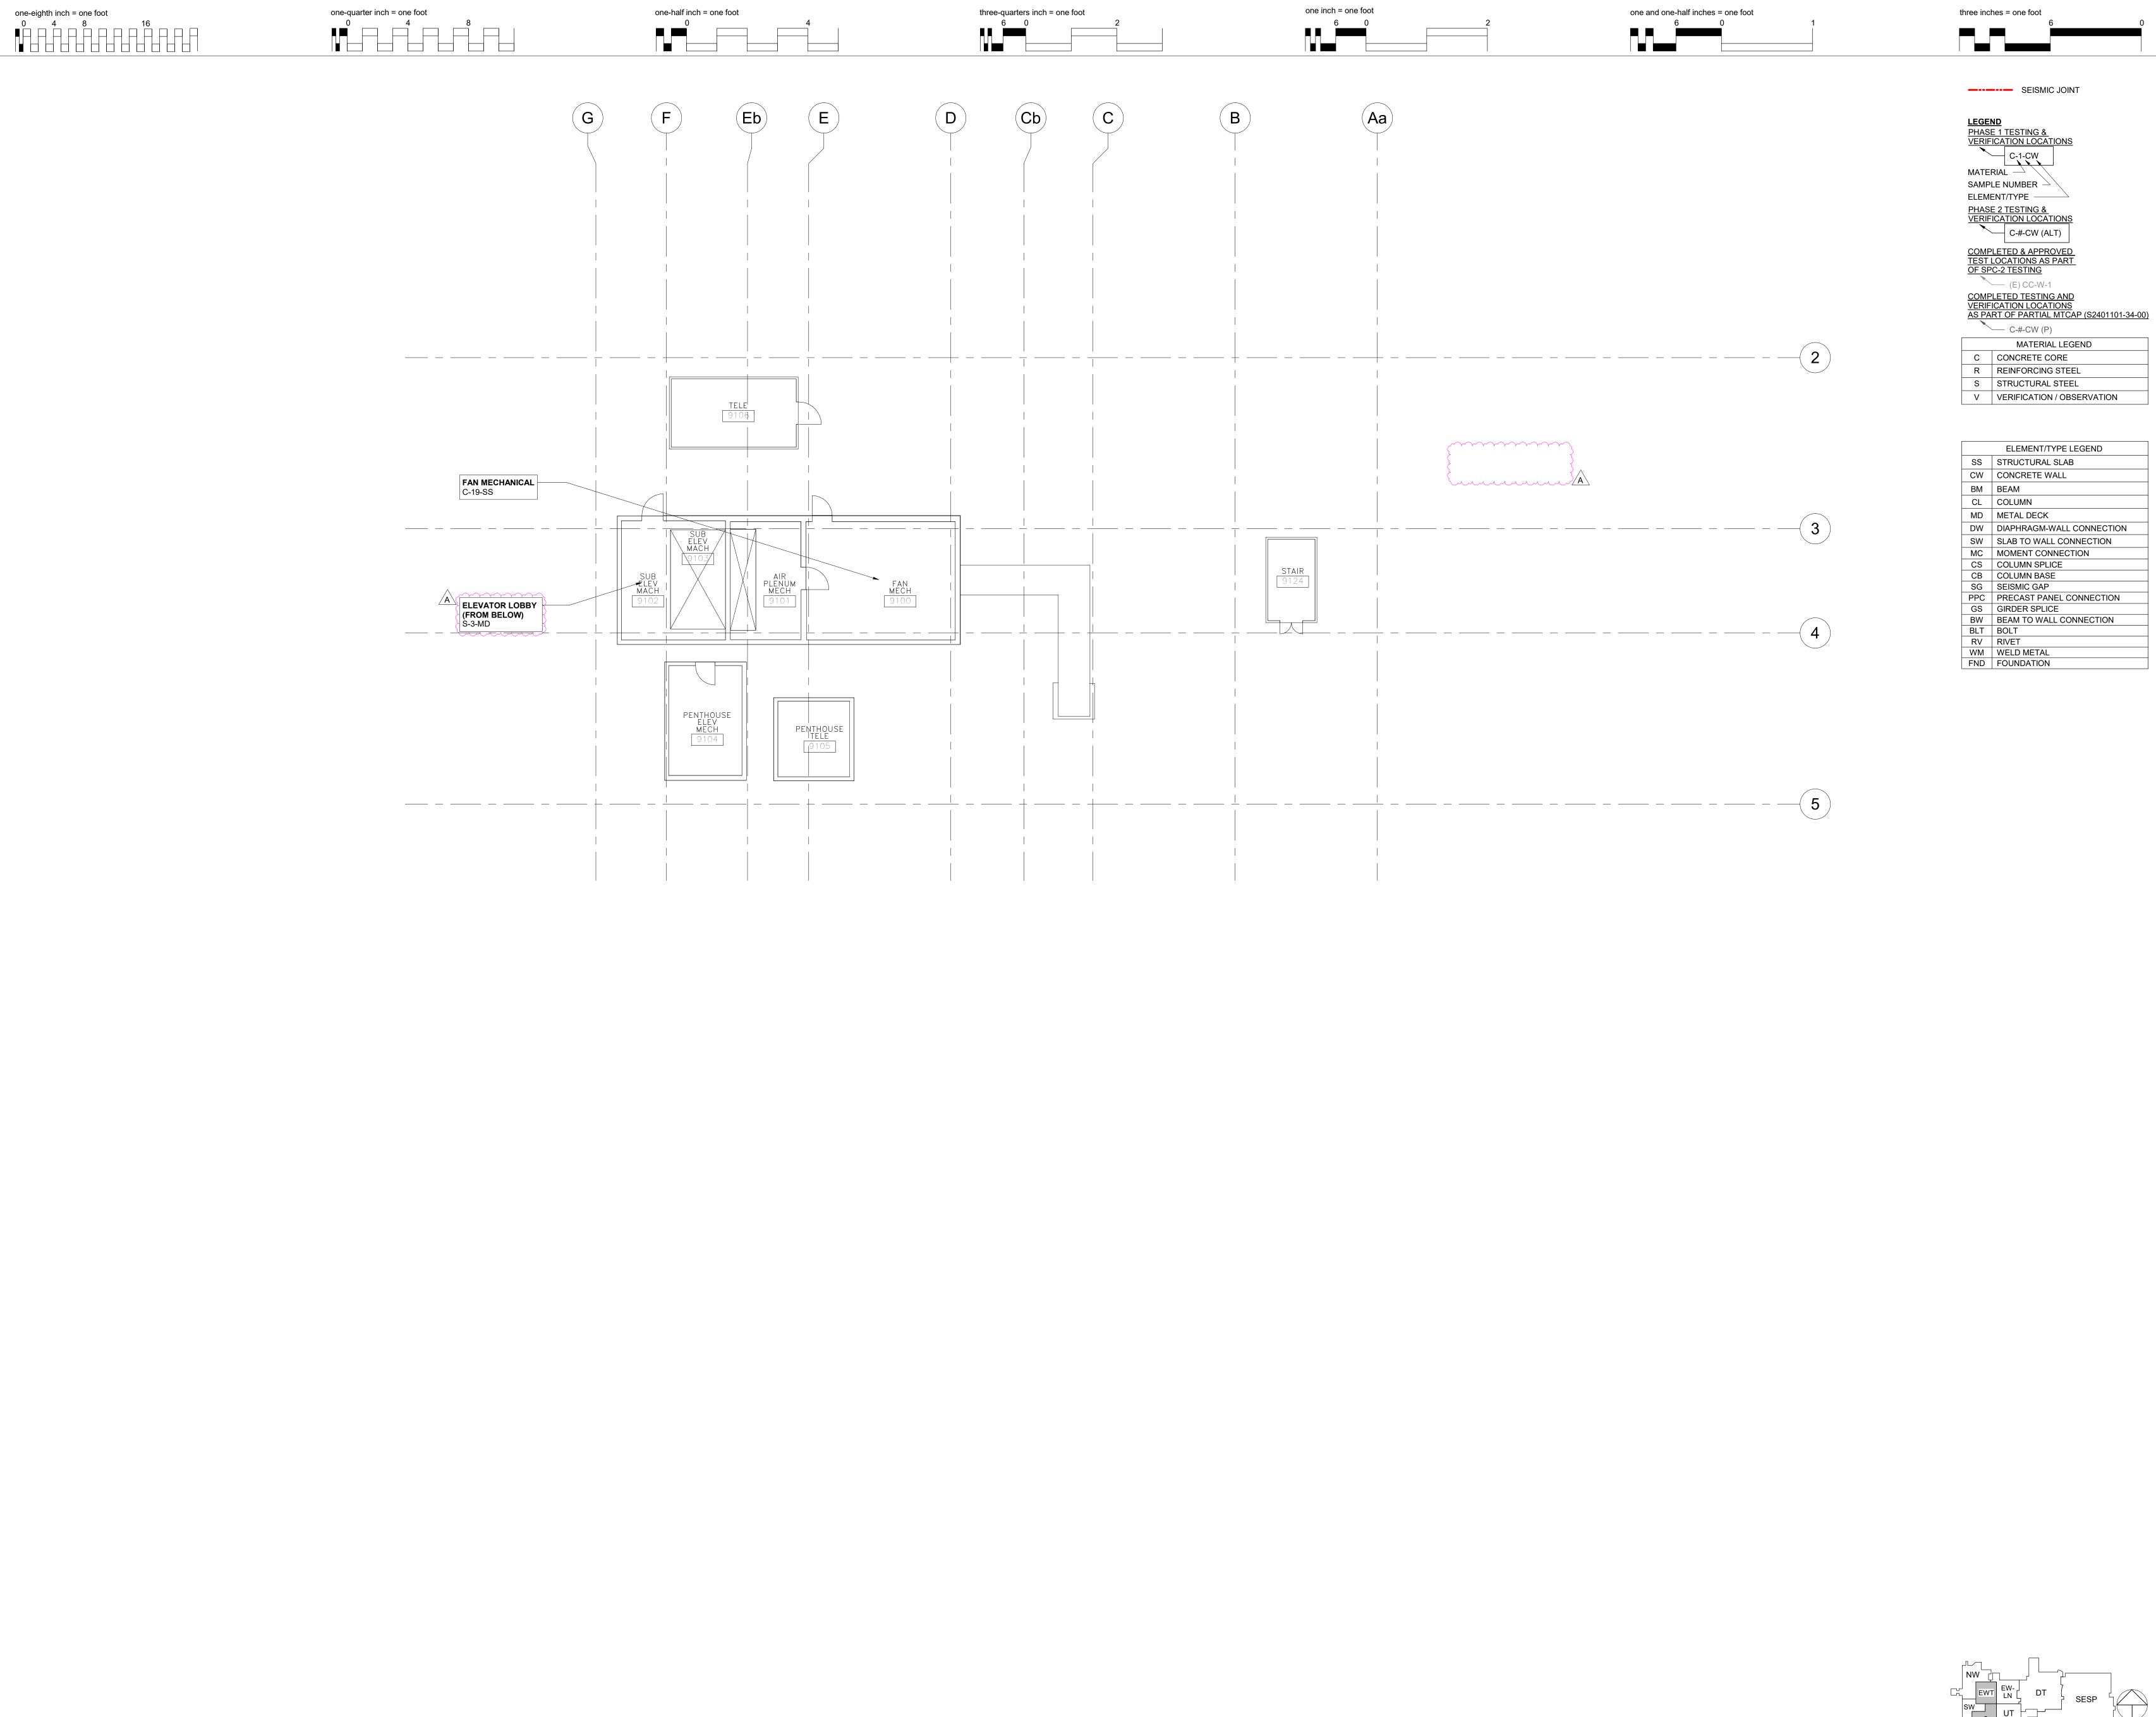


UCDH MEDICAL CENTER EAST WING TOWER & EAST WING RADIOLOGY MTCAP

Sheet Title:

9TH FLOOR PLAN

Scale:	As indicated
Job Number:	C2953022.05
Drawn by:	GG
Design by:	ASH
Checked by:	MGA
Date:	07/10/2025
Drawing Number:	



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evision		
No. A	Description HCAi Backcheck #1	<b>Date</b> 08/25/2025

AUTHORITY HAVING JURISDICTION:

AUTHORITY HAVING JURISDICTION'S PROJECT NO. S251130-34-00 FACILITY NUMBER

AGENCY APPROVALS:




UCDH MEDICAL CENTER EAST WING TOWER & EAST WING RADIOLOGY MTCAP

Sheet Title:

9TH FLOOR ARCHITECTURAL PLAN

Scale:	As indicated
Job Number:	C2953022.05
Drawn by:	GG
Design by:	ASH
Checked by:	MGA
Date:	07/10/2025
Descripe a Number	

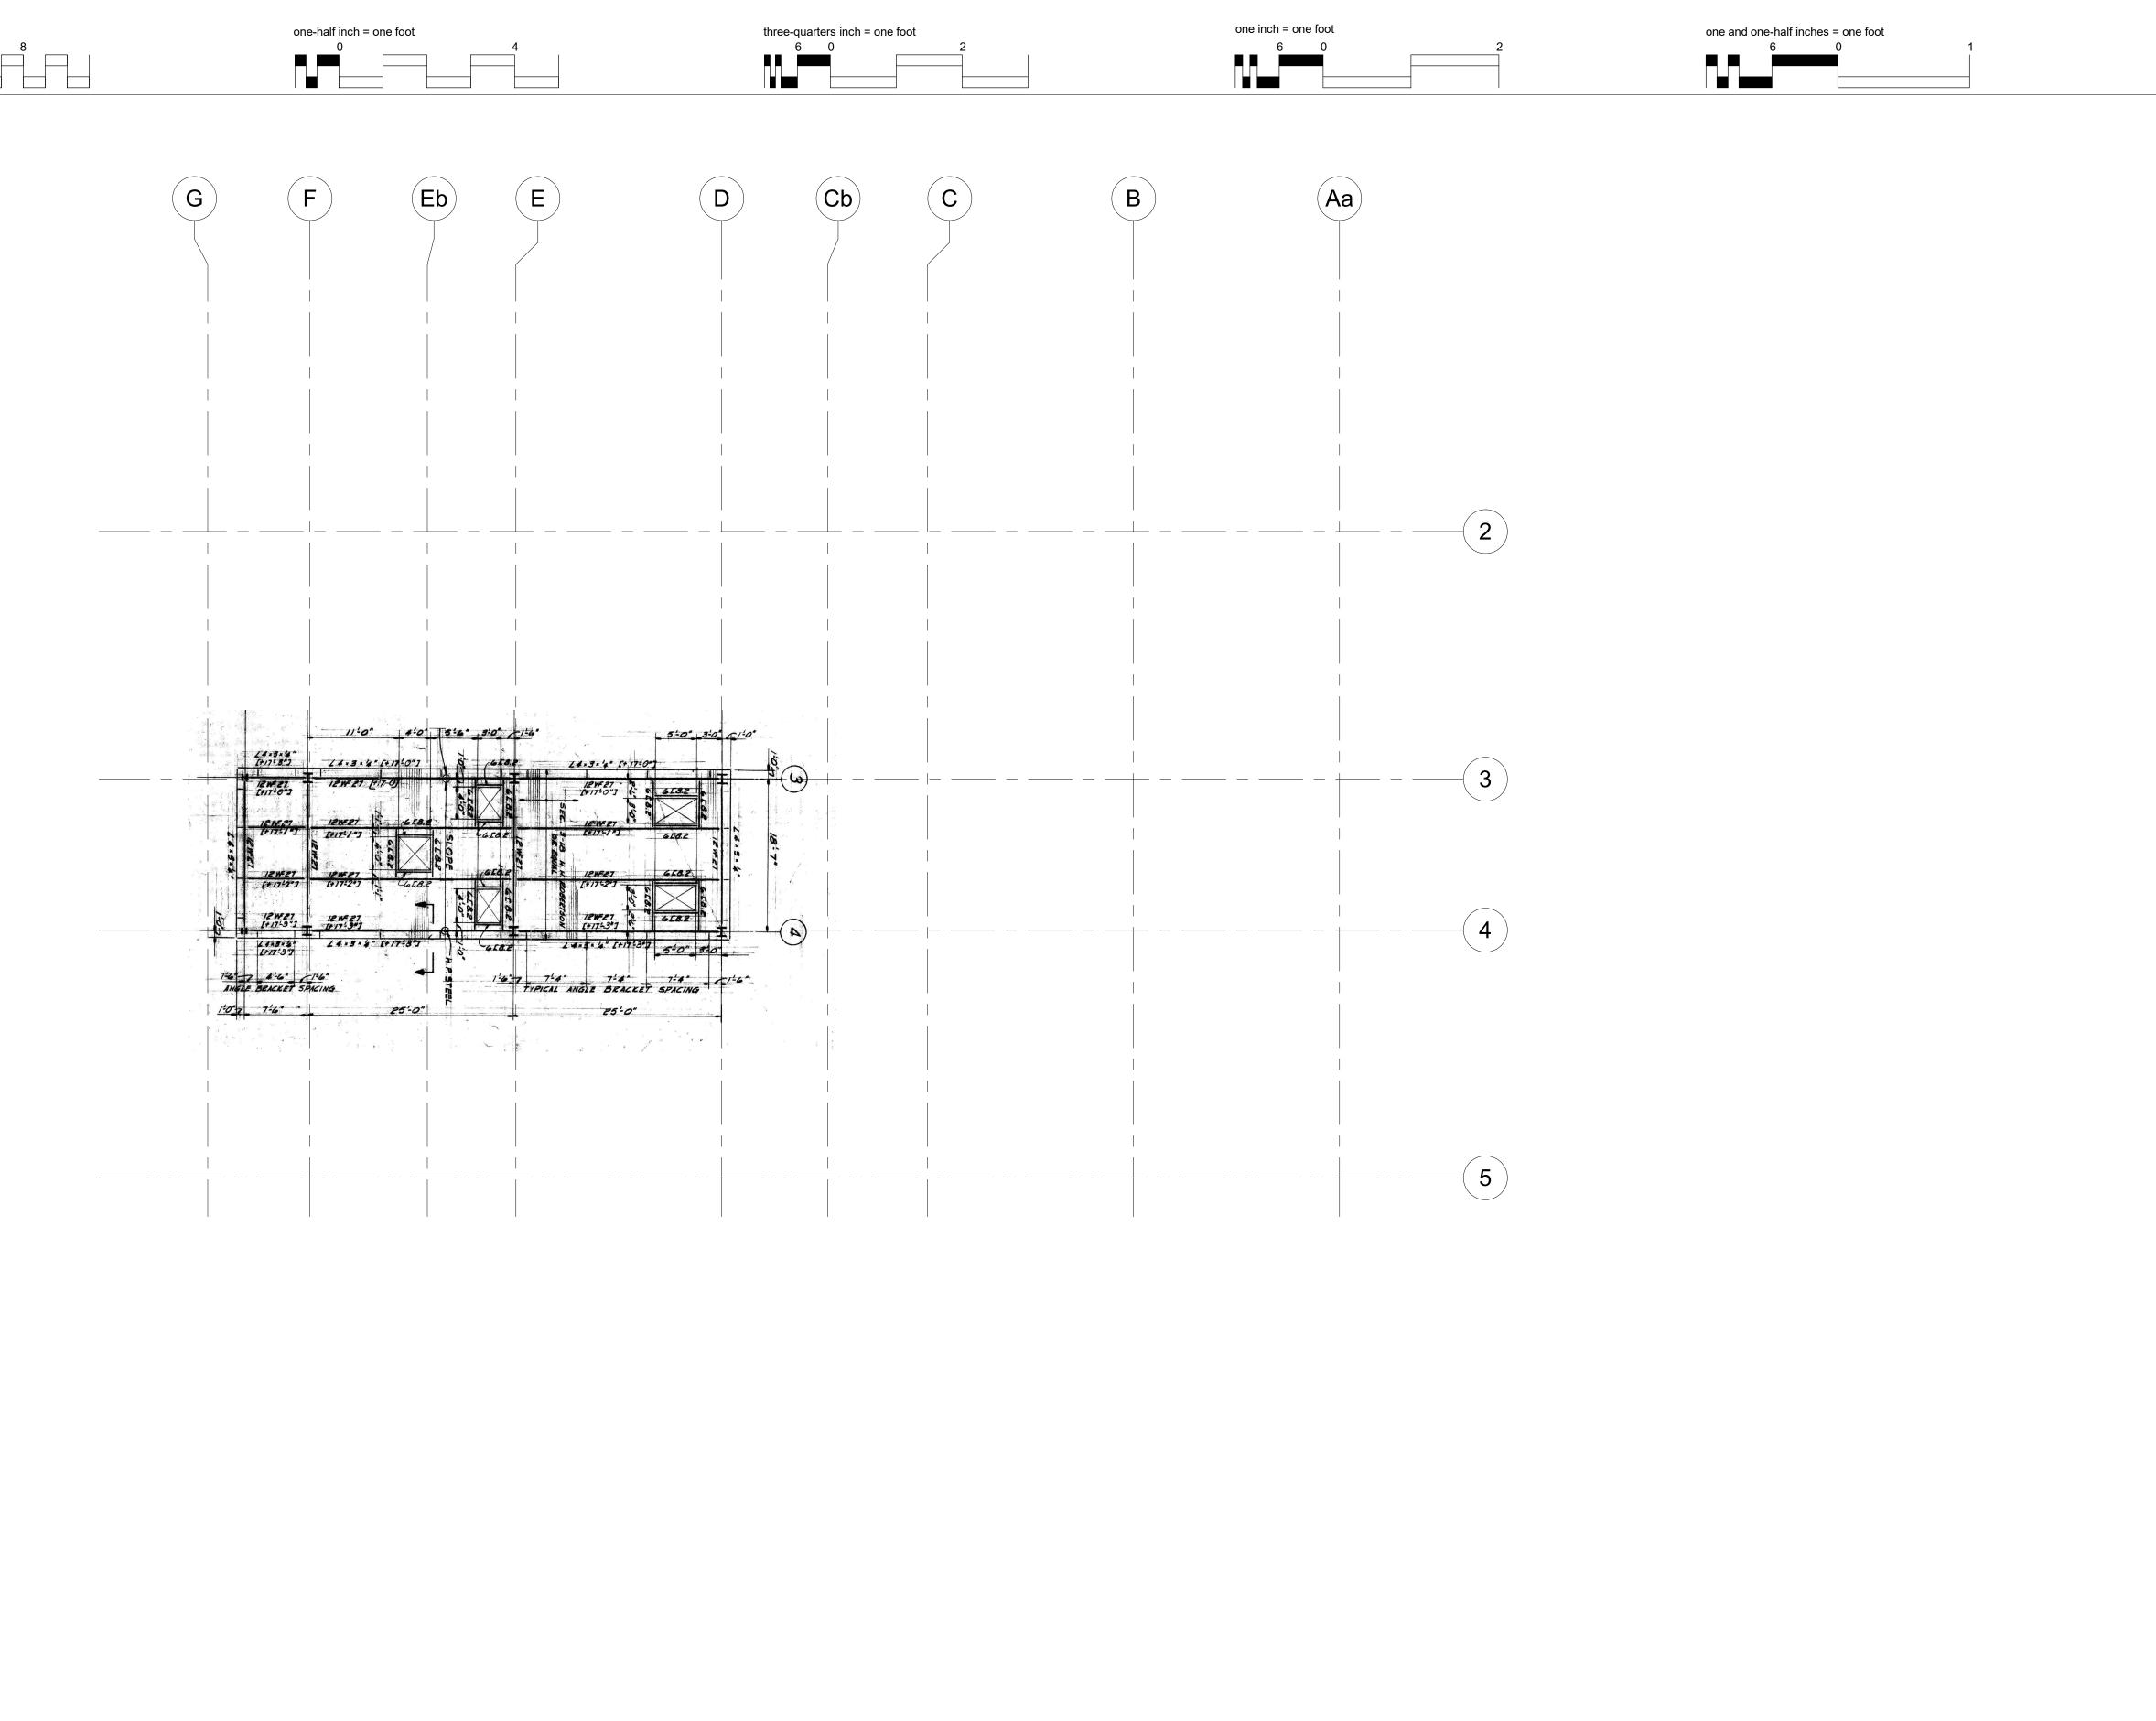

OWNER:

three inches = one foot

---- SEISMIC JOINT

LEGEND
PHASE 1 TESTING &
VERIFICATION LOCATIONS

C-1-CW

PHASE 2 TESTING & VERIFICATION LOCATIONS

C-#-CW (ALT)

COMPLETED & APPROVED TEST LOCATIONS AS PART OF SPC-2 TESTING

(E) CC-W-1

C-#-CW (P)

C | CONCRETE CORE R REINFORCING STEEL

S STRUCTURAL STEEL

SS STRUCTURAL SLAB CW CONCRETE WALL

BM BEAM

CL COLUMN

MD METAL DECK

COMPLETED TESTING AND
VERIFICATION LOCATIONS
AS PART OF PARTIAL MTCAP (S2401101-34-00)

MATERIAL LEGEND

V VERIFICATION / OBSERVATION

ELEMENT/TYPE LEGEND

DW DIAPHRAGM-WALL CONNECTION

CS COLUMN SPLICE
CB COLUMN BASE
SG SEISMIC GAP
PPC PRECAST PANEL CONNECTION
GS GIRDER SPLICE
BW BEAM TO WALL CONNECTION
BLT BOLT
RV RIVET
WM WELD METAL
FND FOUNDATION

SW SLAB TO WALL CONNECTION

MC MOMENT CONNECTION

MATERIAL — SAMPLE NUMBER -ELEMENT/TYPE ----

## HEALTH



DEGENKOLB ENGINEERS 428 J Street, Suite 500 Sacramento, CA 95814

916.418.9100 PHONE www.degenkolb.com DE Job Number: C2953022.04

SEALS AND SIGNATURES No. S 5414

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SEALS AND SIGNATURES

No.	Description	Date

AUTHORITY HAVING JURISDICTION:

AUTHORITY HAVING JURISDICTION'S PROJECT NO. S251130-34-00 FACILITY NUMBER

AGENCY APPROVALS:




UCDH MEDICAL CENTER EAST WING TOWER & EAST WING RADIOLOGY MTCAP

Sheet Title:

HIGH ROOF FLOOR PLAN

Scale:	As indicated
Job Number:	C2953022.05
Drawn by:	GG
Design by:	ASH
Checked by:	MGA
Date:	07/10/2025

one-quarter inch = one foot

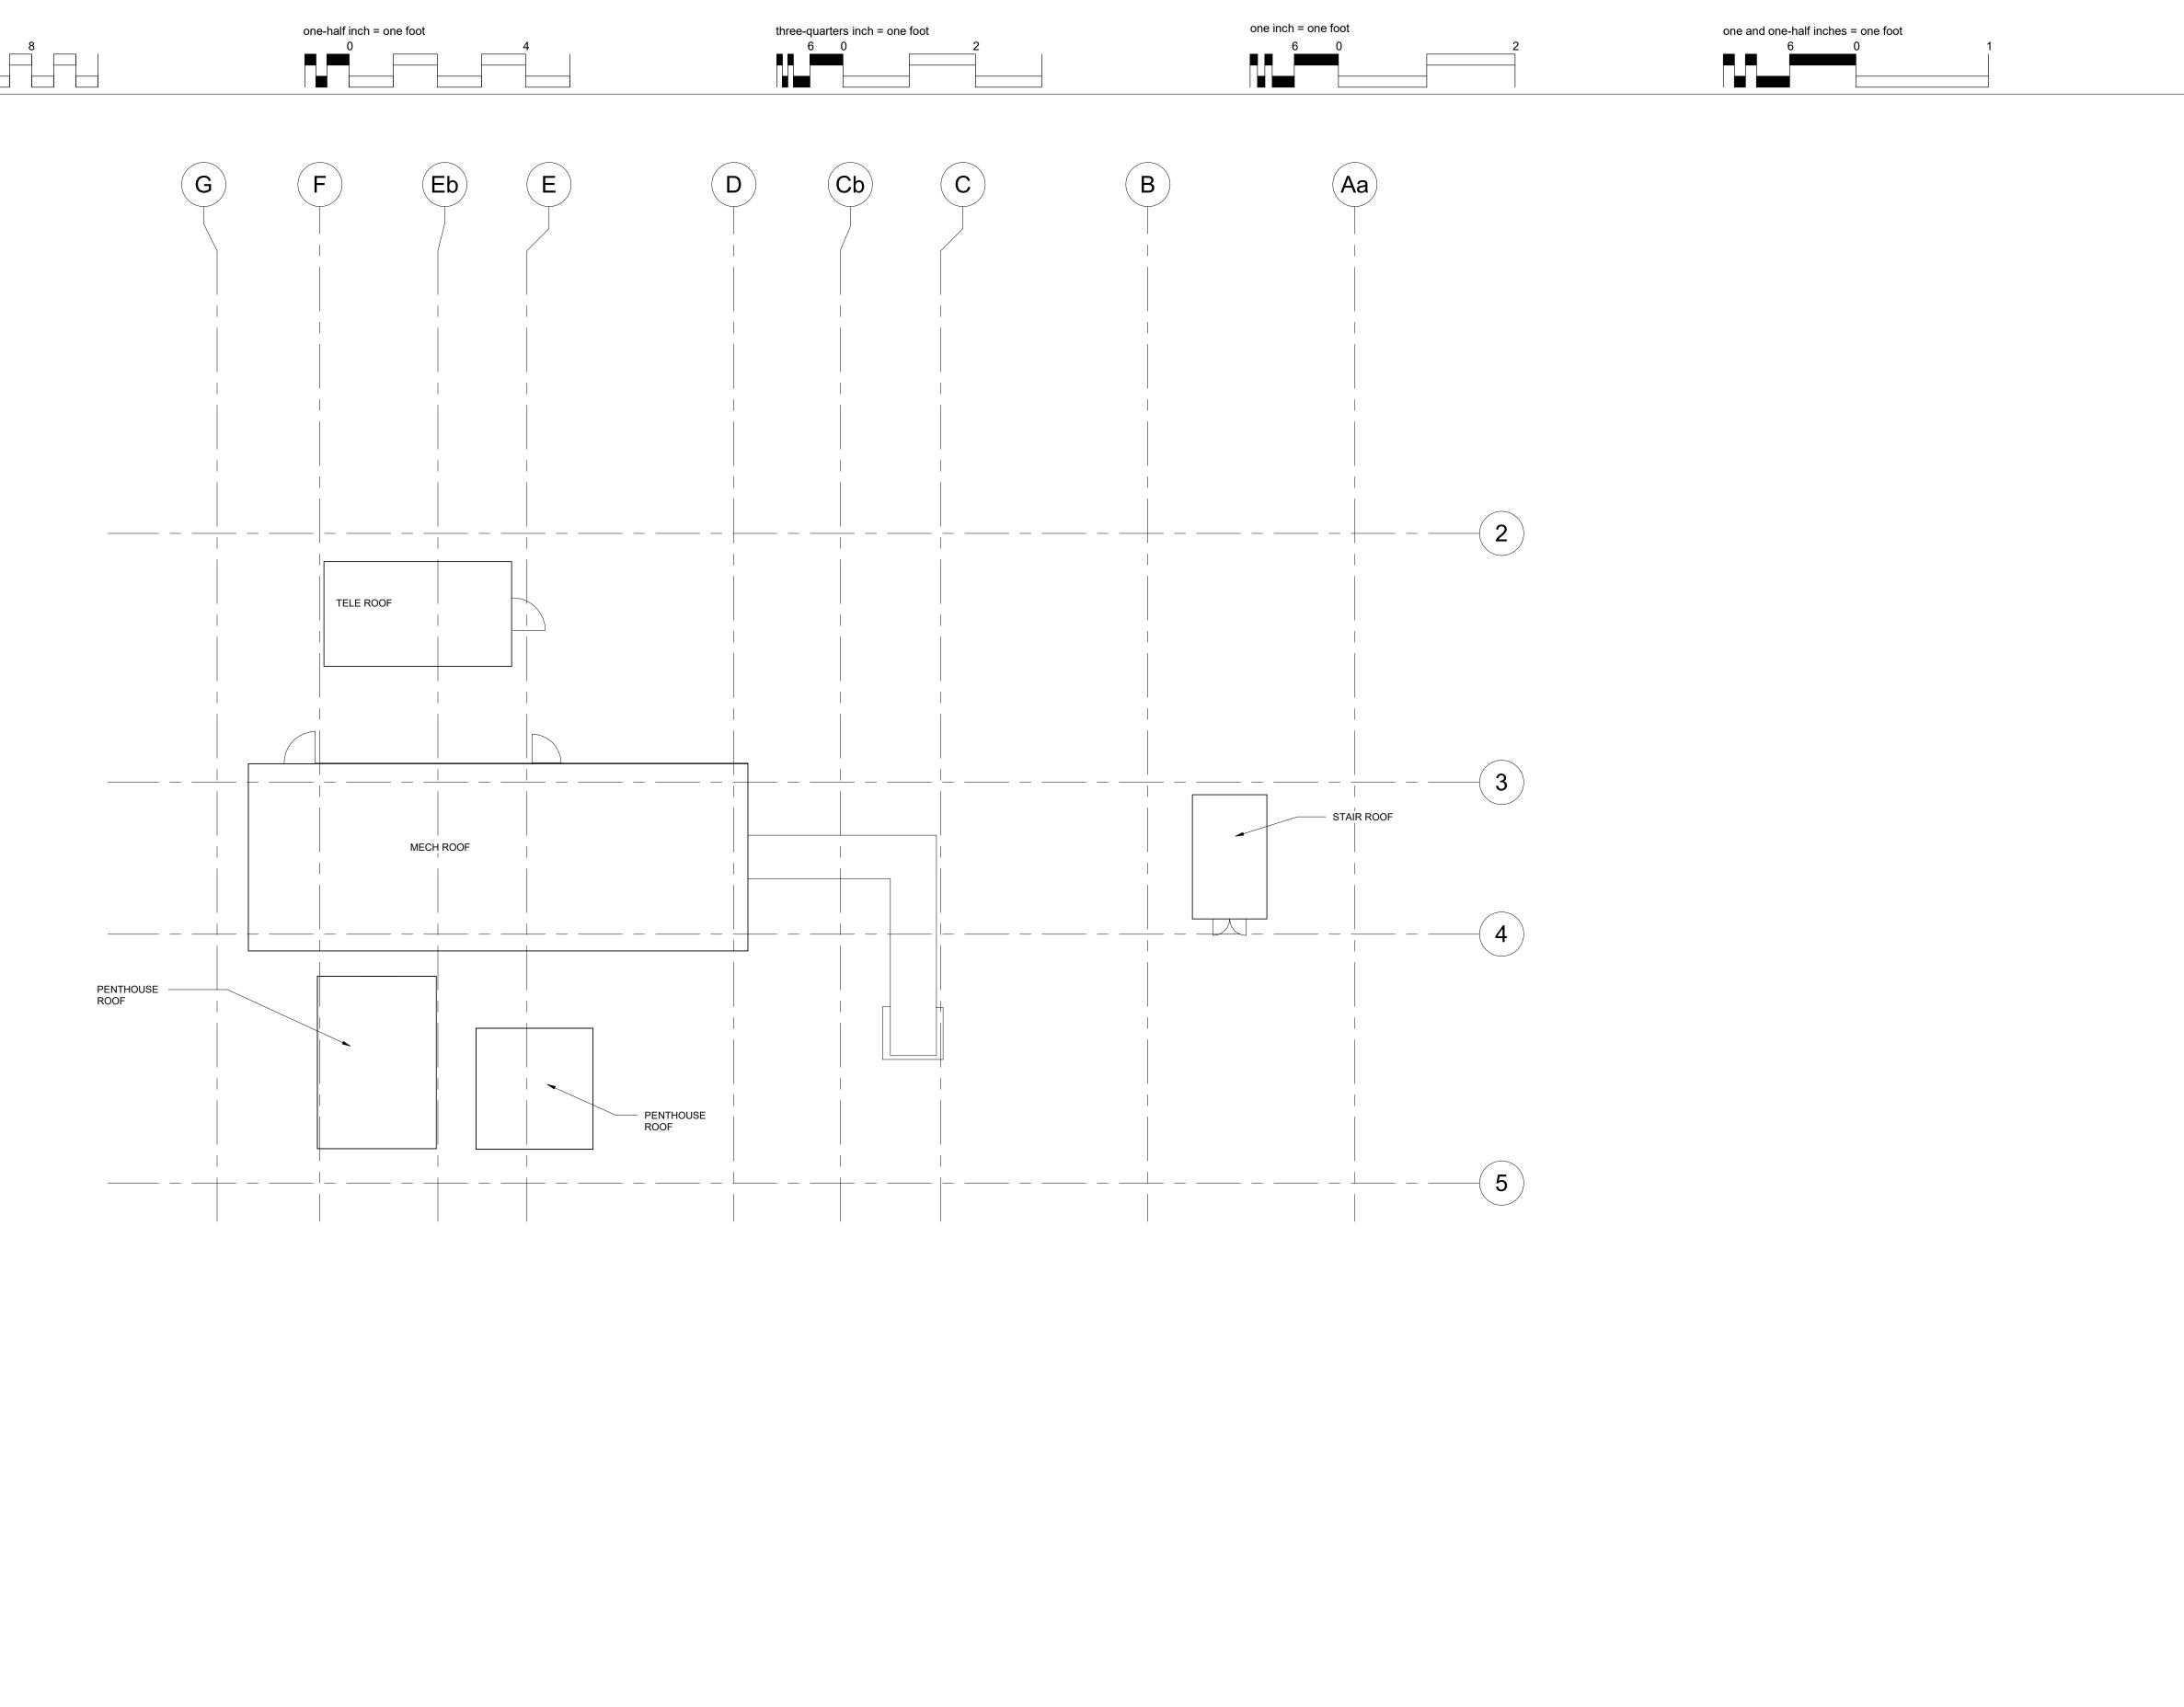

OWNER:

three inches = one foot

---- SEISMIC JOINT

LEGEND
PHASE 1 TESTING &
VERIFICATION LOCATIONS

C-1-CW

PHASE 2 TESTING & VERIFICATION LOCATIONS

C-#-CW (ALT)

COMPLETED & APPROVED TEST LOCATIONS AS PART OF SPC-2 TESTING

(E) CC-W-1

C-#-CW (P)

C | CONCRETE CORE R REINFORCING STEEL

S STRUCTURAL STEEL

SS STRUCTURAL SLAB CW CONCRETE WALL

BM BEAM

CL COLUMN

MD METAL DECK

COMPLETED TESTING AND
VERIFICATION LOCATIONS
AS PART OF PARTIAL MTCAP (S2401101-34-00)

MATERIAL LEGEND

V VERIFICATION / OBSERVATION

ELEMENT/TYPE LEGEND

DW DIAPHRAGM-WALL CONNECTION
SW SLAB TO WALL CONNECTION

CS COLUMN SPLICE
CB COLUMN BASE
SG SEISMIC GAP
PPC PRECAST PANEL CONNECTION
GS GIRDER SPLICE
BW BEAM TO WALL CONNECTION
BLT BOLT
RV RIVET
WM WELD METAL
FND FOUNDATION

MC MOMENT CONNECTION

MATERIAL — SAMPLE NUMBER -ELEMENT/TYPE ---

### HEALTH



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SEALS AND SIGNATURES

Revision Date Description

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UCDH MEDICAL CENTER EAST WING TOWER & EAST WING RADIOLOGY MTCAP

Sheet Title:

HIGH ROOF ARCHITECTURAL FLOOR PLAN

Scale:	As indicated
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one-quarter inch = one foot

